

COUNTY OF	ITEM NO.	SHEET NO.
HENRY	5-8300.00	RO01

**RIGHT OF WAY
PLANS**


Commonwealth of Kentucky DEPARTMENT OF HIGHWAYS

PLANS OF PROPOSED PROJECT HENRY COUNTY KY 146 RECONSTRUCTION - PRIORITY SEGMENT NO. 1 RIGHT OF WAY PLANS JL03 C052 8304401D



INDEX OF SHEETS	
SHEET NO.	DESCRIPTION
R001	LAYOUT SHEET
R002 - R002G	TYPICAL SECTIONS
R003 - R036	PLAN AND PROFILE SHEETS
R037 - R039	RIGHT OF WAY SUMMARY SHEETS
R040 - R048	RIGHT OF WAY STRIP MAP SHEETS
R126 - R129	COORDINATE CONTROL SHEETS
SHEETS NOT INCLUDED IN TOTAL SHEETS	
R002A - R002G, R009A	

STANDARD DRAWINGS	
NUMBER	DESCRIPTION

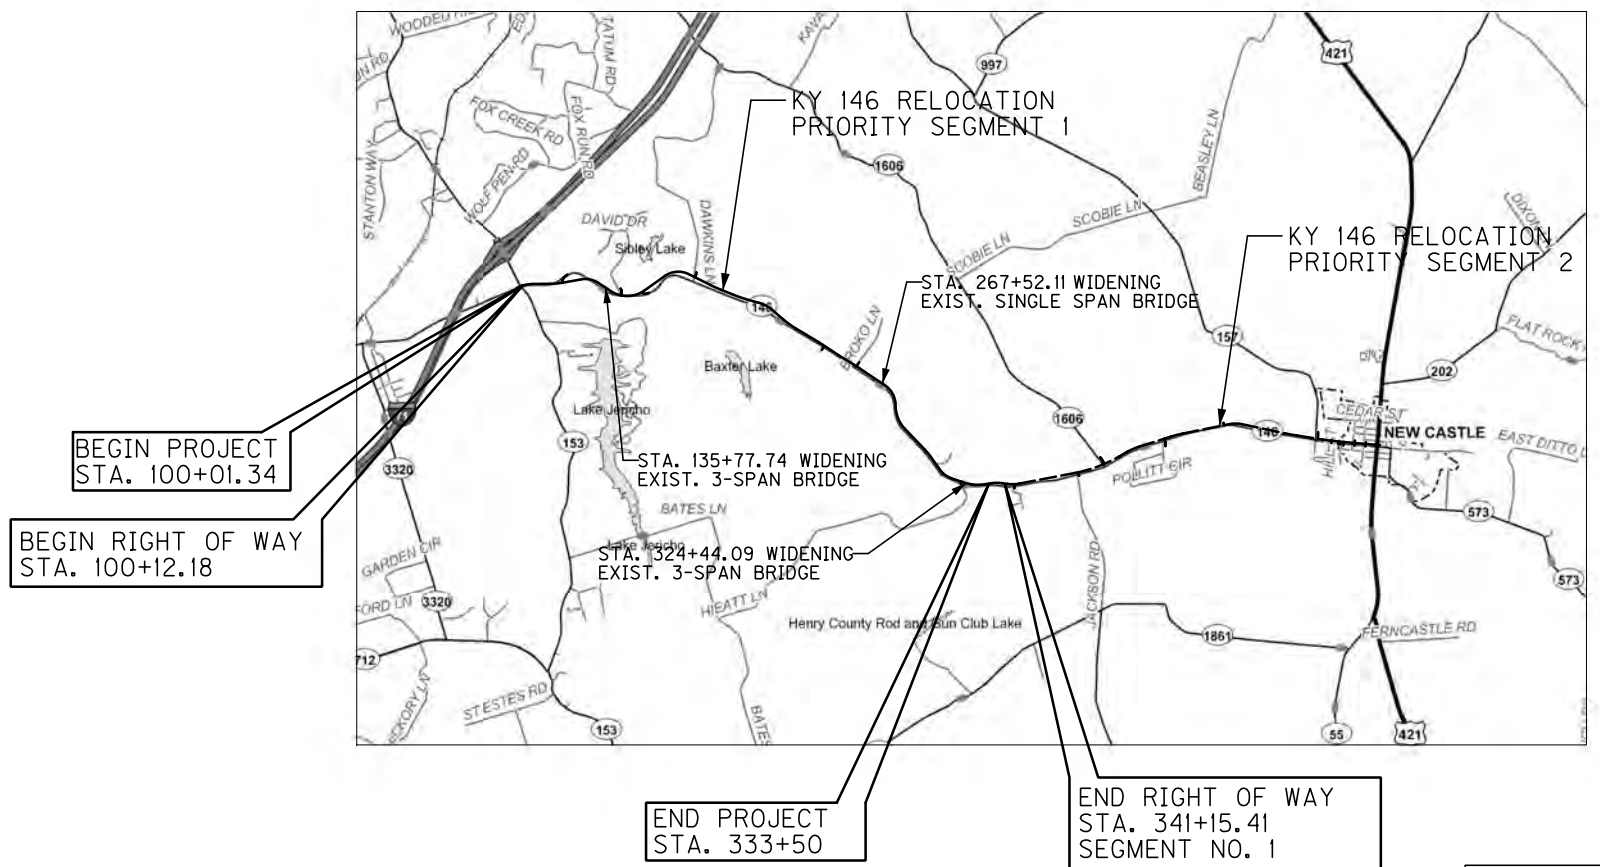

THIS ROUTE IS NOT ON THE NATIONAL HIGHWAY SYSTEM

THE CONTROL OF ACCESS ON THIS PROJECT SHALL BE BY PERMIT

END PROJECT STA. 333+50

END RIGHT OF WAY STA. 341+15.41 SEGMENT NO. 1



LAYOUT MAP

DESIGN CRITERIA	
CLASS OF HIGHWAY	RURAL COLLECTOR
TYPE OF TERRAIN	ROLLING
DESIGN SPEED	55 MPH
REQUIRED NPSD	495'
REQUIRED PSD	900'
LEVEL OF SERVICE	
ADT PRESENT (2010)	4200
ADT FUTURE (2032)	6100
DHV (2010)	440 (2032) 650
D %	
T % (2010)	9% (2032) 11%
GEOGRAPHIC COORDINATES	
LATITUDE	38 DEGREES 27 MINUTES 08 SECONDS NORTH
LONGITUDE	85 DEGREES 17 MINUTES 40 SECONDS WEST
DESIGNED	
% RESTRICTED SD	
LEVEL OF SERVICE	
MAX. DISTANCE W/O PASSING	

LENGTH	LIN. FT.	MILES	LENGTH	LIN. FT.	MILES	LENGTH	LIN. FT.	MILES	LENGTH	LIN. FT.	MILES
23,331	4,419										
ADDED	FOR EQUALITIES		ADDED	FOR EQUALITIES		ADDED	FOR EQUALITIES		ADDED	FOR EQUALITIES	
DEDUCTED	NOT INCLUDED		DEDUCTED	NOT INCLUDED		DEDUCTED	NOT INCLUDED		DEDUCTED	NOT INCLUDED	
RAILROAD CROSSINGS NO.	0		RAILROAD CROSSINGS NO.	0		RAILROAD CROSSINGS NO.	0		RAILROAD CROSSINGS NO.	0	
BRIDGES	3 EXIST. - 328.5		BRIDGES			BRIDGES			BRIDGES		

**Commonwealth of Kentucky
DEPARTMENT OF HIGHWAYS
COUNTY OF**

HENRY

KY 146 RELOCATION

ITEM NO. 5-8300.00

PROJECT NUMBER: JL03 C052 8304401D

LETTING DATE: _____

RECOMMENDED BY: _____ PROJECT MANAGER DATE: _____

PLAN APPROVED BY: _____ STATE HIGHWAY ENGINEER DATE: _____

PLANS PREPARED AND SUBMITTED BY:

GRW Engineers, Inc.

FILE NAME: I:\3886-KY 146 HENRY-PHASE 2\SEGMENT 1\SHEETS\LAYOUT\RO01001S-RW.DGN
 USER: TRobinson
 DATE PLOTTED: December 8, 2014
 E-SHEET NAME:
 MicroStation v8.11.7.443

THIS IS A HALF SIZE SET OF PLANS

FILE NAME: I:\3886-KY 146 HENRY\PHASE 2\SEGMENT 1\SHEETS\TYPICAL SECTIONS\RO0200TS.DGN
 USER: sgr/ice
 DATE PLOTTED: December 8, 2014
 E-SHEET NAME:
 MicroStation v8.11.7.443

TYPICAL SECTIONS

KY 146 RELOCATION


2 - LANE RURAL

**RIGHT OF WAY
PLANS**


COUNTY OF	ITEM NO.	SHEET NO.
HENRY	5-8300.00	RO02

NOTES


- SEE CROSS SECTIONS FOR SLOPES OUTSIDE THE LIMITS OF THE SHOULDERS.
- SUPERELEVATED SHOULDER TO BE CONSTRUCTED TO SUPERELEVATION RATE. AT NO TIME WILL THE SLOPE BE FLATTER THAN THE SLOPE INDICATED FOR NORMAL SECTION.
- REFILL MATERIAL TO CONFORM TO APPLICABLE SECTIONS OF THE CURRENT EDITION OF KENTUCKY STANDARD SPECIFICATIONS FOR ROAD AND BRIDGE CONSTRUCTION.
- ASPHALT SEAL REQUIRED FROM OUTSIDE EDGE OF PAVED SHOULDER TO A POINT 2' DOWN THE DITCH OR FILL SLOPE.
 ASPHALT SEAL COAT (2 APPLICATIONS) — ASPHALT SEAL COAT @ 2.40 LBS./S.Y. BITUMINOUS SEAL AGGREGATE @ 20 LBS./S.Y. (CRUSHED AGGREGATE SIZE NO.8 OR 9M)
- SHOULDERS SHALL BE WIDENED 3' WHERE GUARDRAIL IS TO BE INSTALLED.
- SEE PLANS FOR CHANNEL LINING REQUIREMENTS. UNLESS OTHERWISE DIRECTED ALL DITCHES NOT RECEIVING RIPRAP CHANNEL LINING SHALL BE LINED WITH EROSION CONTROL BLANKET WITH A MINIMUM DEPTH TO PROTECT OF ONE-AND-A-HALF (1.5) FEET.
- PAVEMENT SHOULD BE EXTENDED TO FACE OF GUARDRAIL.

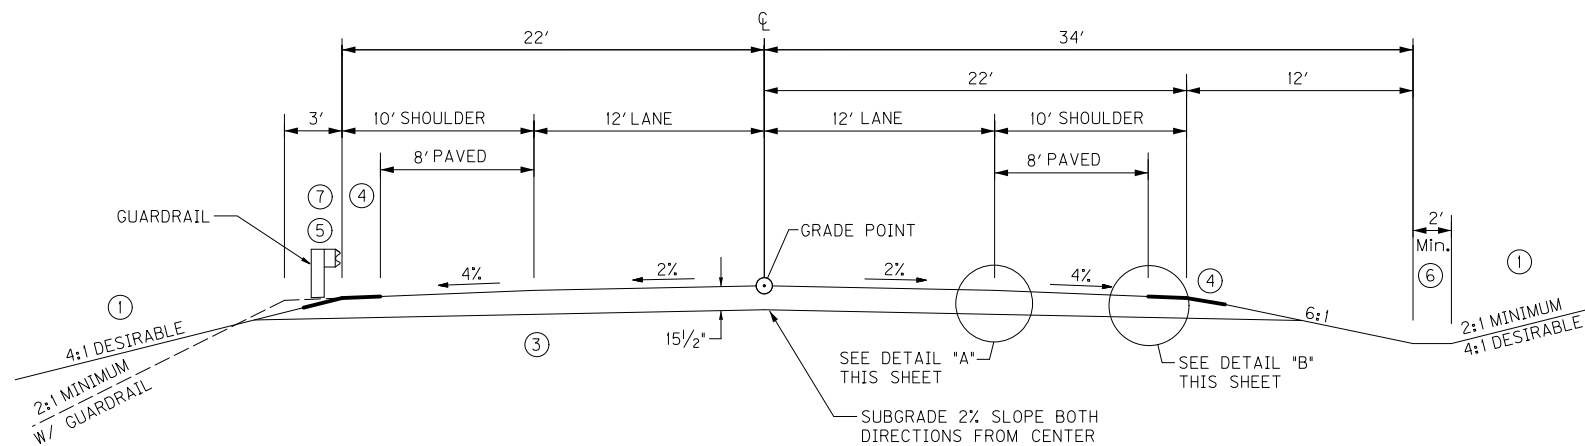

NORMAL RURAL FILL /CUT SECTION

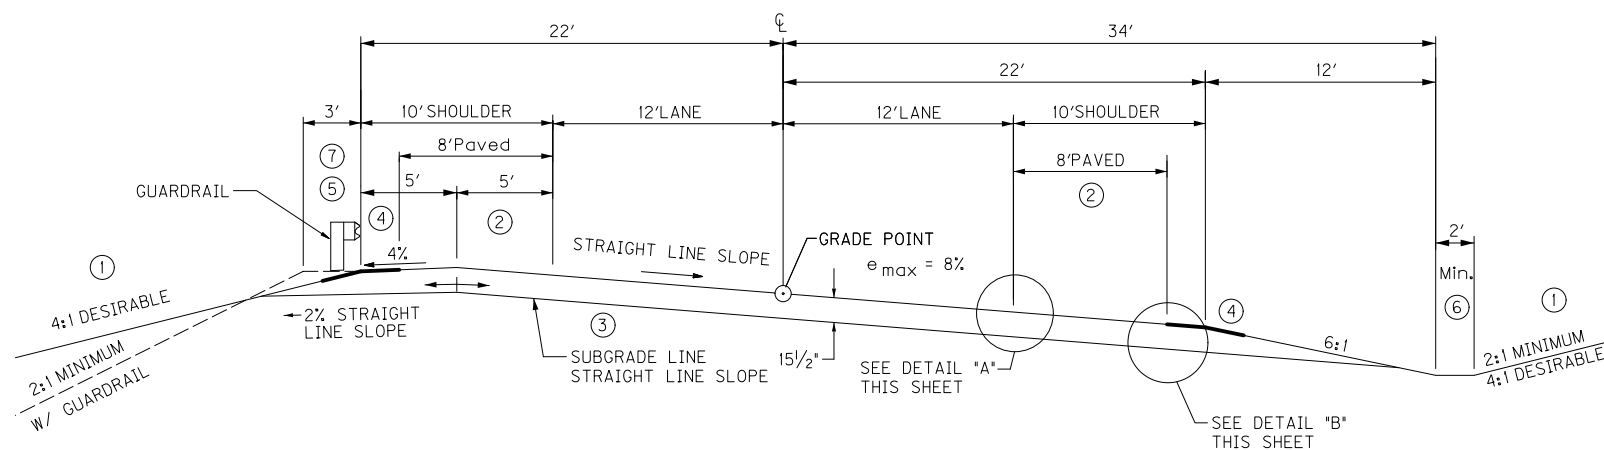


SUPERELEVATION RURAL FILL /CUT SECTION

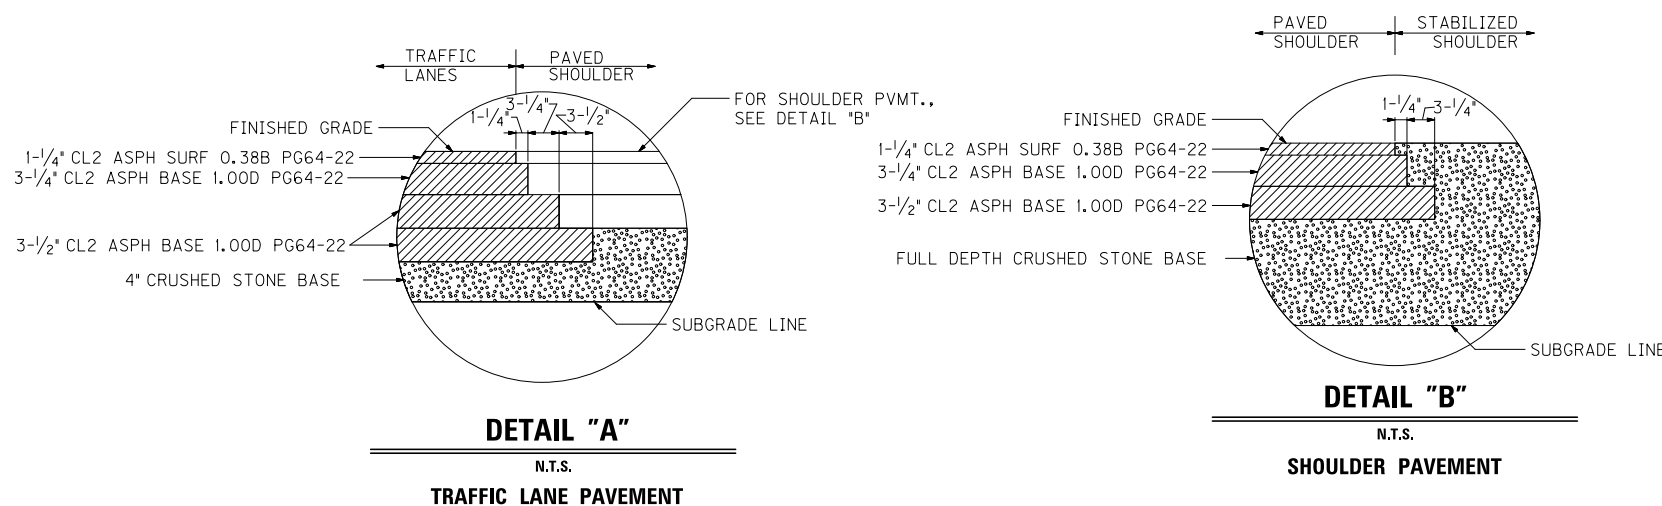

PAVEMENT SCHEDULE	
TRAFFIC LANES	
CRUSHED STONE BASE	4" DEPTH
CL 2 ASPH BASE 1.00D PG64-22	10-1/4" DEPTH
CL 2 ASPH SURF 0.38B PG 64-22	1-1/4" DEPTH
SHOULDERS	
CRUSHED STONE BASE	FULL DEPTH
CL 2 ASPH BASE 1.00D PG64-22	6-3/4" DEPTH
CL 2 ASPH SURF 0.38B PG64-22	1-1/4" DEPTH

NOTE:
 PAVEMENT DESIGN SHOWN IS FOR ESTIMATING PURPOSES ONLY. THE PAVEMENT DESIGN WILL BE FINALIZED BASED ON THE RESULTS OF THE GEOTECHNICAL INVESTIGATION.

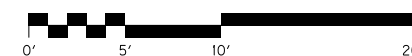

SCALE: 1"= 5'

MAINLINE
 RURAL TYPICAL SECTIONS
 KY 146 RELOCATION

COUNTY OF	ITEM NO.	SHEET NO.
HENRY	5-8300.00	R002A

**RIGHT OF WAY
PLANS**


TYPICAL SECTIONS

KY 146 RELOCATION


2 - LANE RURAL ROCK

NOTES


- ① SEE CROSS SECTIONS FOR SLOPES OUTSIDE THE LIMITS OF THE SHOULDERS.
 - ② SUPERELEVATED SHOULDER TO BE CONSTRUCTED TO SUPERELEVATION RATE. AT NO TIME WILL THE SLOPE BE FLATTER THAN THE SLOPE INDICATED FOR NORMAL SECTION.
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NORMAL RURAL ROCK CUT SECTION

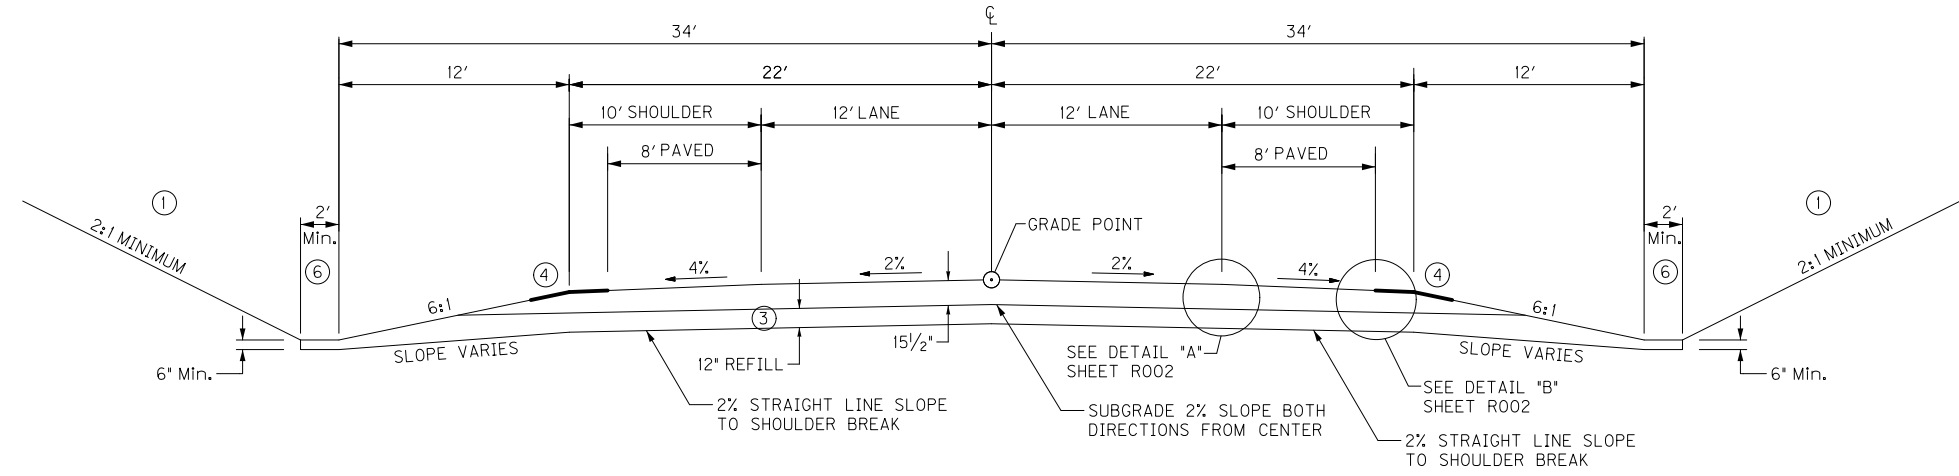

SUPERELEVATION RURAL ROCK CUT SECTION

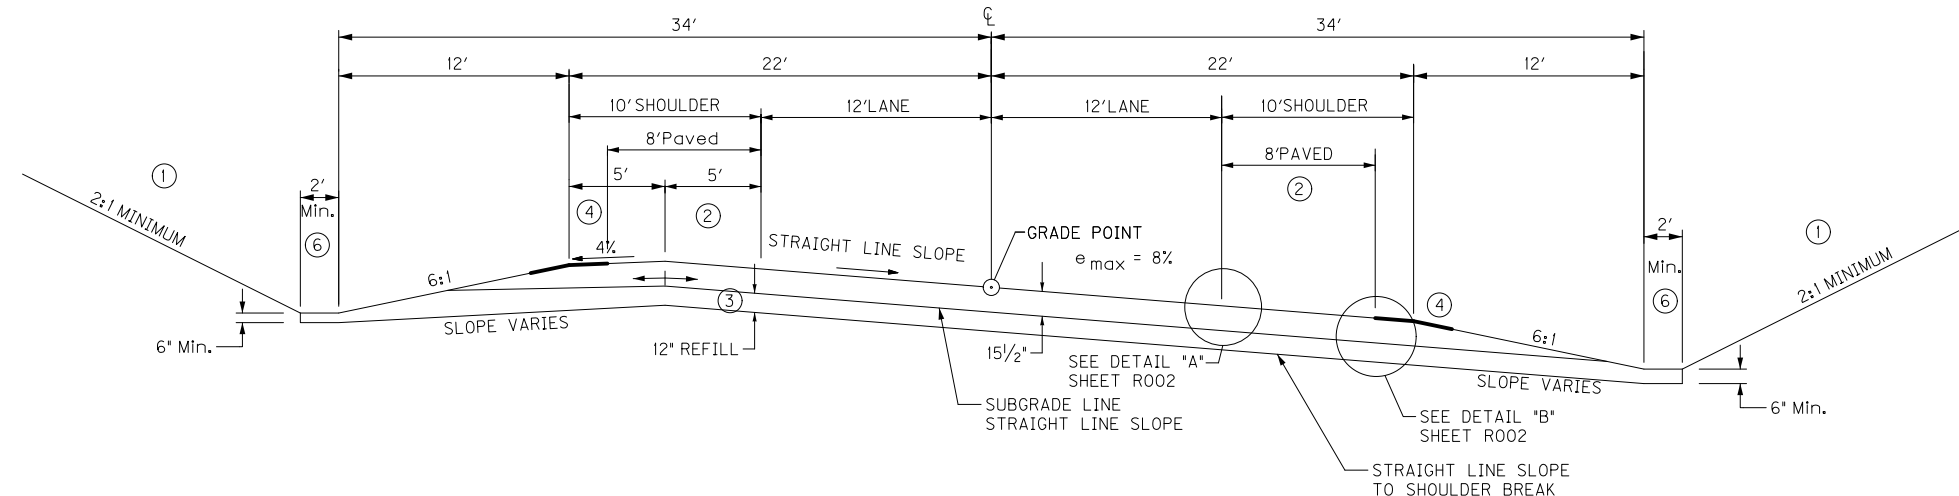

SCALE: 1" = 5'
MAINLINE
RURAL ROCK CUT TYPICAL SECTIONS
KY 146 RELOCATION

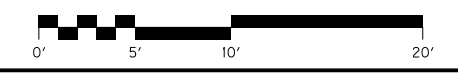FILE NAME: I:\3886-KY 146 HENRY\PHASE 2\SEGMENT 1\SHEETS\TYPICAL SECTIONS\R002A\T.S.DGN
 USER: TRobinson
 DATE PLOTTED: December 8, 2014
 E-SHEET NAME:
 MicroStation v8.11.7.443


COUNTY OF	ITEM NO.	SHEET NO.
HENRY	5-8300.00	RO02B

RIGHT OF WAY PLANS

TYPICAL SECTIONS


KY 146 RELOCATION

2 - LANE RURAL W/FARM VEHICLE LANE

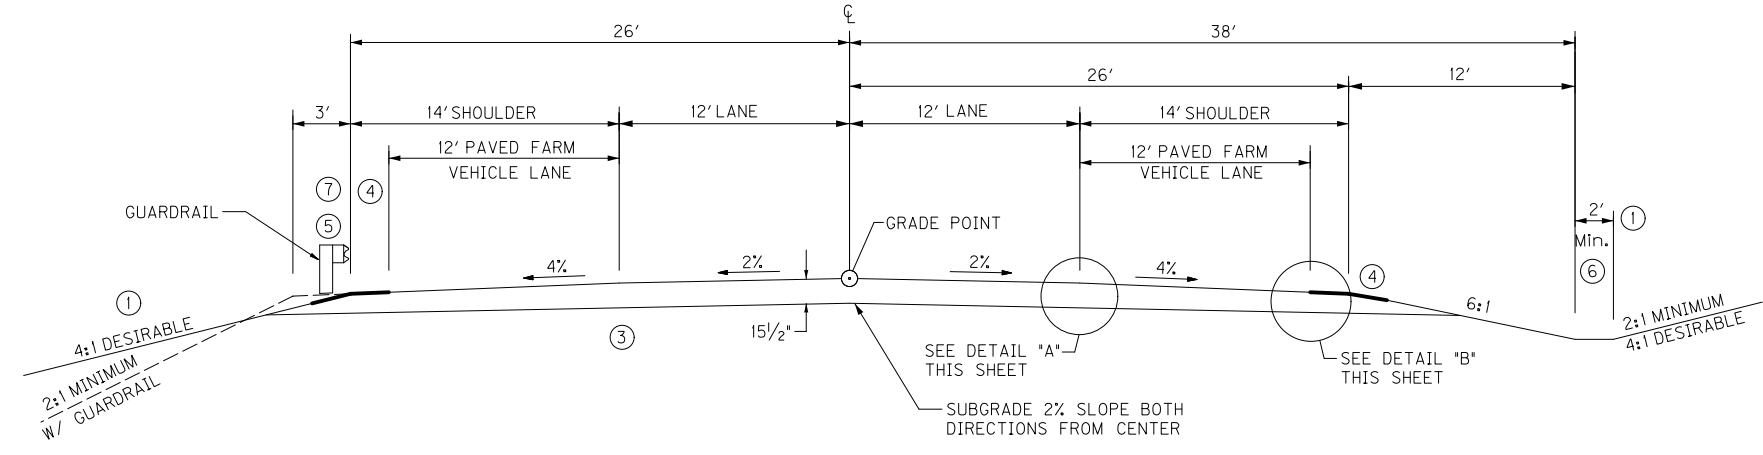


FARM VEHICLE LANE FILL /CUT SECTION

STA. 156 + 50.00 TO STA. 162 + 80.00
 STA. 241 + 70.00 TO STA. 248 + 00.00

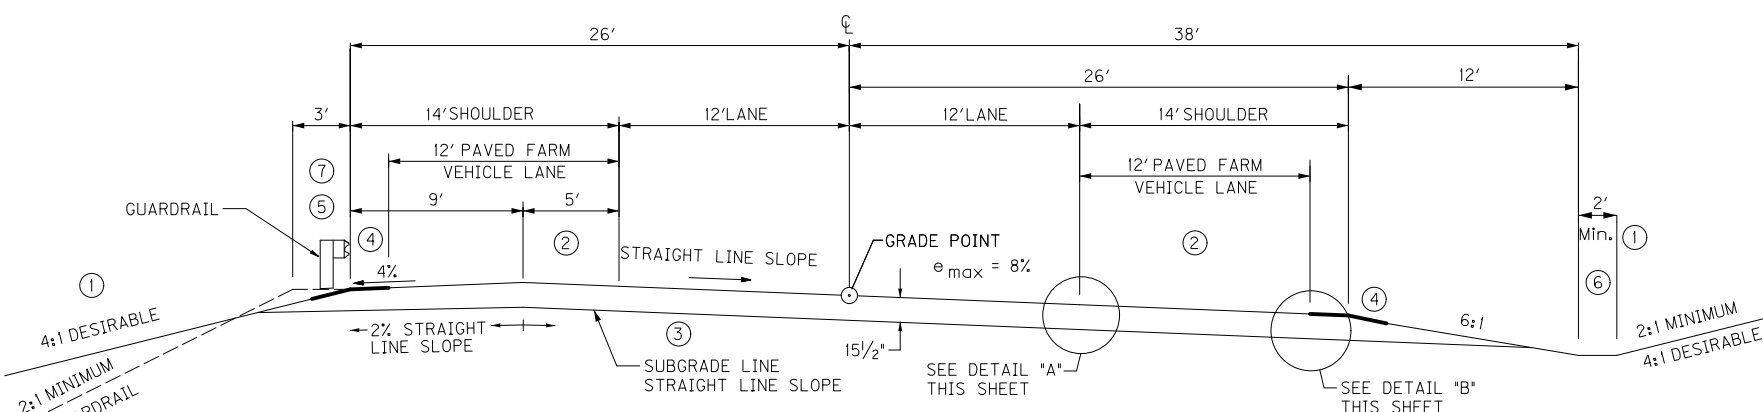

SUPERELEVATION FARM VEHICLE LANE FILL /CUT SECTION

STA. 156 + 50.00 TO STA. 162 + 80.00
 STA. 241 + 70.00 TO STA. 248 + 00.00

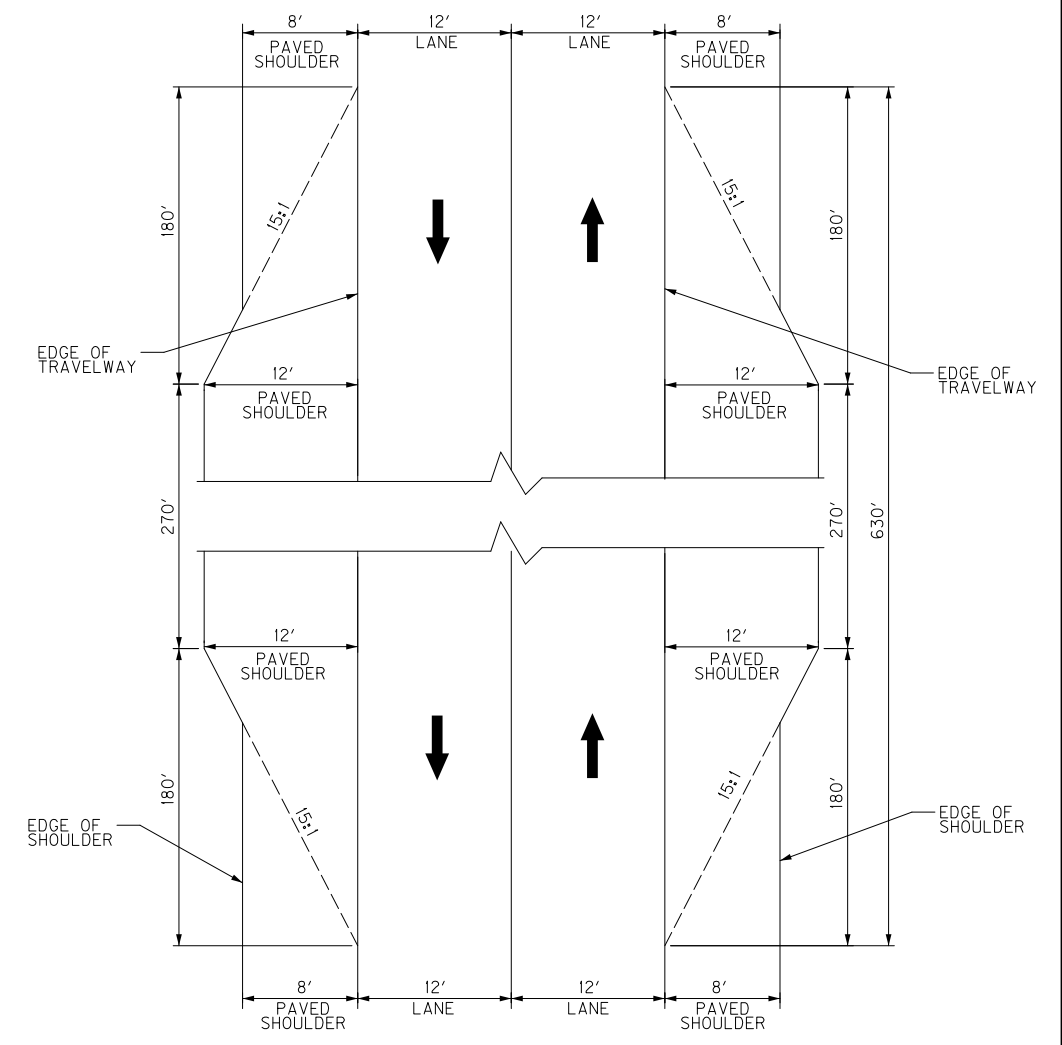

FARM VEHICLE LANE PLAN VIEW


N.T.S.

NOTES

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- PAVEMENT SHOULD BE EXTENDED TO FACE OF GUARDRAIL.


PAVEMENT SCHEDULE	
TRAFFIC LANES	
CRUSHED STONE BASE	4" DEPTH
CL 2 ASPH BASE 1.00D PG64-22	10-1/4" DEPTH
CL 2 ASPH SURF 0.38B PG 64-22	1-1/4" DEPTH
SHOULDERS	
CRUSHED STONE BASE	FULL DEPTH
CL 2 ASPH BASE 1.00D PG64-22	6-3/4" DEPTH
CL 2 ASPH SURF 0.38B PG64-22	1-1/4" DEPTH

NOTE:
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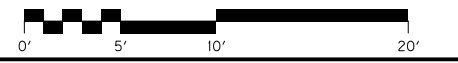
DETAIL "A"

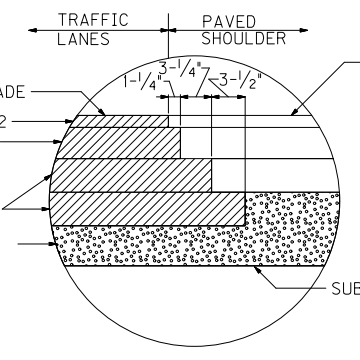N.T.S.
 TRAFFIC LANE PAVEMENT



DETAIL "B"

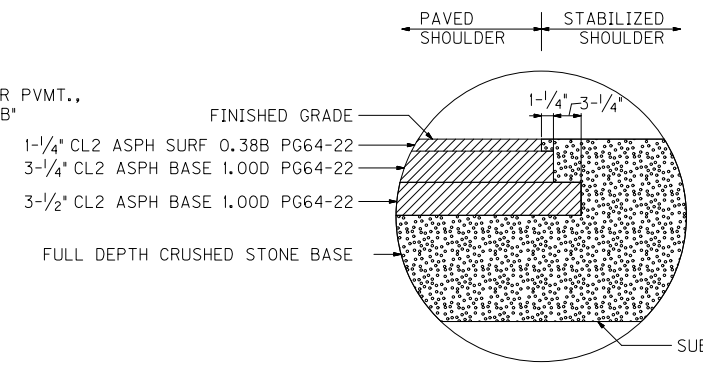N.T.S.
 SHOULDER PAVEMENT



SCALE: 1" = 5'

MAINLINE
 FARM VEHICLE LANE TYPICAL SECTIONS
 KY 146 RELOCATION

FILE NAME: I:\3886-KY 146 HENRY\PHASE 2\SEGMENT 1\SECTIONS\RO02B\T.S.DGN
 USER: TRobinson
 DATE PLOTTED: December 8, 2014
 E-SHEET NAME:
 MicroStation v8.11.7.443

TYPICAL SECTIONS

KY 146 RELOCATION

2 - LANE RURAL WIDENING/OVERLAY


**RIGHT OF WAY
PLANS**

COUNTY OF	ITEM NO.	SHEET NO.
HENRY	5-8300.00	RO02C


NOTES

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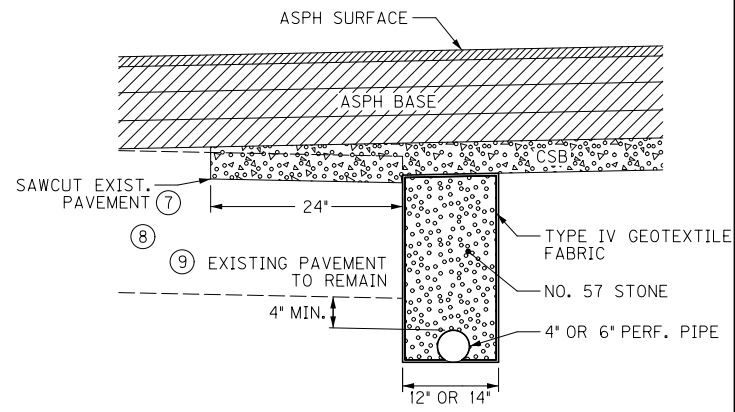
 ASPHALT SEAL COAT — ASPHALT SEAL COAT @ 2.40 LBS./S.Y. (2 APPLICATIONS)
 BITUMINOUS SEAL AGGREGATE @ 20 LBS./S.Y. (CRUSHED AGGREGATE SIZE NO.8 OR 9M)
- ⑤ SHOULDERS SHALL BE WIDENED 3' WHERE GUARDRAIL IS TO BE INSTALLED.
- ⑥ SEE PLANS FOR RIPRAP CHANNEL LINING REQUIREMENTS. UNLESS OTHERWISE DIRECTED ALL DITCHES NOT RECEIVING RIPRAP CHANNEL LINING SHALL BE LINED WITH EROSION CONTROL BLANKET WITH A MINIMUM DEPTH TO PROTECT OF ONE-AND-A-HALF (1.5) FEET.
- ⑦ LONGITUDINAL SAWCUT SHALL BE CONSIDERED INCIDENTAL TO CONSTRUCTION OF THE ASPHALT CONCRETE.
- ⑧ SCARIFYING, LEVELING AND WEDGING WILL BE REQUIRED TO ACCOMMODATE EXISTING PAVEMENT.
- ⑨ THE EXISTING PAVEMENT BLOCK IS AS FOLLOWS: CSB - 6 INCHES AND TOTAL ASPHALT - 11 3/4 INCHES. THE NEW CSB BASE IN THE WIDENING PORTION SHOULD EXTEND TO THE BOTTOM OF THE EXISTING CSB TO PROVIDE POSITIVE DRAINAGE.
- ⑩ PAVEMENT SHOULD BE EXTENDED TO FACE OF GUARDRAIL.

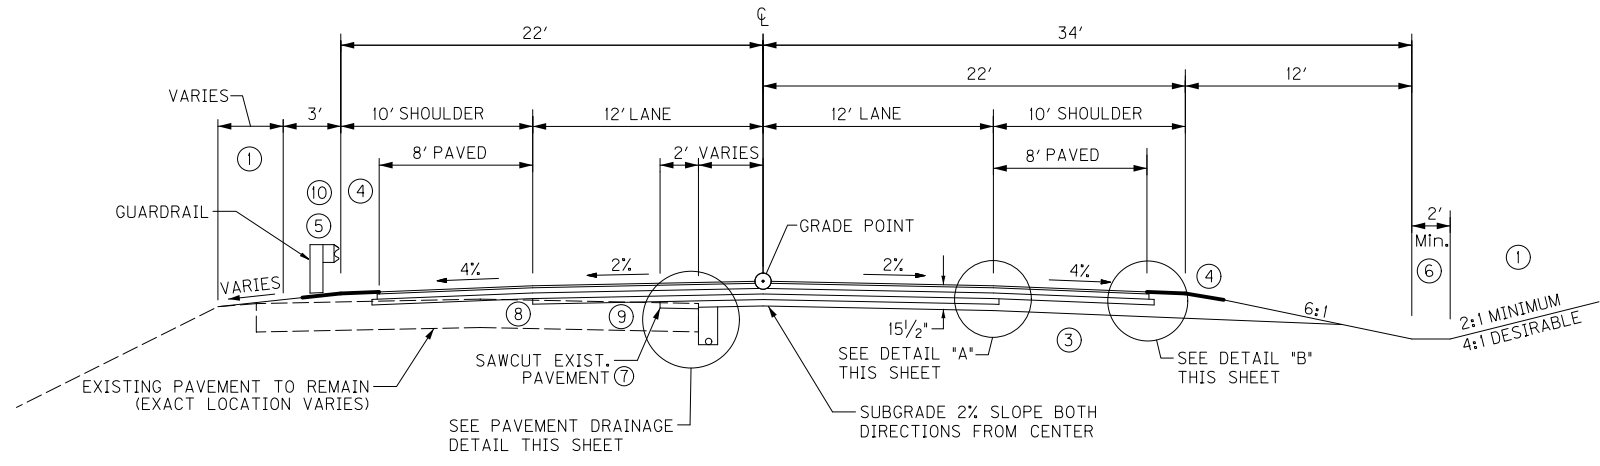

NORMAL RURAL FILL /CUT SECTION
STA. 267 + 91.73 TO STA. 309 + 00

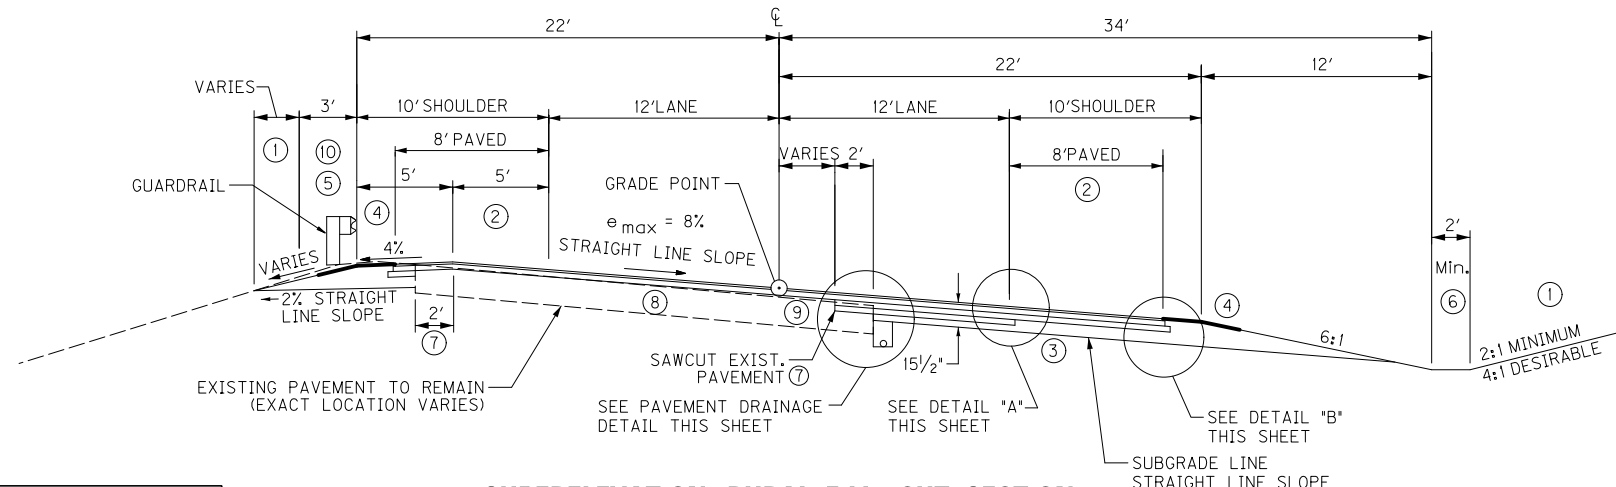

SUPERELEVATION RURAL FILL /CUT SECTION
STA. 267 + 91.73 TO STA. 309 + 00



PAVEMENT DRAINAGE DETAIL

SCALE: 1" = 1'


PERFORATED PIPE SHALL BE PLACED IN THE TRENCH BOTTOM ON APPROPRIATELY INSTALLED TYPE IV GEOTEXTILE FABRIC. NO. 57 STONE SHALL BE PLACED AND COMPACTED IN 6-INCH MAXIMUM LIFTS.

LONGITUDINAL PERFORATED PIPES ARE NOT SHOWN ON THE PLANS. PERFORATED PIPE SIZES AND QUANTITIES ARE SHOWN IN THE SUBGRADE UNDERDRAIN CONSTRUCTION NOTES AND SHALL MATCH THE NON-PERFORATED PIPE OUTLET SIZE.

TYPE IV GEOTEXTILE FABRIC SHALL BE EXTENDED 12 INCHES TRANSVERSELY ALONG THE TOP AND BOTTOM OF THE DRAINAGE BLANKET COURSE.


CRUSHED AGGREGATE SIZE NO. 57 AND FABRIC - GEOTEXTILE FABRIC TYPE IV SHALL BE INCIDENTAL TO THE CONTRACT UNIT BID PRICE FOR PERFORATED PIPE - 4 INCH.

PAVEMENT SUBGRADE DRAIN OUTLET LOCATIONS SHOWN ON THE PLANS ARE APPROXIMATE. OUTLETS SHALL BE SLOPED TO DRAIN. EXACT OUTLET SLOPES, LOCATIONS AND ELEVATIONS SHALL BE DETERMINED IN THE FIELD AND SUBJECT TO THE APPROVAL OF THE ENGINEER.

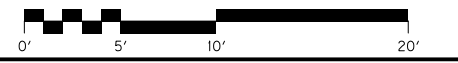


MAINLINE
 RURAL WIDENING TYPICAL SECTIONS
 KY 146 RELOCATION

SCALE: 1" = 5'

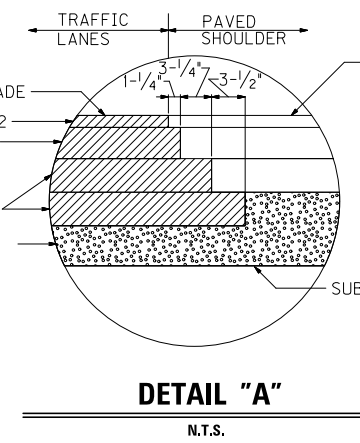

DETAIL "A"

N.T.S.
TRAFFIC LANE PAVEMENT

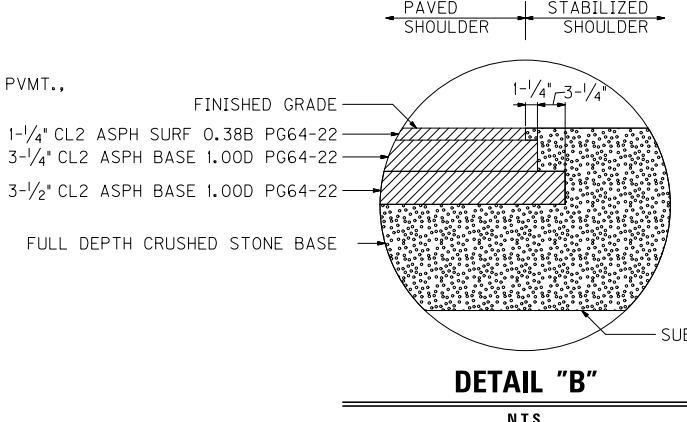

DETAIL "B"

N.T.S.
SHOULDER PAVEMENT

PAVEMENT SCHEDULE	
TRAFFIC LANES WIDENING	
CRUSHED STONE BASE	4" DEPTH
CL 2 ASPH BASE 1.00D PG64-22	10-1/4" DEPTH
CL 2 ASPH SURF 0.38B PG 64-22	1-1/4" DEPTH
TRAFFIC LANES OVERLAY	
LEVELING AND WEDGING PG64-22	VARIES (TON)
CL 2 ASPH BASE 1.00D PG64-22	10-1/4" DEPTH
CL 2 ASPH SURF 0.38B PG 64-22	1-1/4" DEPTH
SHOULDERS WIDENING	
CRUSHED STONE BASE	FULL DEPTH
CL 2 ASPH BASE 1.00D PG64-22	6-3/4" DEPTH
CL 2 ASPH SURF 0.38B PG64-22	1-1/4" DEPTH
SHOULDERS OVERLAY	
LEVELING AND WEDGING	VARIES (TON)
CRUSHED STONE BASE	VARIES (TON)
CL 2 ASPH BASE 1.00D PG64-22	6-3/4" DEPTH
CL 2 ASPH SURF 0.38B PG64-22	1-1/4" DEPTH

NOTE:
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FILE NAME: I:\3886-KY 146 HENRY\PHASE 2\SEGMENT 1\SHEETS\TYPICAL SECTIONS\RO0202C.DGN
 USER: TRobinson
 DATE PLOTTED: December 8, 2014
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 MicroStation v8.11.7.443

FILE NAME: I:\3886-KY 146 HENRY\PHASE 2\SEGMENT 1\ SHEETS\TYPICAL SECTIONS\RO020D.TS.DGN
 USER: TRobinson
 DATE PLOTTED: December 8, 2014
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 MicroStation v8.11.7.443

COUNTY OF	ITEM NO.	SHEET NO.
HENRY	5-8300.00	RO02D

**RIGHT OF WAY
PLANS**



TYPICAL SECTIONS

LOCAL ACCESS ROADS

(CONNECTORS NO. 1 & 2, ROSEHILL LANE, DAWKINS LANE, BROKO LANE, HIEATT LANE)



NOTES

- ① SEE CROSS SECTIONS FOR SLOPES OUTSIDE THE LIMITS OF THE SHOULDERS.
- ② SUPERELEVATED SHOULDER TO BE CONSTRUCTED TO SUPERELEVATION RATE. AT NO TIME WILL THE SLOPE BE FLATTER THAN THE SLOPE INDICATED FOR NORMAL SECTION.
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- ⑦ PAVEMENT SHOULD BE EXTENDED TO FACE OF GUARDRAIL.

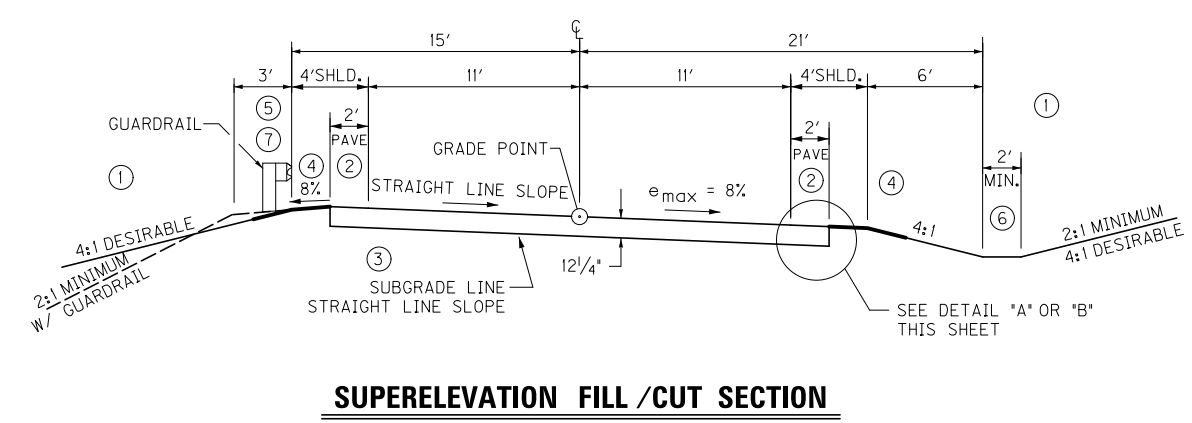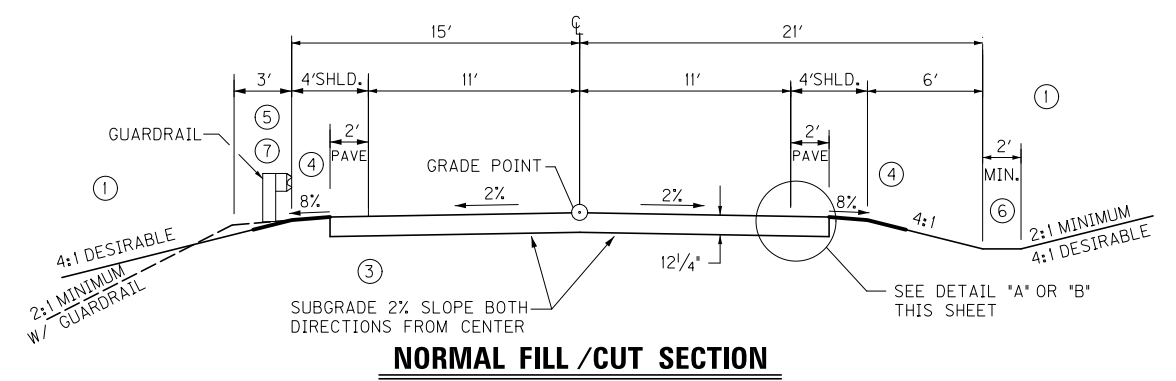

PAVEMENT SCHEDULE	
BROKO LANE AND HIEATT LANE TRAFFIC LANES AND SHOULDERS	
CRUSHED STONE BASE	4" DEPTH
CL 2 ASPH BASE 1.00D PG64-22	10-1/4" DEPTH
CL 2 ASPH SURF 0.38B PG 64-22	1-1/4" DEPTH
CONN. NO. 1 & 2, ROSEHILL LANE AND DAWKINS LANE TRAFFIC LANES AND SHOULDERS	
CSB	8" DEPTH
CL2 ASPH BASE 0.75D PG64-22	3" DEPTH
CL2 ASPH SURF 0.38D PG64-22	1-1/4" DEPTH

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SCALE: 1"= 5'
 LOCAL ACCESS ROADS
 RURAL TYPICAL SECTIONS
 KY 146 RELOCATION

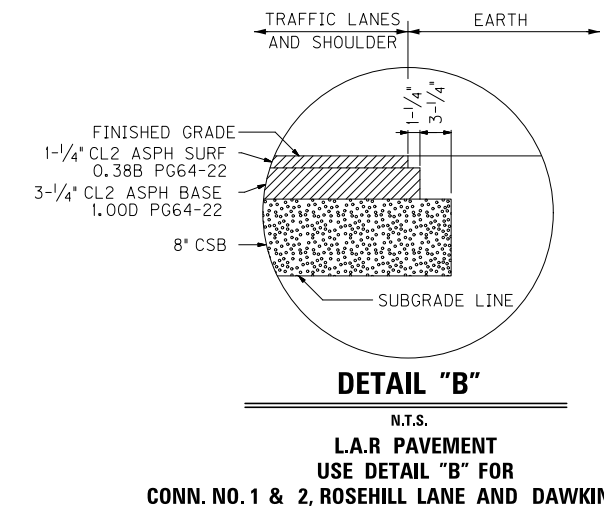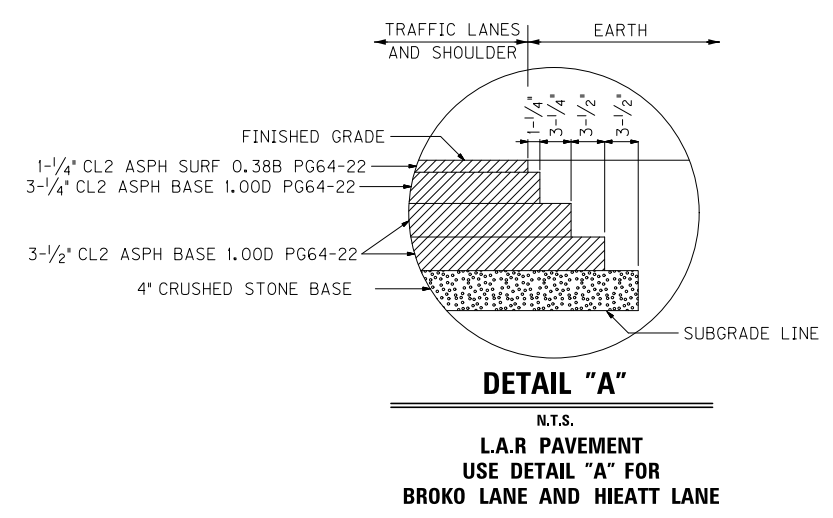
COUNTY OF	ITEM NO.	SHEET NO.
HENRY	5-8300.00	RO02E

RIGHT OF WAY PLANS


TYPICAL SECTIONS ENTRANCES AND DETAILS

NOTES


- SEE CROSS SECTIONS FOR SLOPES OUTSIDE THE LIMITS OF THE SHOULDERS AND BORDERS.
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- SEE PLANS FOR RIPRAP CHANNEL LINING REQUIREMENTS. UNLESS OTHERWISE DIRECTED ALL DITCHES NOT RECEIVING RIPRAP CHANNEL LINING SHALL BE LINED WITH EROSION CONTROL BLANKET WITH A MINIMUM DEPTH TO PROTECT OF ONE-AND-A-HALF (1.5) FEET.

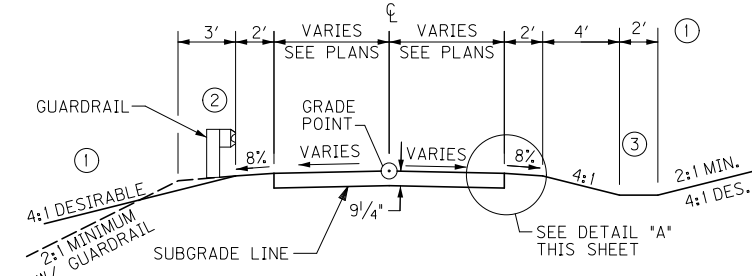

COMMERCIAL ENTRANCE SECTION

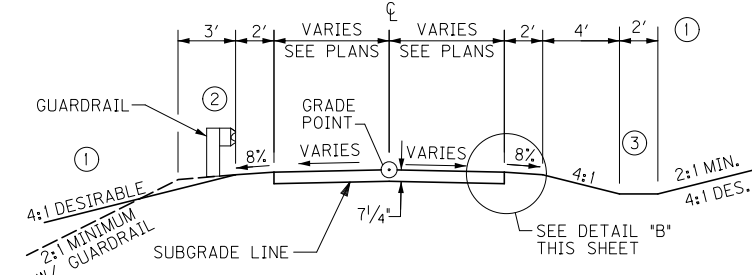


RESIDENTIAL AND FARM FIELD ENTRANCE SECTION

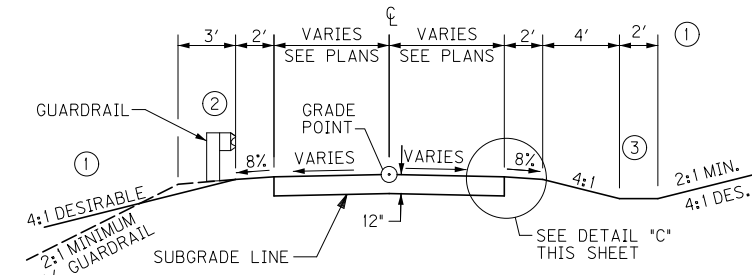

CONCRETE COMMERCIAL /RESIDENTIAL ENTRANCE SECTION

PAVEMENT SCHEDULE	
COMMERCIAL ENTRANCE TRAFFIC LANES	
CRUSHED STONE BASE	6" DEPTH
CL2 ASPH BASE 1.00D PG64-22	2" DEPTH
CL2 ASPH SURF 0.38D PG64-22	1-1/4" DEPTH
RESIDENTIAL AND FARM ENTRANCE TRAFFIC LANES	
CRUSHED STONE BASE	4" DEPTH
CL2 ASPH BASE 1.00D PG64-22	2" DEPTH
CL2 ASPH SURF 0.38D PG64-22	1-1/4" DEPTH
CONCRETE ENTRANCE TRAFFIC LANES	
CRUSHED STONE BASE	4" DEPTH
RIGID PCC	8" DEPTH


NOTE:
PAVEMENT DESIGN SHOWN IS FOR ESTIMATING PURPOSES ONLY. THE PAVEMENT DESIGN WILL BE FINALIZED BASED ON THE RESULTS OF THE GEOTECHNICAL INVESTIGATION.

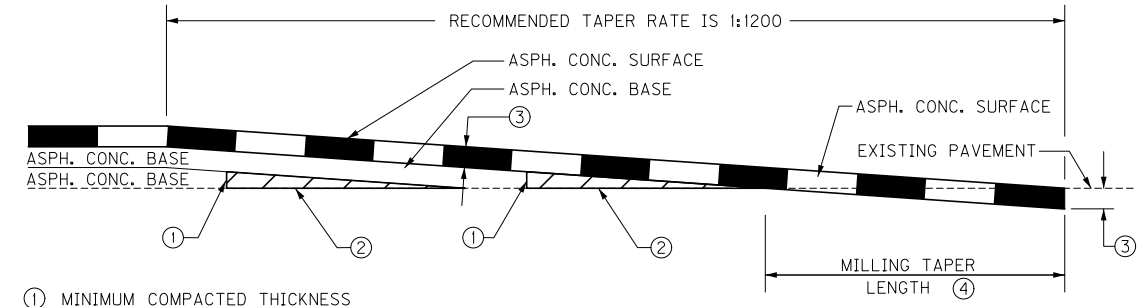


- MINIMUM COMPACTED THICKNESS
- ASPHALT MIXTURE FOR LEVELING AND WEDGING OR NEXT COURSE OF ASPHALT MIXTURE.
- ASPHALT SURFACE THICKNESS (FULL DEPTH)
- MILL EXISTING PAVEMENT TO RECEIVE ASPHALT SURFACE FULL DEPTH (EDGE KEY).
TAPER LENGTH (ft) = $\frac{t \text{ (in)} \times \text{TAPER RATE}}{12}$

FOR A TAPER RATE OF 1:1200
TAPER LENGTH = 125 FEET WHEN t = 1.25 inches
TAPER LENGTH = 150 FEET WHEN t = 1.50 inches


TAPERING OF OVERLAYS ON HIGH SPEED FACILITIES (≥45 MPH)

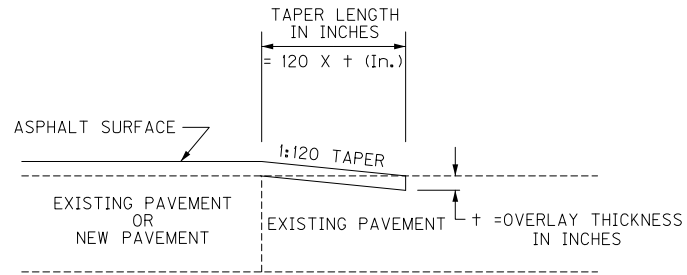


TAPERING OF OVERLAYS ON LOW SPEED FACILITIES (<45 MPH)

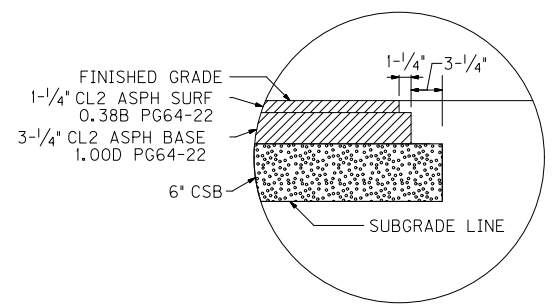


DETAIL "A"
N.T.S.
COMMERCIAL ENTRANCE PAVEMENT

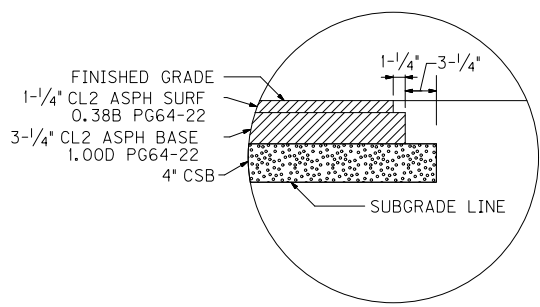

DETAIL "B"
N.T.S.
RESIDENTIAL AND FARM ENTRANCE PAVEMENT

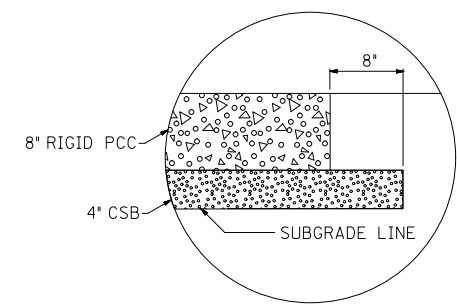

DETAIL "C"
N.T.S.
CONCRETE COMMERCIAL /RESIDENTIAL ENTRANCE PAVEMENT

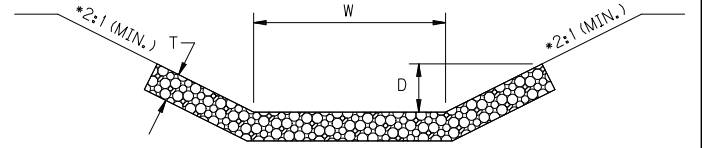


TYPICAL CHANNEL LINING DETAIL

N.T.S.
W = WIDTH
T = LINING THICKNESS
CLASS II CH. LIN.: T=15"
CLASS III CH. LIN.: T=24"
D = DEPTH TO PROTECT
ECB = 1.5' MIN.
TRM OR CHANNEL LINING = 1' MIN.

NOTES: SEE CONST. PLAN NOTES FOR VALUE OF W AND D.

PARTIALLY GROUTED RIPRAP


Partially Grouted Riprap, as described in DR 504-7, aims to increase the stability of the riprap without sacrificing its flexibility. The bid items for the construction of partially grouted riprap include Concrete Class B and Channel Lining. The quantity of Concrete Class B is estimated at 20% of the top 1' of the area to be grouted.

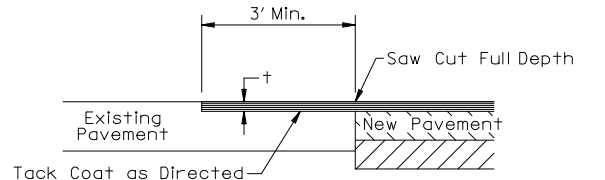

TRANSVERSE PAVEMENT TIE DETAIL

+ = THICKNESS OF SURFACE COURSE


Work under this item shall include cutting out the existing asphalt surface to a minimum depth and width as shown, so the new surface may heel into the existing surface. This work shall be incidental to construction of the asphalt concrete.

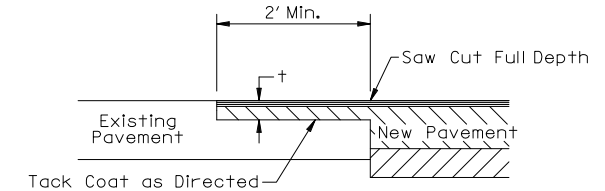

LONGITUDINAL PAVEMENT TIE DETAIL

+ = THICKNESS OF SURFACE COURSE AND FIRST BASE COURSE

Work under this item shall include cutting out the existing asphalt surface to a minimum depth and width as shown, so the new surface may heel into the existing surface. This work shall be incidental to construction of the asphalt concrete.

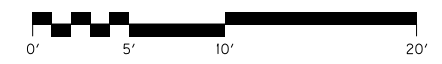

SCALE: 1"= 5'

ENTRANCES AND DETAILS
TYPICAL SECTIONS
KY 146 RELOCATION

FILE NAME: I:\3886-KY 146 HENRY\PHASE 2\SEGMENT 1\ SHEETS\TYPICAL SECTIONS\RO020ETS.DGN
USER: TRobinson
DATE PLOTTED: December 8, 2014
E-SHEET NAME:
MicroStation v8.11.7.443





TYPICAL SECTIONS

TEMPORARY CONSTRUCTION

**RIGHT OF WAY
PLANS**



COUNTY OF	ITEM NO.	SHEET NO.
HENRY	5-8300.00	RO02F

FILE NAME: I:\3886-KY 146 HENRY-PHASE 2\SEGMENT 1\SHEETS\TYPICAL SECTIONS\RO020FTS.DGN
 USER: Tr Robinson
 DATE PLOTTED: December 8, 2014
 E-SHEET NAME:
 MicroStation v8.11.7.443

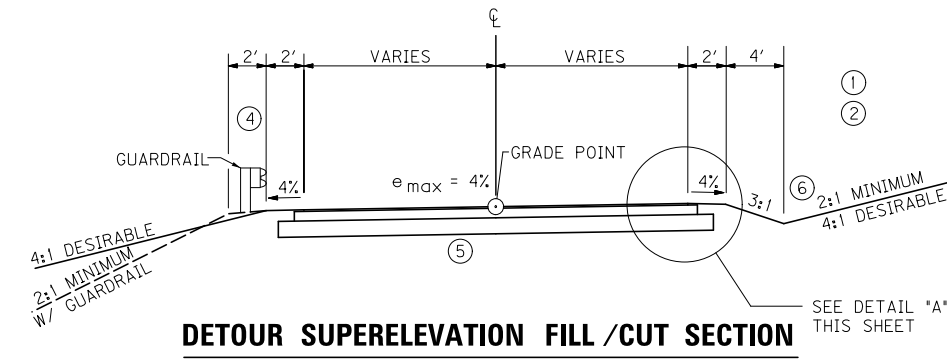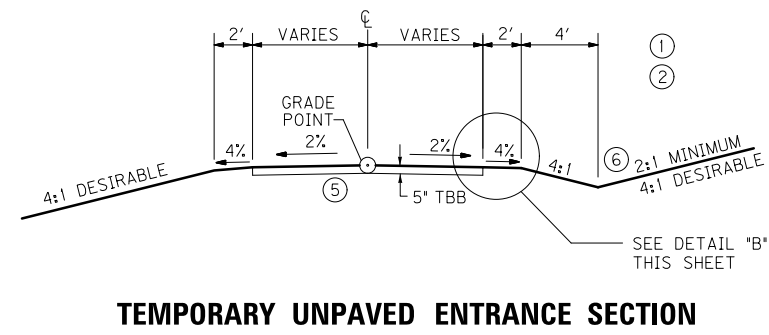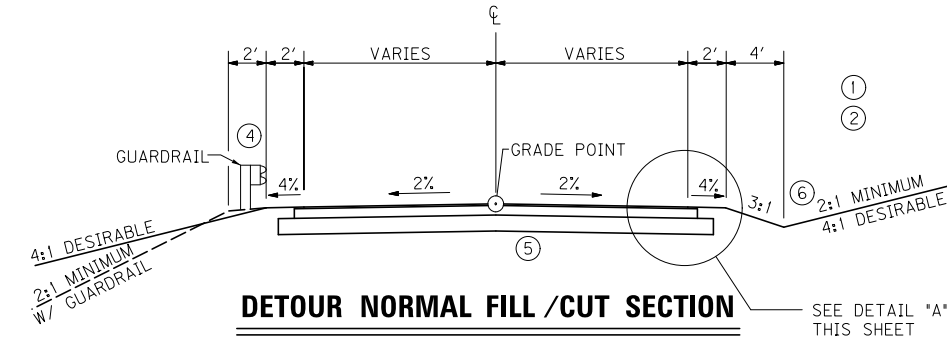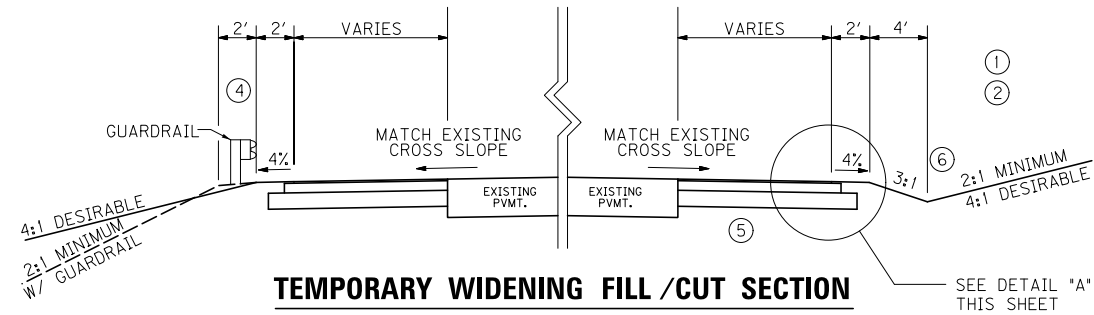


NOTES

- ① SEE CROSS SECTIONS FOR SLOPES OUTSIDE THE LIMITS OF THE SHOULDERS.
- ② SUPERELEVATED SHOULDER TO BE CONSTRUCTED TO SUPERELEVATION RATE. AT NO TIME WILL THE SLOPE BE FLATTER THAN THE SLOPE INDICATED FOR NORMAL SECTION.
- ③ REFILL MATERIAL TO CONFORM TO APPLICABLE SECTIONS OF THE CURRENT EDITION OF KENTUCKY STANDARD SPECIFICATIONS FOR ROAD AND BRIDGE CONSTRUCTION.
- ④ SHOULDERS SHALL BE WIDENED 1' WHERE GUARDRAIL IS TO BE INSTALLED.
- ⑤ SUBGRADE MATERIAL SHALL CONFORM TO AND BE PLACED AND COMPACTED IN ACCORDANCE WITH THE APPLICABLE SECTIONS OF THE CURRENT EDITION OF THE KENTUCKY STANDARD SPECIFICATIONS FOR ROAD AND BRIDGE CONSTRUCTION. SUBGRADE MATERIAL SHALL BE CAPABLE OF PROVIDING A MINIMUM CBR VALUE OF 6.
- ⑥ SEE PLANS FOR CHANNEL LINING REQUIREMENTS

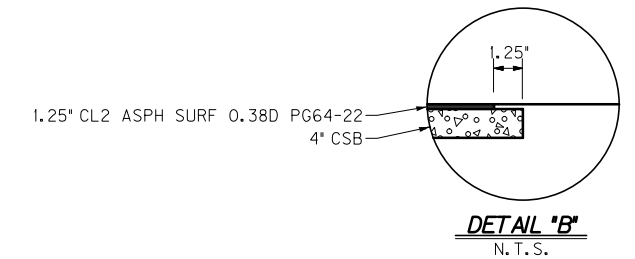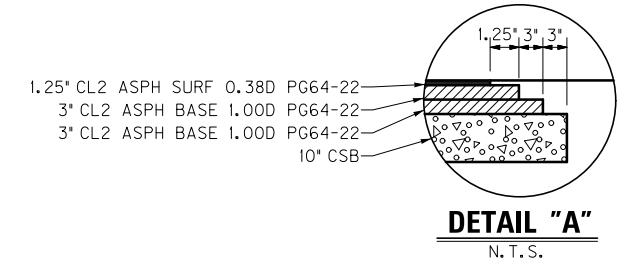

PAVEMENT SCHEDULE	
DETOUR	
CRUSHED STONE BASE	10" DEPTH
CL2 ASPH BASE 1.00D PG64-22	3" DEPTH
CL2 ASPH BASE 1.00D PG64-22	3" DEPTH
CL2 ASPH SURF 0.38D PG64-22	1 1/4" DEPTH
TEMPORARY WIDENING	
CRUSHED STONE BASE	10" DEPTH
CL2 ASPH BASE 1.00D PG64-22	3" DEPTH
CL2 ASPH BASE 1.00D PG64-22	3" DEPTH
CL2 ASPH SURF 0.38D PG64-22	1 1/4" DEPTH
TEMPORARY UNPAVED ENTRANCE	
TBB	5" DEPTH

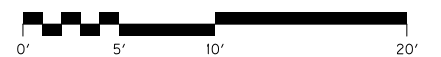

SCALE: 1"=5'


TEMPORARY CONSTRUCTION
TYPICAL SECTIONS
KY 146 RELOCATION

COUNTY OF	ITEM NO.	SHEET NO.
HENRY	5-8300.00	R002G


**RIGHT OF WAY
PLANS**

TYPICAL SECTIONS


KY 146 RELOCATION BRIDGES

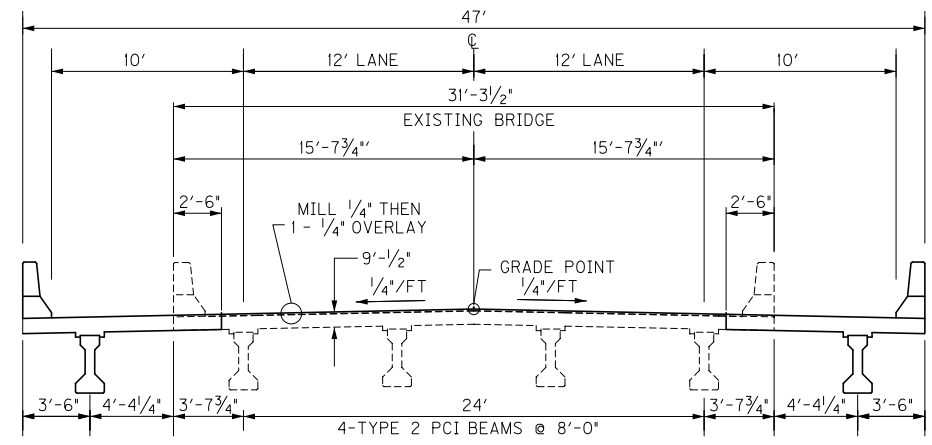

EXISTING 2-LANE BRIDGE TYPICAL
OVER LITTLE KENTUCKY RIVER AT STA. 135 + 77.74
AND OVER BARTLETT FORK AT STA. 267 + 52.11

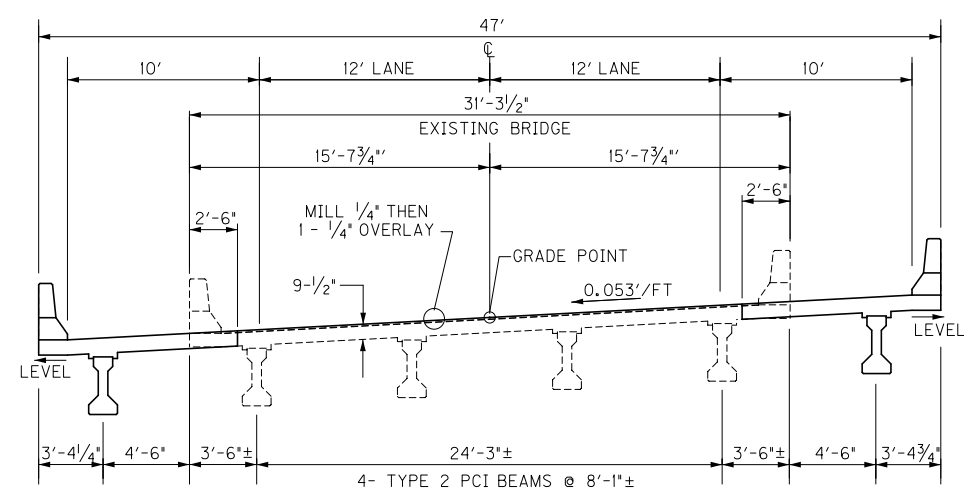

EXISTING SUPERELEVATED 2-LANE BRIDGE TYPICAL
OVER BARTLETT FORK AT STA. 324 + 44.09

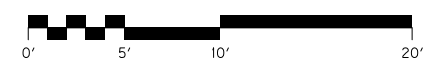

SCALE: 1" = 5'

BRIDGE TYPICALS
TYPICAL SECTIONS
KY 146 RELOCATION

FILE NAME: I:\3886-KY 146 HENRY\PHASE 2\SEGMENT 1\SHEETS\TYPICAL SECTIONS\R0020GTS.DGN

USER: TRobinson
DATE PLOTTED: December 8, 2014

E-SHEET NAME:


MicroStation v8.11.7.443

MicroStation v8.11.7.443 E-SHEET NAME: DATE PLOTTED: December 8, 2014 USER: TRobinson FILE NAME: I:\3886-KY 146 HENRY\PHASE 2\SEGMENT 1\SHEETS\PROFILES\ROO400PR.DGN

DATUM 930 925 920 915 910 905 900 895 890 885 880 875 870 865 860 855 850 845 840

COUNTY OF	ITEM NO.	SHEET NO.
HENRY	5-8300.00	RO04

**RIGHT OF WAY
PLANS**

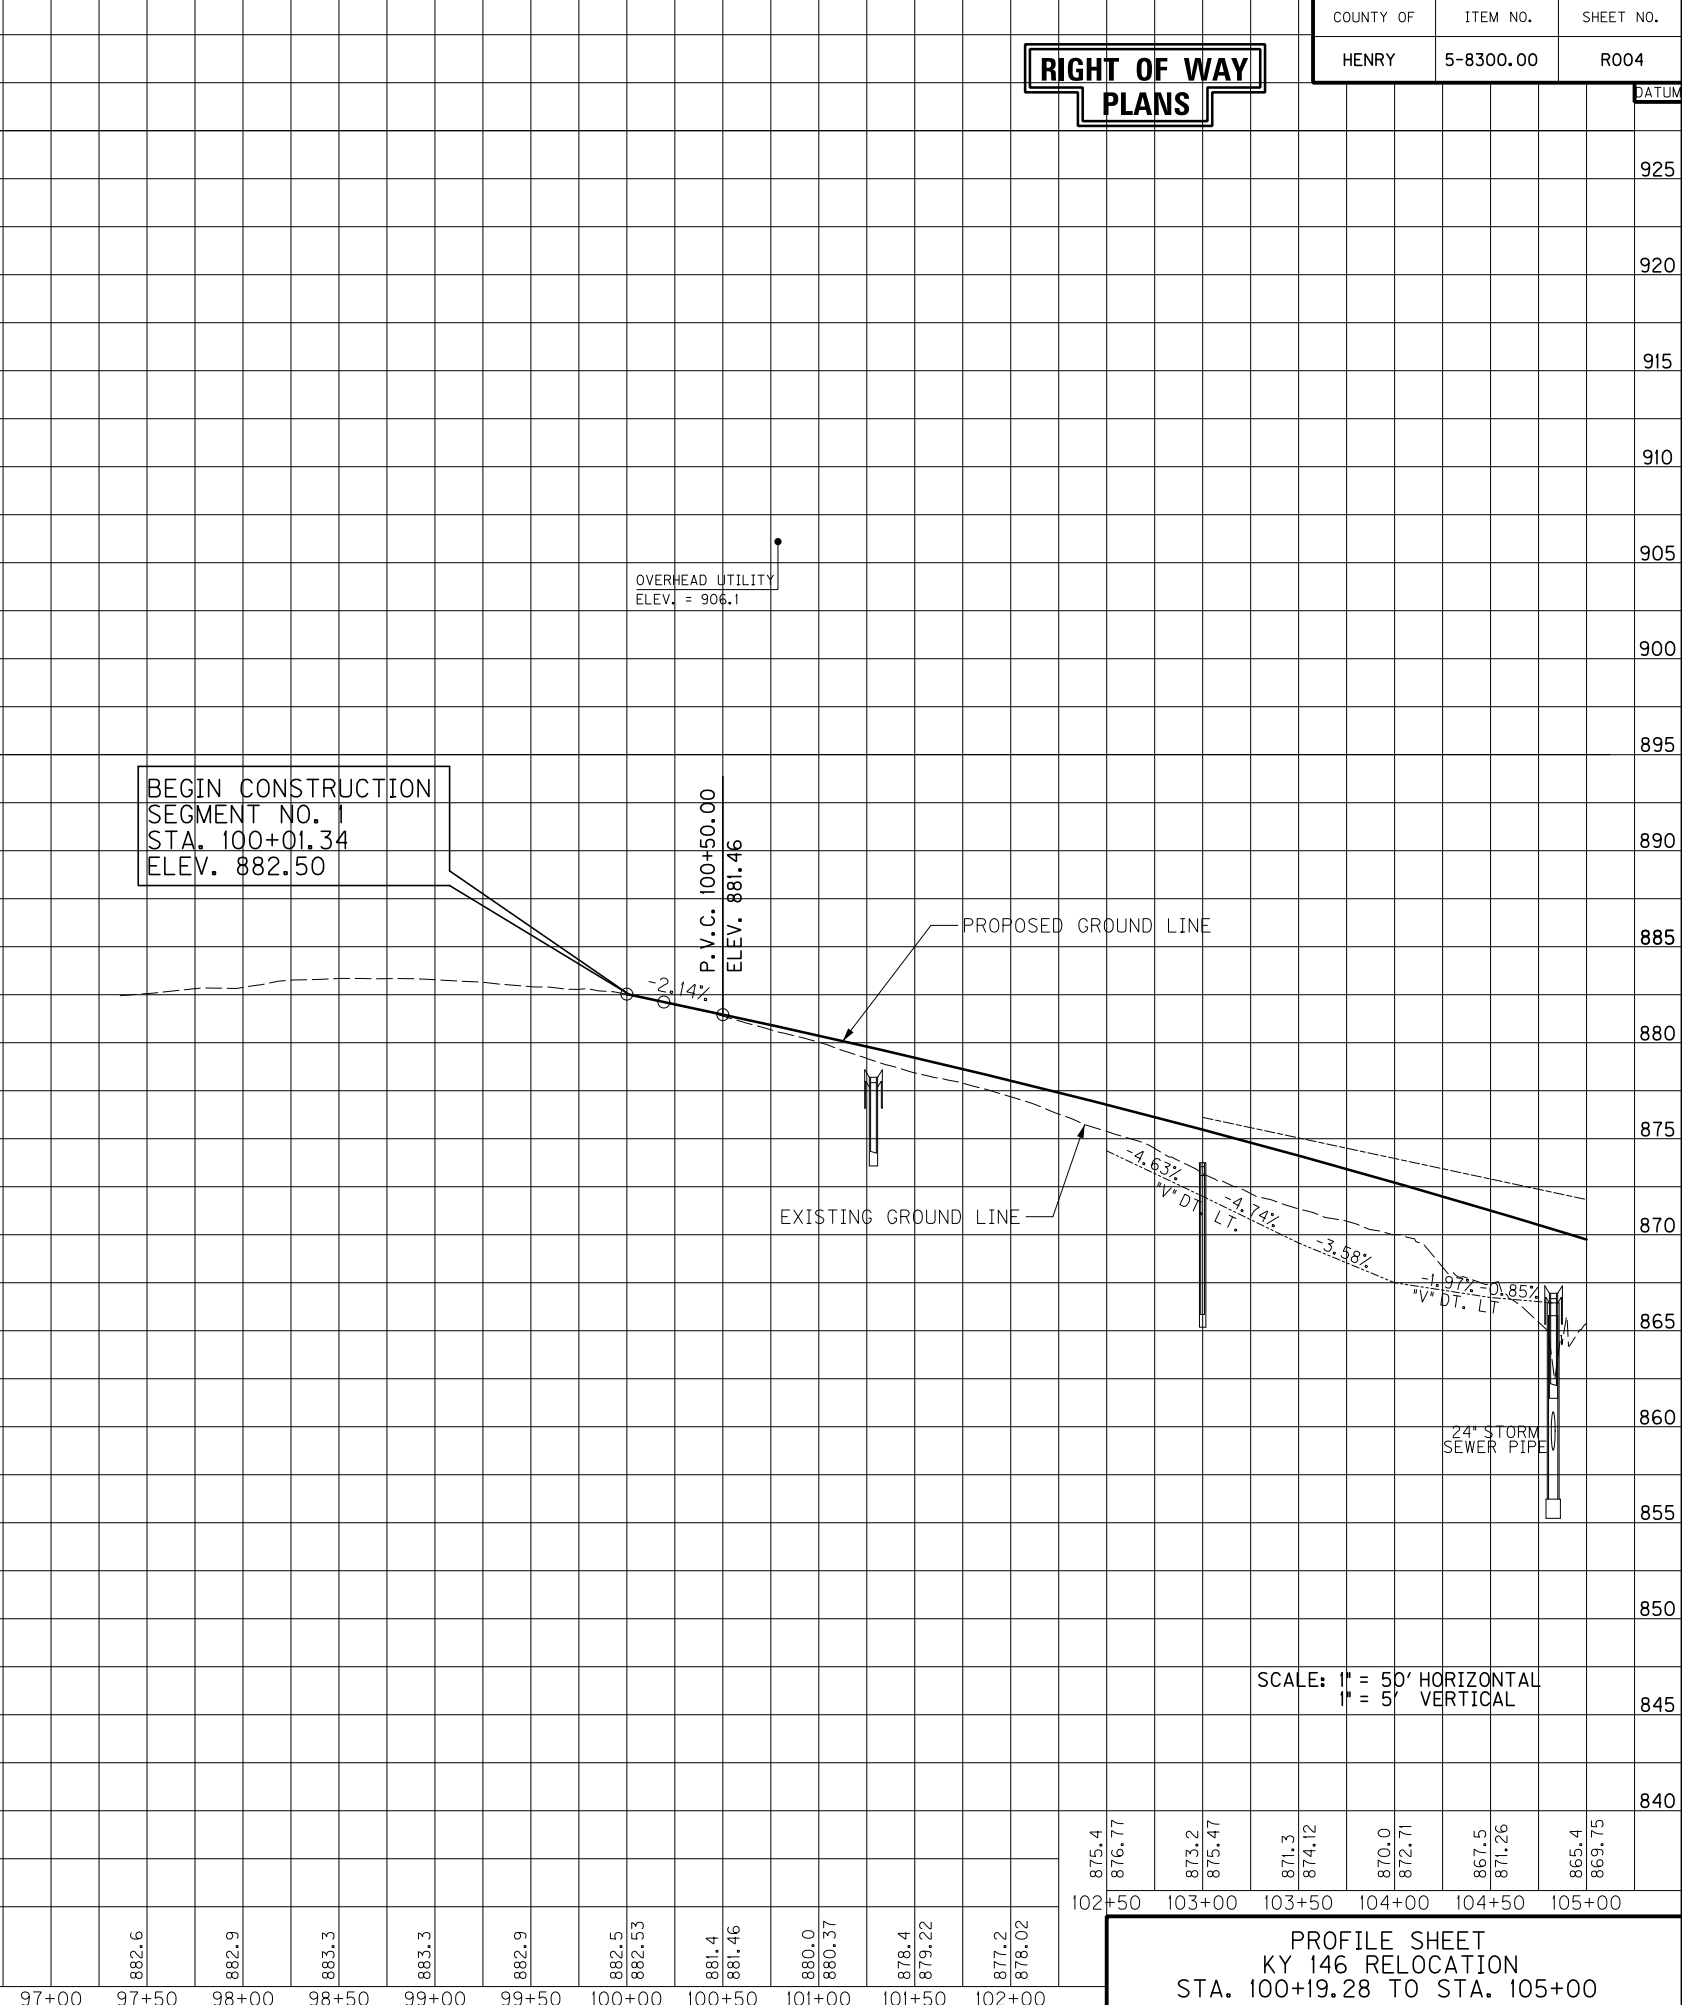

SCALE: 1" = 50' HORIZONTAL
1" = 5' VERTICAL

PROFILE SHEET
KY 146 RELOCATION
STA. 100+19.28 TO STA. 105+00

FILE NAME: I:\3886-KY 146 HENRY PHASE 2 SEGMENT 1\SENT\2014-12-12 ROW SET\PLAN\0500PL.DGN
 USER: TRobinson
 DATE PLOTTED: December 8, 2014
 E-SHEET NAME: MicroStation v8.11.7.443

COUNTY OF	ITEM NO.	SHEET NO.
HENRY	5-8300.00	RO05

DITCH CONSTRUCTION - LEFT			
STATION	SIZE-SHAPE TYPE	LINING	
		TYPE	QUANTITY
105+00 TO 105+50	SPL. 2' F.B. DT.	ECB	81 S.Y.
106+50 TO 107+50	NORMAL DT.	ECB	161 S.Y.
107+50 TO 108+07.27	SPL. 2' F.B. DT.	TRM I	67 S.Y.
108+83 TO 109+68.38	SPL. 2' F.B. DT.	TRM I	101 S.Y.
110+60.38 TO 111+50 *	2' F.B. SURF. DT.	TRM I	117 S.Y.
111+50 TO 113+50	NORMAL DT.	TRM I	227 S.Y.
113+50 TO 114+00	SPL. 2' F.B. DT.	TRM I	59 S.Y.
113+48.92 TO 114+00	SPL. 2' F.B. DT.	ECB	43 S.Y.
114+00 TO 116+00	SPL. 2' F.B. DT.	TRM I	191 S.Y.
CONN. NO.1 LT STA. 8+87.06	4' F.B. OUTLET	CL. III	52 TONS
118+00 TO 118+47.65	SPL. 2' F.B. DT.	TRM I	55 S.Y.
CONN. NO. 16+75 RT TO 8+00 RT	SPL. 2' F.B. DT.	TRM I	125 S.Y.
CONN. NO. 18+42.85 RT TO 9+00 RT	SPL. 2' F.B. DT.	ECB	144 S.Y.
CONN. NO. 19+00 RT TO 9+15 RT *	SPL. 2' F.B. DT.	TRM I	43 S.Y.

* DEPTH TO PROTECT = 1.5'

ENTRANCE CONSTRUCTION - LEFT									
STATION	ENTRANCE TYPE	ENTR. WIDTH (FT)	AREA (SQ YD)	CEM. CONC. ENT. PVMT. 8" (SQ. YDS.)	ASPHALT SURFACE (TONS)	ASPHALT BASE (TONS)	CSB (TONS)	ENTR. PIPE (FT)	HDWL
105+88	COMMERCIAL	50	165	--	11	30	58	--	--
108+40	COMMERCIAL	40	173	--	12	31	61	75' of 15" PIPE	--
110+06	COMMERCIAL	44	229	229	--	--	55	92' of 15" PIPE	--

STEEL "W" BEAM GUARDRAIL
 LT. STA. 117+25.72 TO STA. 119+55.18,
 CONST. 229.72 L.F. W/1 END TREATMENT TY. 3


R/W MONUMENT - TYPE 1
 LT. STA. 105+00 TO STA. 120+00,
 CONST. 11

CONN. NO. 1 - LT. STA. 6+74.83
 TO STA. 9+77.99, CONST. 295.28 L.F.
 W/1 TERMINAL SECTION NO. 1

REMOVE PAVEMENT
 LT. STA. 112+33.77 TO RT. STA 113+56.81
 REMOVE 117 SQ. YD. OF EXISTING PAVEMENT
 LT. STA. 113+76.70 TO RT. STA 116+48.30
 REMOVE 427 SQ. YD. OF EXISTING PAVEMENT

RIGHT OF WAY PLANS

CONN. NO. 1
 P.I. STA. 8+61.56
 Delta = 62°07'46" LT.
 T = 128.91'
 L = 232.05'
 R = 214.00'
 E = 35.83'
 e = 8.00%

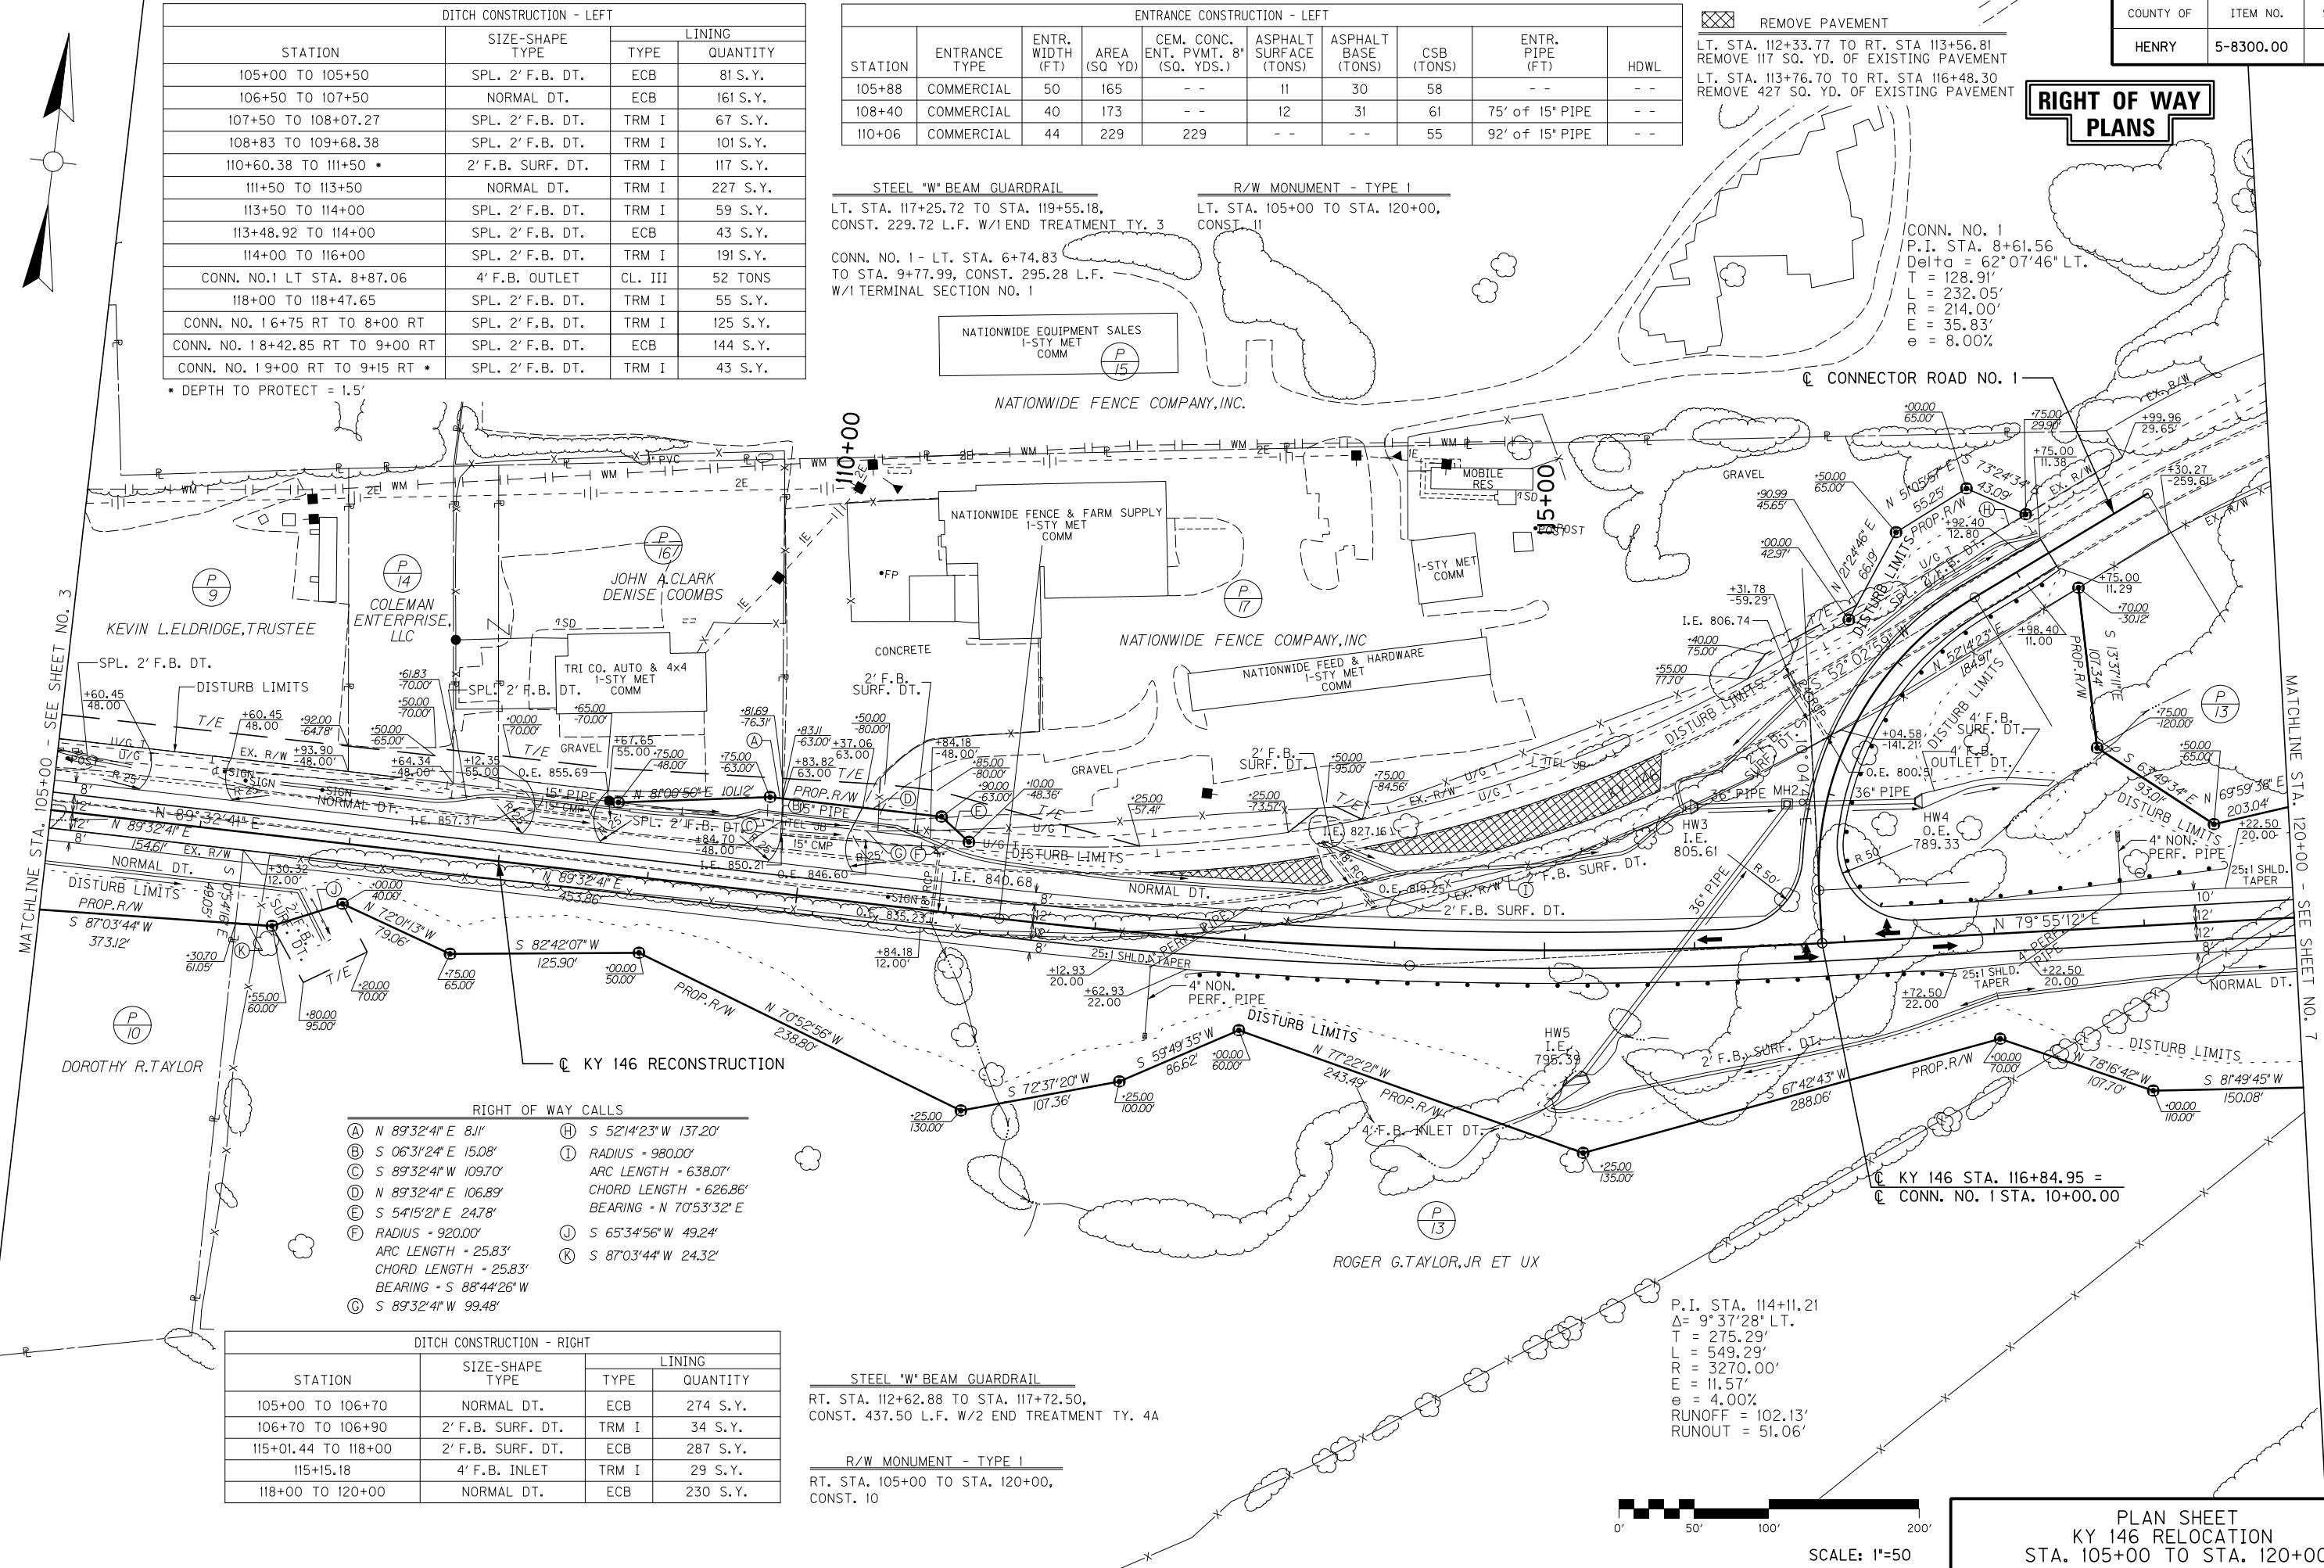


- RIGHT OF WAY CALLS**
- (A) N 89°32'41" E 811'
 - (B) S 06°31'24" E 15.08'
 - (C) S 89°32'41" W 109.70'
 - (D) N 89°32'41" E 106.89'
 - (E) S 54°15'21" E 247.8'
 - (F) RADIUS = 920.00'
ARC LENGTH = 25.83'
CHORD LENGTH = 25.83'
BEARING = S 88°44'26" W
 - (G) S 89°32'41" W 99.48'
 - (H) S 52°14'23" W 137.20'
 - (I) RADIUS = 980.00'
ARC LENGTH = 638.07'
CHORD LENGTH = 626.86'
BEARING = N 70°53'32" E
 - (J) S 65°34'56" W 49.24'
 - (K) S 87°03'44" W 24.32'

DITCH CONSTRUCTION - RIGHT			
STATION	SIZE-SHAPE TYPE	LINING	
		TYPE	QUANTITY
105+00 TO 106+70	NORMAL DT.	ECB	274 S.Y.
106+70 TO 106+90	2' F.B. SURF. DT.	TRM I	34 S.Y.
115+01.44 TO 118+00	2' F.B. SURF. DT.	ECB	287 S.Y.
115+15.18	4' F.B. INLET	TRM I	29 S.Y.
118+00 TO 120+00	NORMAL DT.	ECB	230 S.Y.

STEEL "W" BEAM GUARDRAIL
 RT. STA. 112+62.88 TO STA. 117+72.50,
 CONST. 437.50 L.F. W/2 END TREATMENT TY. 4A

R/W MONUMENT - TYPE 1
 RT. STA. 105+00 TO STA. 120+00,
 CONST. 10

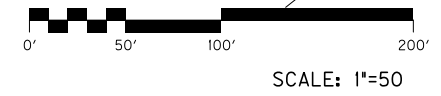


PLAN SHEET
 KY 146 RELOCATION
 STA. 105+00 TO STA. 120+00

MicroStation v8.1i.7.443 E-SHEET NAME: USER: TRobinson DATE PLOTTED: December 8, 2014 FILE NAME: I:\3886-KY 146 HENRY-PHASE 2 SEGMENT \SHEETS\PROFILES\RO0600PR.DGN

COUNTY OF	ITEM NO.	SHEET NO.
HENRY	5-8300.00	RO06

**RIGHT OF WAY
PLANS**

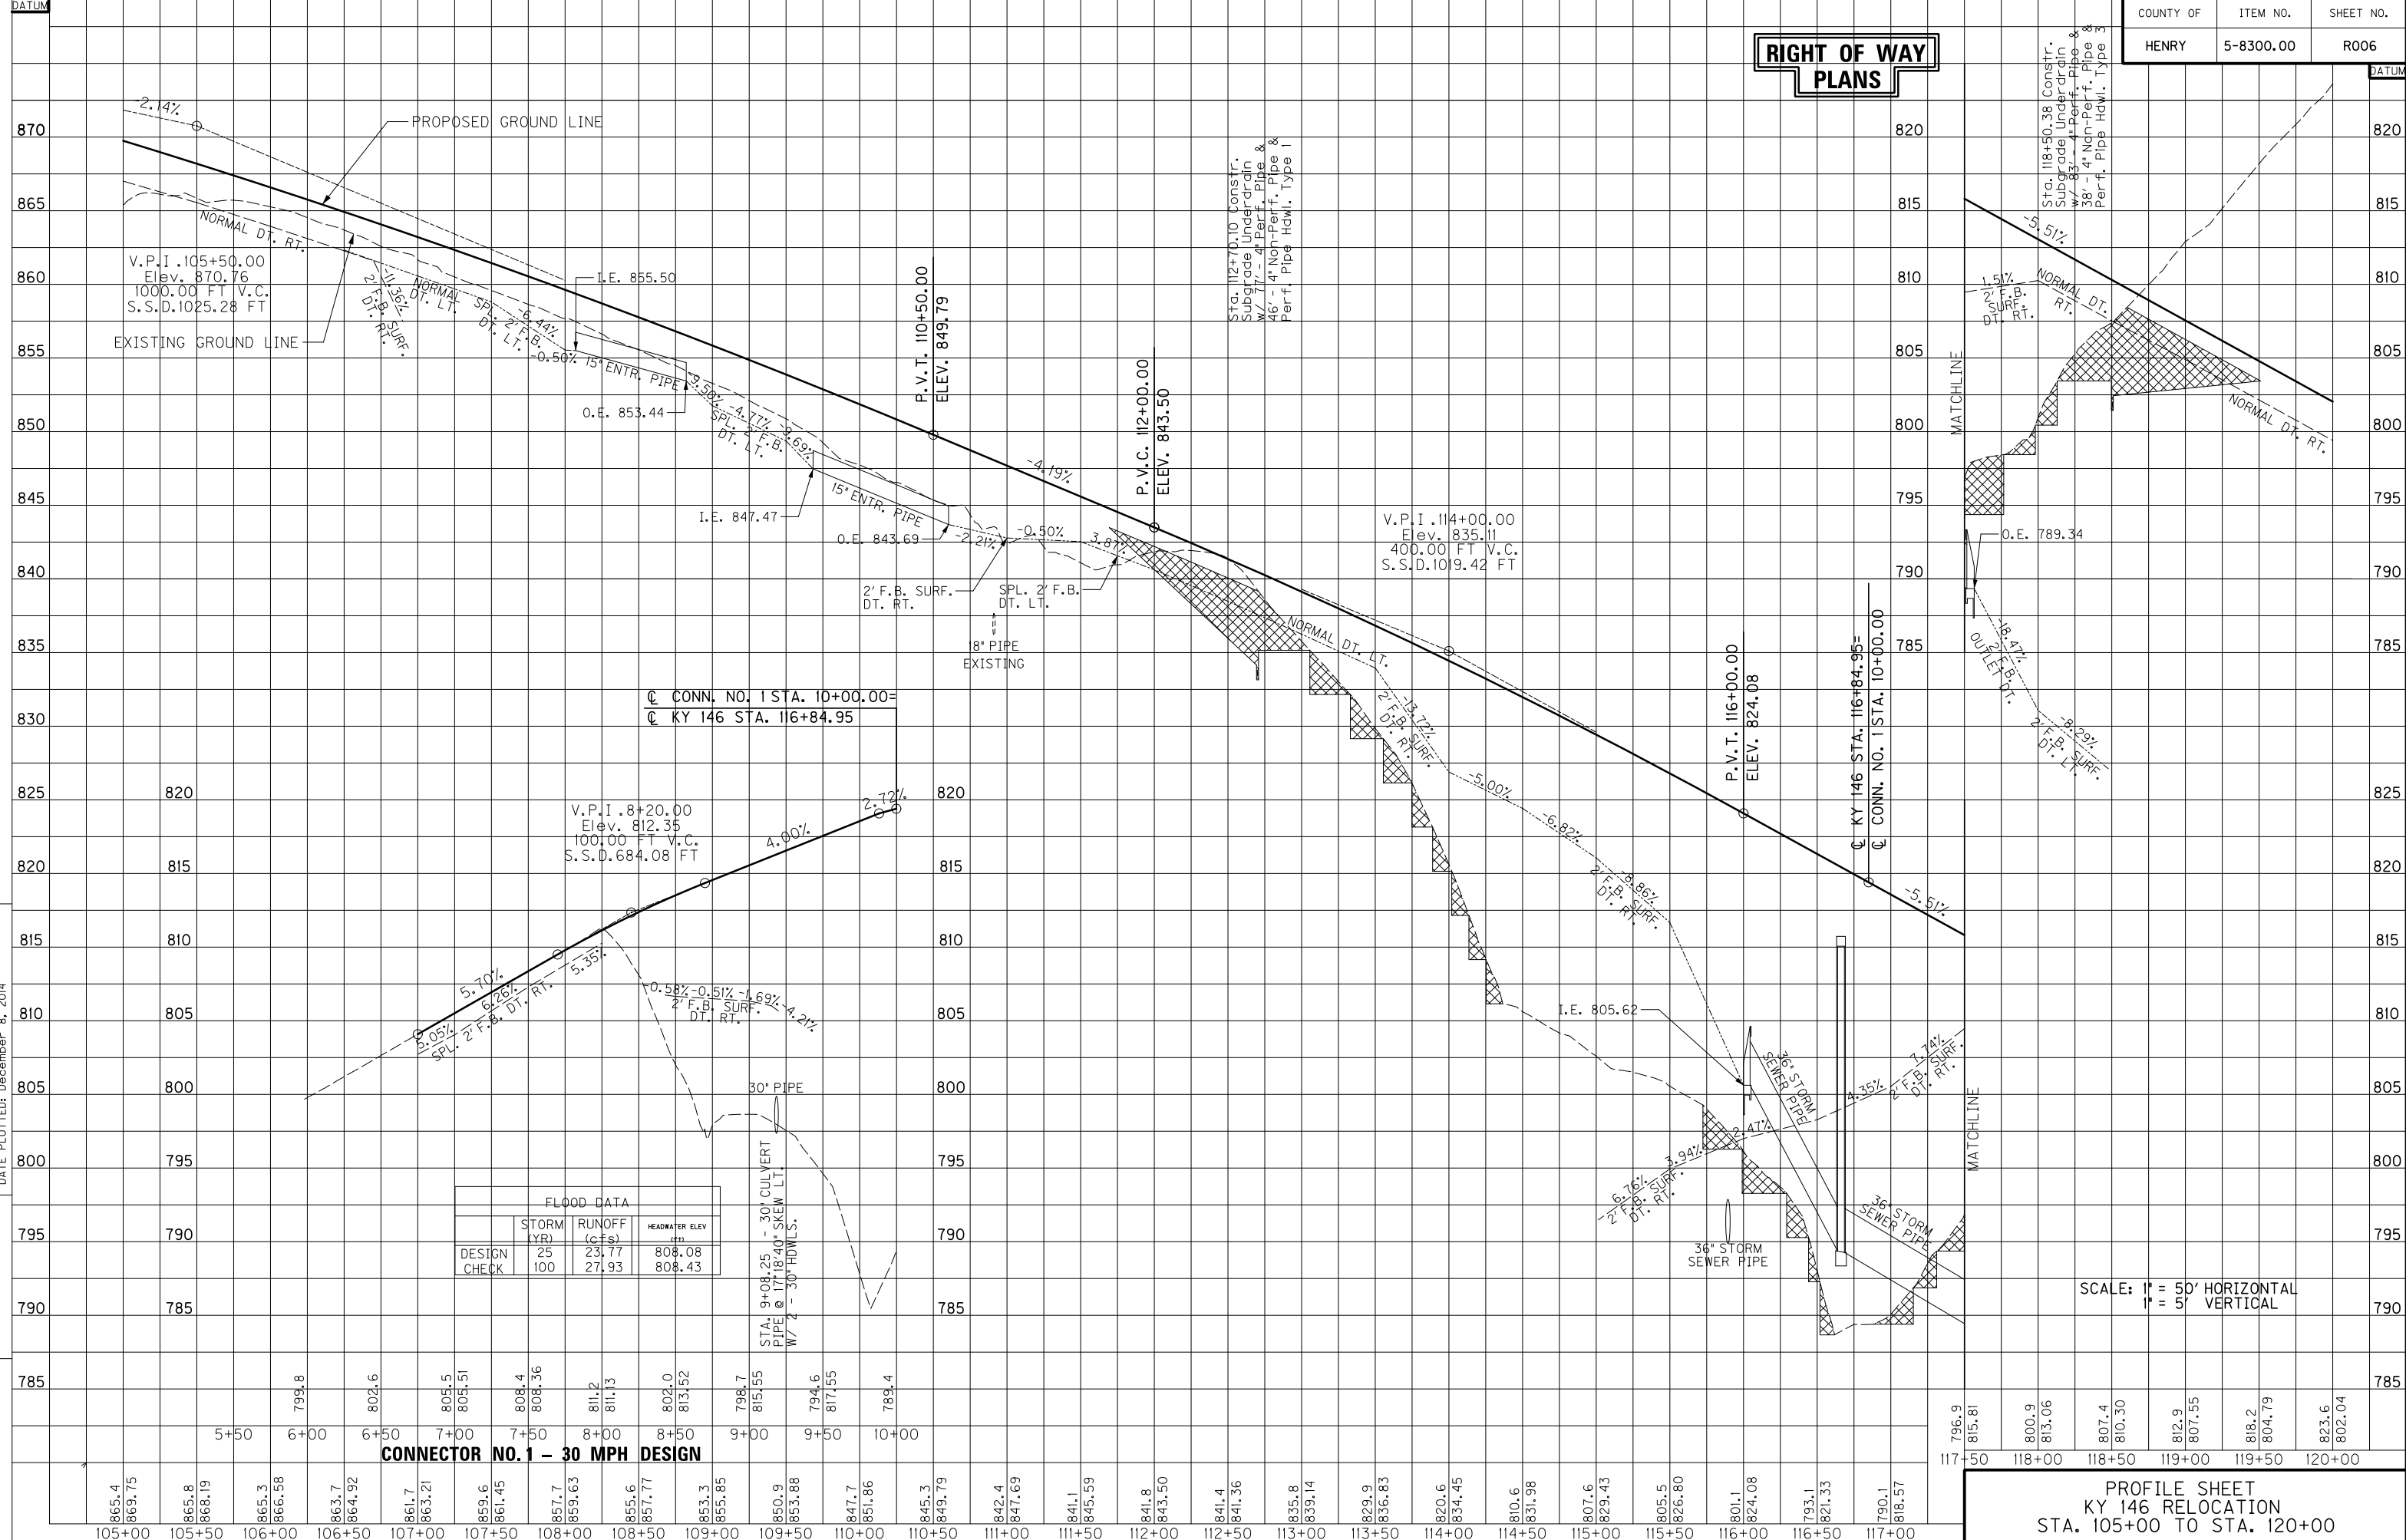

FLOOD DATA

DESIGN CHECK	STORM (YR)	RUNOFF (cfs)	HEADWATER ELEV (ft)
	25	23.77	808.08
	100	27.93	808.43

CONNECTOR NO. 1 - 30 MPH DESIGN

SCALE: 1" = 50' HORIZONTAL
1" = 5' VERTICAL

**PROFILE SHEET
KY 146 RELOCATION
STA. 105+00 TO STA. 120+00**

P.I. STA. 128+51.95
 Delta = 43°24'51.91" RT.
 T = 384.16'
 L = 731.20'
 R = 965.00'
 E = 73.66'
 e = 8.0%
 RUNOFF = 204.26'
 RUNOUT = 51.06'

REMOVE PAVEMENT
 LT. STA. 127+73.83 TO LT. STA 128+51.55
 REMOVE 143 SQ. YD. OF EXISTING PAVEMENT

DITCH CONSTRUCTION - LEFT			
STATION	SIZE-SHAPE TYPE	LINING	
		TYPE	QUANTITY
120+00 TO 122+70	NORMAL DT.	TRM I	310 S.Y.
122+70 TO 123+00	2' F.B. SURF. DT.	TRM I	36 S.Y.
123+00 TO 125+19.11	2' F.B. SURF. DT.	TRM I	210 S.Y.
124+21.61	4' F.B. OUTLET	CL III	57 TONS
125+10.54 TO 125+50	2' F.B. SURF. DT.	ECB	105 S.Y.
125+50 TO 127+60*	NORMAL DT.	TRM I	351 S.Y.
127+60 TO 129+00	SPL. 2' F.B. DT.	TRM I	172 S.Y.
134+78.65	2' F.B. OUTLET	CL II	26 TONS

- DEPTH TO PROTECT = 1.5'
 I.E. 785.38

R/W MONUMENT - TYPE 1
 LT. STA. 120+00 TO STA. 135+00,
 CONST. 9

STEEL "W" BEAM GUARDRAIL
 LT. STA. 127+74.44, CONST. 25.00 L.F.
 W/2 TERMINAL SECTION NO. 1

LT. STA. 131+07.83 TO STA. 135+00,
 CONST. 357.10 L.F. W/1 END TREATMENT TY. 4A

REMOVE GUARDRAIL
 LT. STA. 132+71.01 TO STA. 135+00,
 REMOVE 229 L.F.

ISLAND HEADER CURB TY 2
 LT. STA. 134+88.32 TO STA. 135+00,
 CONST. 11.75 L.F.


- RIGHT OF WAY CALLS
- (A) S 56°50'41" E 255.71'
 - (B) S 30°13'09" E 40.41'
 - (C) S 62°00'51" W 17.78'
 - (D) N 57°02'05" W 5.02'
 - (E) S 57°29'02" E 350.04'

DITCH CONSTRUCTION - RIGHT			
STATION	SIZE-SHAPE TYPE	LINING	
		TYPE	QUANTITY
120+00 TO 122+34	NORMAL DT.	TRM I	269 S.Y.
122+34 TO 123+33	2' F.B. SURF. DT.	TRM I	145 S.Y.
124+21.61	2' F.B. OUTLET	TRM I	70 S.Y.
123+29.19 TO 124+80	2' F.B. SURF. DT.	TRM I	396 S.Y.
124+80 TO 130+79	NORMAL DT.	TRM I	659 S.Y.
130+79 TO 135+00	2' F.B. SURF. DT.	TRM I	533 S.Y.
134+94.66	2' F.B. OUTLET	CL III	30 TONS

REMOVE GUARDRAIL
 RT. STA. 132+76.20 TO STA. 135+00,
 REMOVE 224 L.F.

STEEL "W" BEAM GUARDRAIL
 RT. STA. 132+21.41 TO STA. 135+00,
 CONST. 241.08 L.F. W/1 END TREATMENT TY. 4A

R/W MONUMENT - TYPE 1
 RT. STA. 120+00 TO STA. 135+00,
 CONST. 8

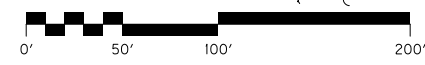

SCALE: 1"=50'

RIGHT OF WAY PLANS


PLAN SHEET
 KY 146 RELOCATION
 STA. 120+00 TO STA. 135+00

FILE NAME: I:\3886-KY 146 HENRY-PHASE 2\SEGMENT 1\SENT.2014-12-12 ROW SET\PLAN\ROOT\00PL.DGN
 USER: TRobinson
 DATE PLOTTED: December 8, 2014
 E-SHEET NAME:
 MicroStation v8.11.7.443

MicroStation v8.11.7.443 E-SHEET NAME: DATE PLOTTED: December 8, 2014 FILE NAME: I:\3886-KY 146 HENRY\PHASE 2\SEGMENT 1\SHEETS\PROFILES\RO0800PR.DGN USER: TRobinson

COUNTY OF	ITEM NO.	SHEET NO.
HENRY	5-8300.00	RO08

**RIGHT OF WAY
PLANS**

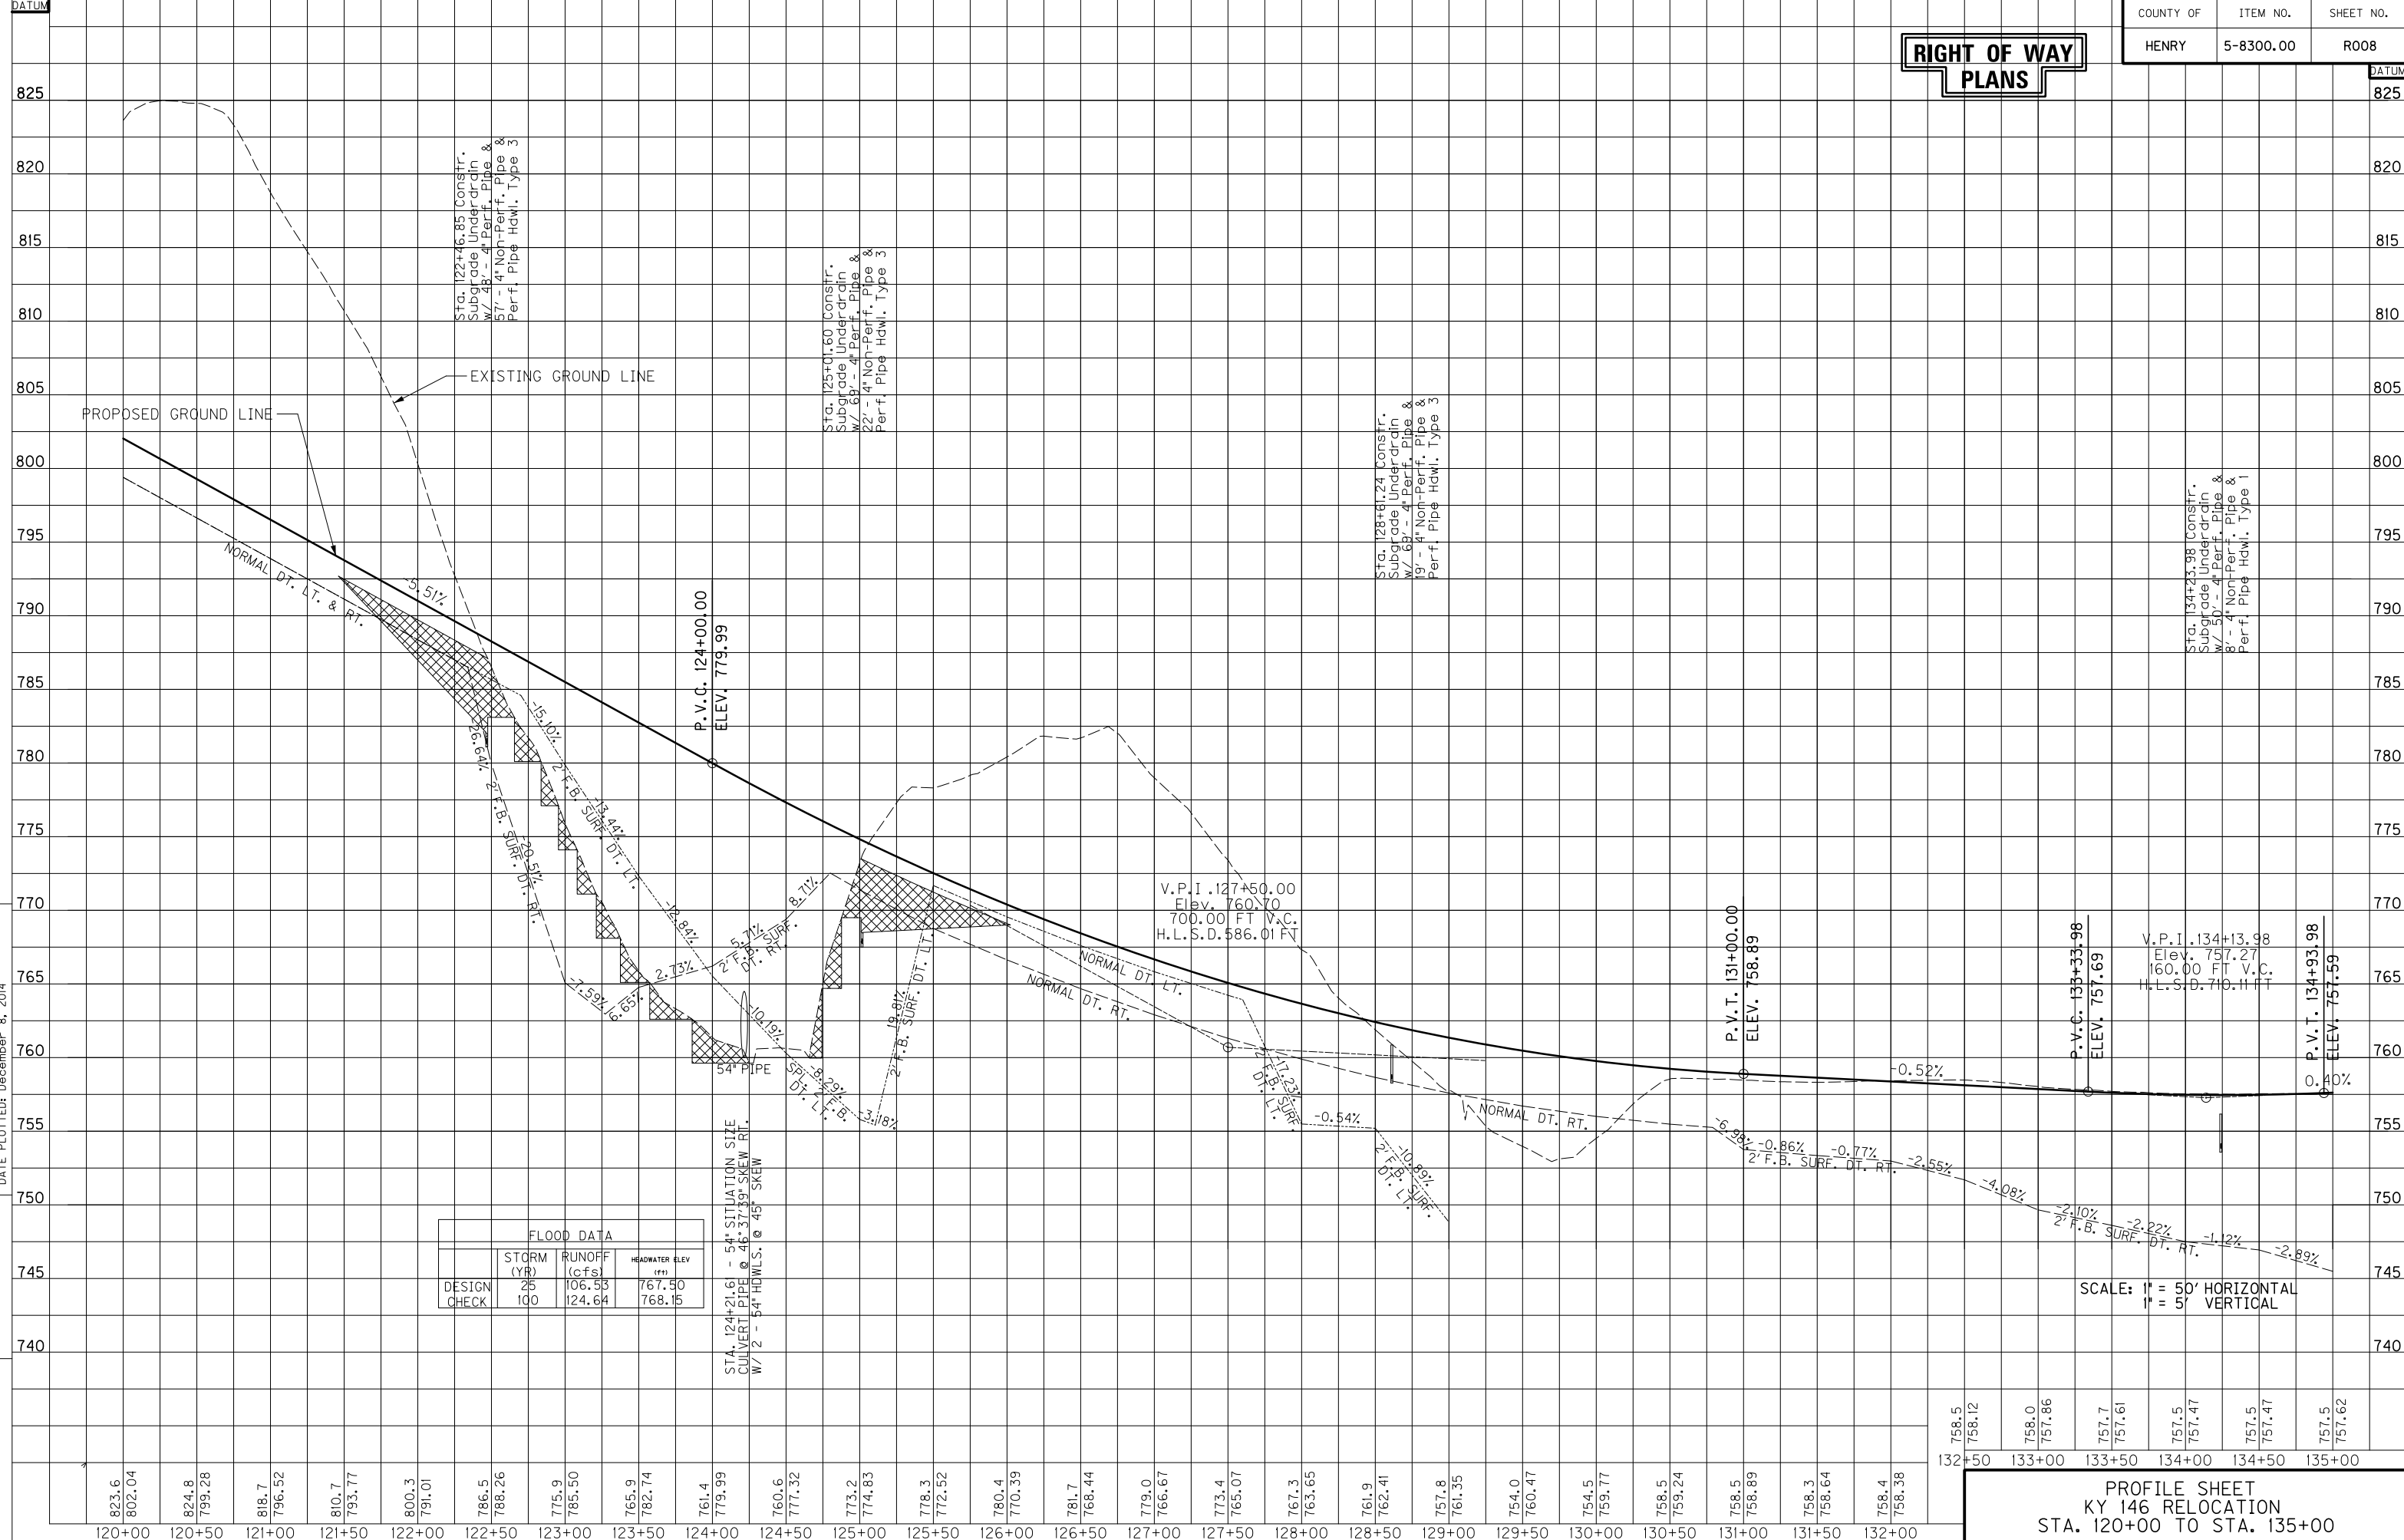

SCALE: 1" = 50' HORIZONTAL
1" = 5' VERTICAL

**PROFILE SHEET
KY 146 RELOCATION
STA. 120+00 TO STA. 135+00**

758.5	758.12	758.0	757.86	757.7	757.61	757.5	757.47	757.5	757.47	757.5	757.62
132+50	133+00	133+50	134+00	134+50	135+00						

RIGHT OF WAY PLANS

RIGHT OF WAY CALLS

- (A) S 51°18'04" E 522.07'
- (B) RADIUS = 810.00'
ARC LENGTH = 327.15'
CHORD LENGTH = 324.93'
BEARING = S 77°03'06" E
- (C) S 4°45'16" E 128.31'
- (D) S 88°37'21" E 350.01'
- (E) S 73°31'55" W 106.74'
- (F) N 73°34'34" W 66.53'
- (G) N 73°34'34" W 9.67'
- (H) RADIUS = 730.00'
ARC LENGTH = 162.04'
CHORD LENGTH = 161.71'
BEARING = N 70°17'11" W
- (I) S 19°49'32" E 47.94'
- (J) S 19°49'32" E 78.93'
- (K) N 88°37'21" W 45.88'
- (L) RADIUS = 730.00'
ARC LENGTH = 4.64'
CHORD LENGTH = 4.64'
BEARING = N 88°26'25" W
- (M) S 1°38'10" E 103.25'
- (N) N 19°49'32" W 158.14'
- (O) S 35°38'49" W 86.04'
- (P) N 88°37'21" W 68.25'

DITCH CONSTRUCTION - LEFT			
STATION	SIZE-SHAPE TYPE	LINING	
		TYPE	QUANTITY
135+00 TO 135+36.12	2' F.B. SURF. DT.	CL. II	25 TONS
138+50 TO 140+50	2' F.B. SURF. DT.	TRM I	304 S.Y.
140+50 TO 142+50*	SPL. 2' F.B. DT.	TRM I	441 S.Y.
ROSEHILL LANE 9+45.85 LT.	2' F.B. INLET	CL. III	20 TONS
ROSEHILL LANE 9+45.85 RT.*	2' F.B. OUTLET	CL. II	13 TONS
143+50 TO 144+00	SPL. 2' F.B. DT.	TRM I	62 S.Y.
144+00 TO 146+50	NORMAL DT.	TRM I	303 S.Y.
146+50 TO 149+39.60	NORMAL DT.	TRM I	264 S.Y.
149+33.91	2' F.B. INLET	TRM I	24 S.Y.
149+73.48 ENTR. RT.*	SPL. 2' F.B. DT.	TRM I	29 S.Y.
149+73.48 ENTR.	2' F.B. OUTLET	TRM II	10 S.Y.
149+73.48 ENTR.	2' F.B. INLET	TRM I	6 S.Y.
ROSEHILL LANE			
7+50 LT TO 8+30.24 LT	SPL. 2' F.B. DT.	TRM I	91 S.Y.
8+64.77 LT TO 9+49.89 LT	SPL. 2' F.B. DT.	ECB	139 S.Y.
9+08.89 LT TO 9+49.89 LT	SPL. 2' F.B. DT.	TRM I	39 S.Y.
7+50 RT TO 9+00 RT	NORMAL DT.	ECB	209 S.Y.
9+00 RT TO 9+51.47 RT	SPL. 2' F.B. DT.	ECB	68 S.Y.
8+45.43 ENTR. LT.	SPL. 2' F.B. DT.	TRM I	47 S.Y.
8+45.43 ENTR. LT.	SPL. 2' F.B. DT.	TRM I	65 S.Y.

ISLAND HEADER CURB TY 2
 LT. STA. 135+00 TO STA. 135+05.40,
 CONST. 5.50 L.F.

LT. STA. 136+33.88 TO STA. 136+59.07,
 CONST. 25.00 L.F.

STEEL "W" BEAM GUARDRAIL
 LT. STA. 135+00 TO STA. 135+05.40,
 CONST. 5.40 L.F. W/1 GUARDRAIL
 BRIDGE CONNECTOR TYPE A

LT. STA. 136+34.07 TO STA. 139+23.19,
 CONST. 250.00 L.F. W/1 GUARDRAIL
 BRIDGE CONNECTOR TYPE A AND
 1 END TREATMENT TYPE 4A

REMOVE PAVEMENT
 RT. STA. 143+63.28 TO RT. STA. 148+52.22
 REMOVE 1,050 SQ. YD. OF EXISTING PAVEMENT

R/W MONUMENT - TYPE I
 LT. STA. 135+00 TO STA. 150+00,
 CONST. 11

REMOVE GUARDRAIL
 LT. STA. 135+00 TO STA. 135+08.48,
 REMOVE 9 L.F.

LT. STA. 136+36.71 TO STA. 138+80.77,
 REMOVE 244 L.F.

ENTRANCE CONSTRUCTION - LEFT									
STATION	ENTRANCE TYPE	ENTR. WIDTH (FT)	AREA (SQ YD)	CEM. CON. ENT. PVMT. 8" (SQ. YDS.)	ASPHALT SURFACE (TONS)	ASPHALT BASE (TONS)	CSB (TONS)	ENTR. PIPE (FT)	HDWL
149+73	RESIDENTIAL	15	129	--	9	23	31	47' of 24" PIPE	--
149+73	RESIDENTIAL	12	70	--	5	13	17	41' of 15" PIPE	--
ROSEHILL LANE									
8+46 LT.	RESIDENTIAL	12	108	--	7	20	26	39' of 15" PIPE	--


* - DEPTH TO PROTECT = 1.5'

* - DEPTH TO PROTECT = 2.0'

ENTRANCE CONSTRUCTION - RIGHT									
STATION	ENTRANCE TYPE	ENTR. WIDTH (FT)	AREA (SQ YD)	CEM. CON. ENT. PVMT. 8" (SQ. YDS.)	ASPHALT SURFACE (TONS)	ASPHALT BASE (TONS)	CSB (TONS)	ENTR. PIPE (FT)	HDWL
143+00	RESIDENTIAL	12	117	--	8	21	28	--	--
146+74	RESIDENTIAL	12	74	--	5	13	18	--	--

DITCH CONSTRUCTION - RIGHT			
STATION	SIZE-SHAPE TYPE	LINING	
		TYPE	QUANTITY
135+00 TO 135+32.44	2' F.B. SURF. DT.	TRM I	32 S.Y.
144+00 TO 146+50	2' F.B. SURF. DT.	ECB	348 S.Y.
148+91.35*	2' F.B. OUTLET	CL. II	26 TONS


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 USER: TROBINSON
 DATE PLOTTED: December 8, 2014
 E-SHEET NAME:
 MicroStation v8.11.7.443

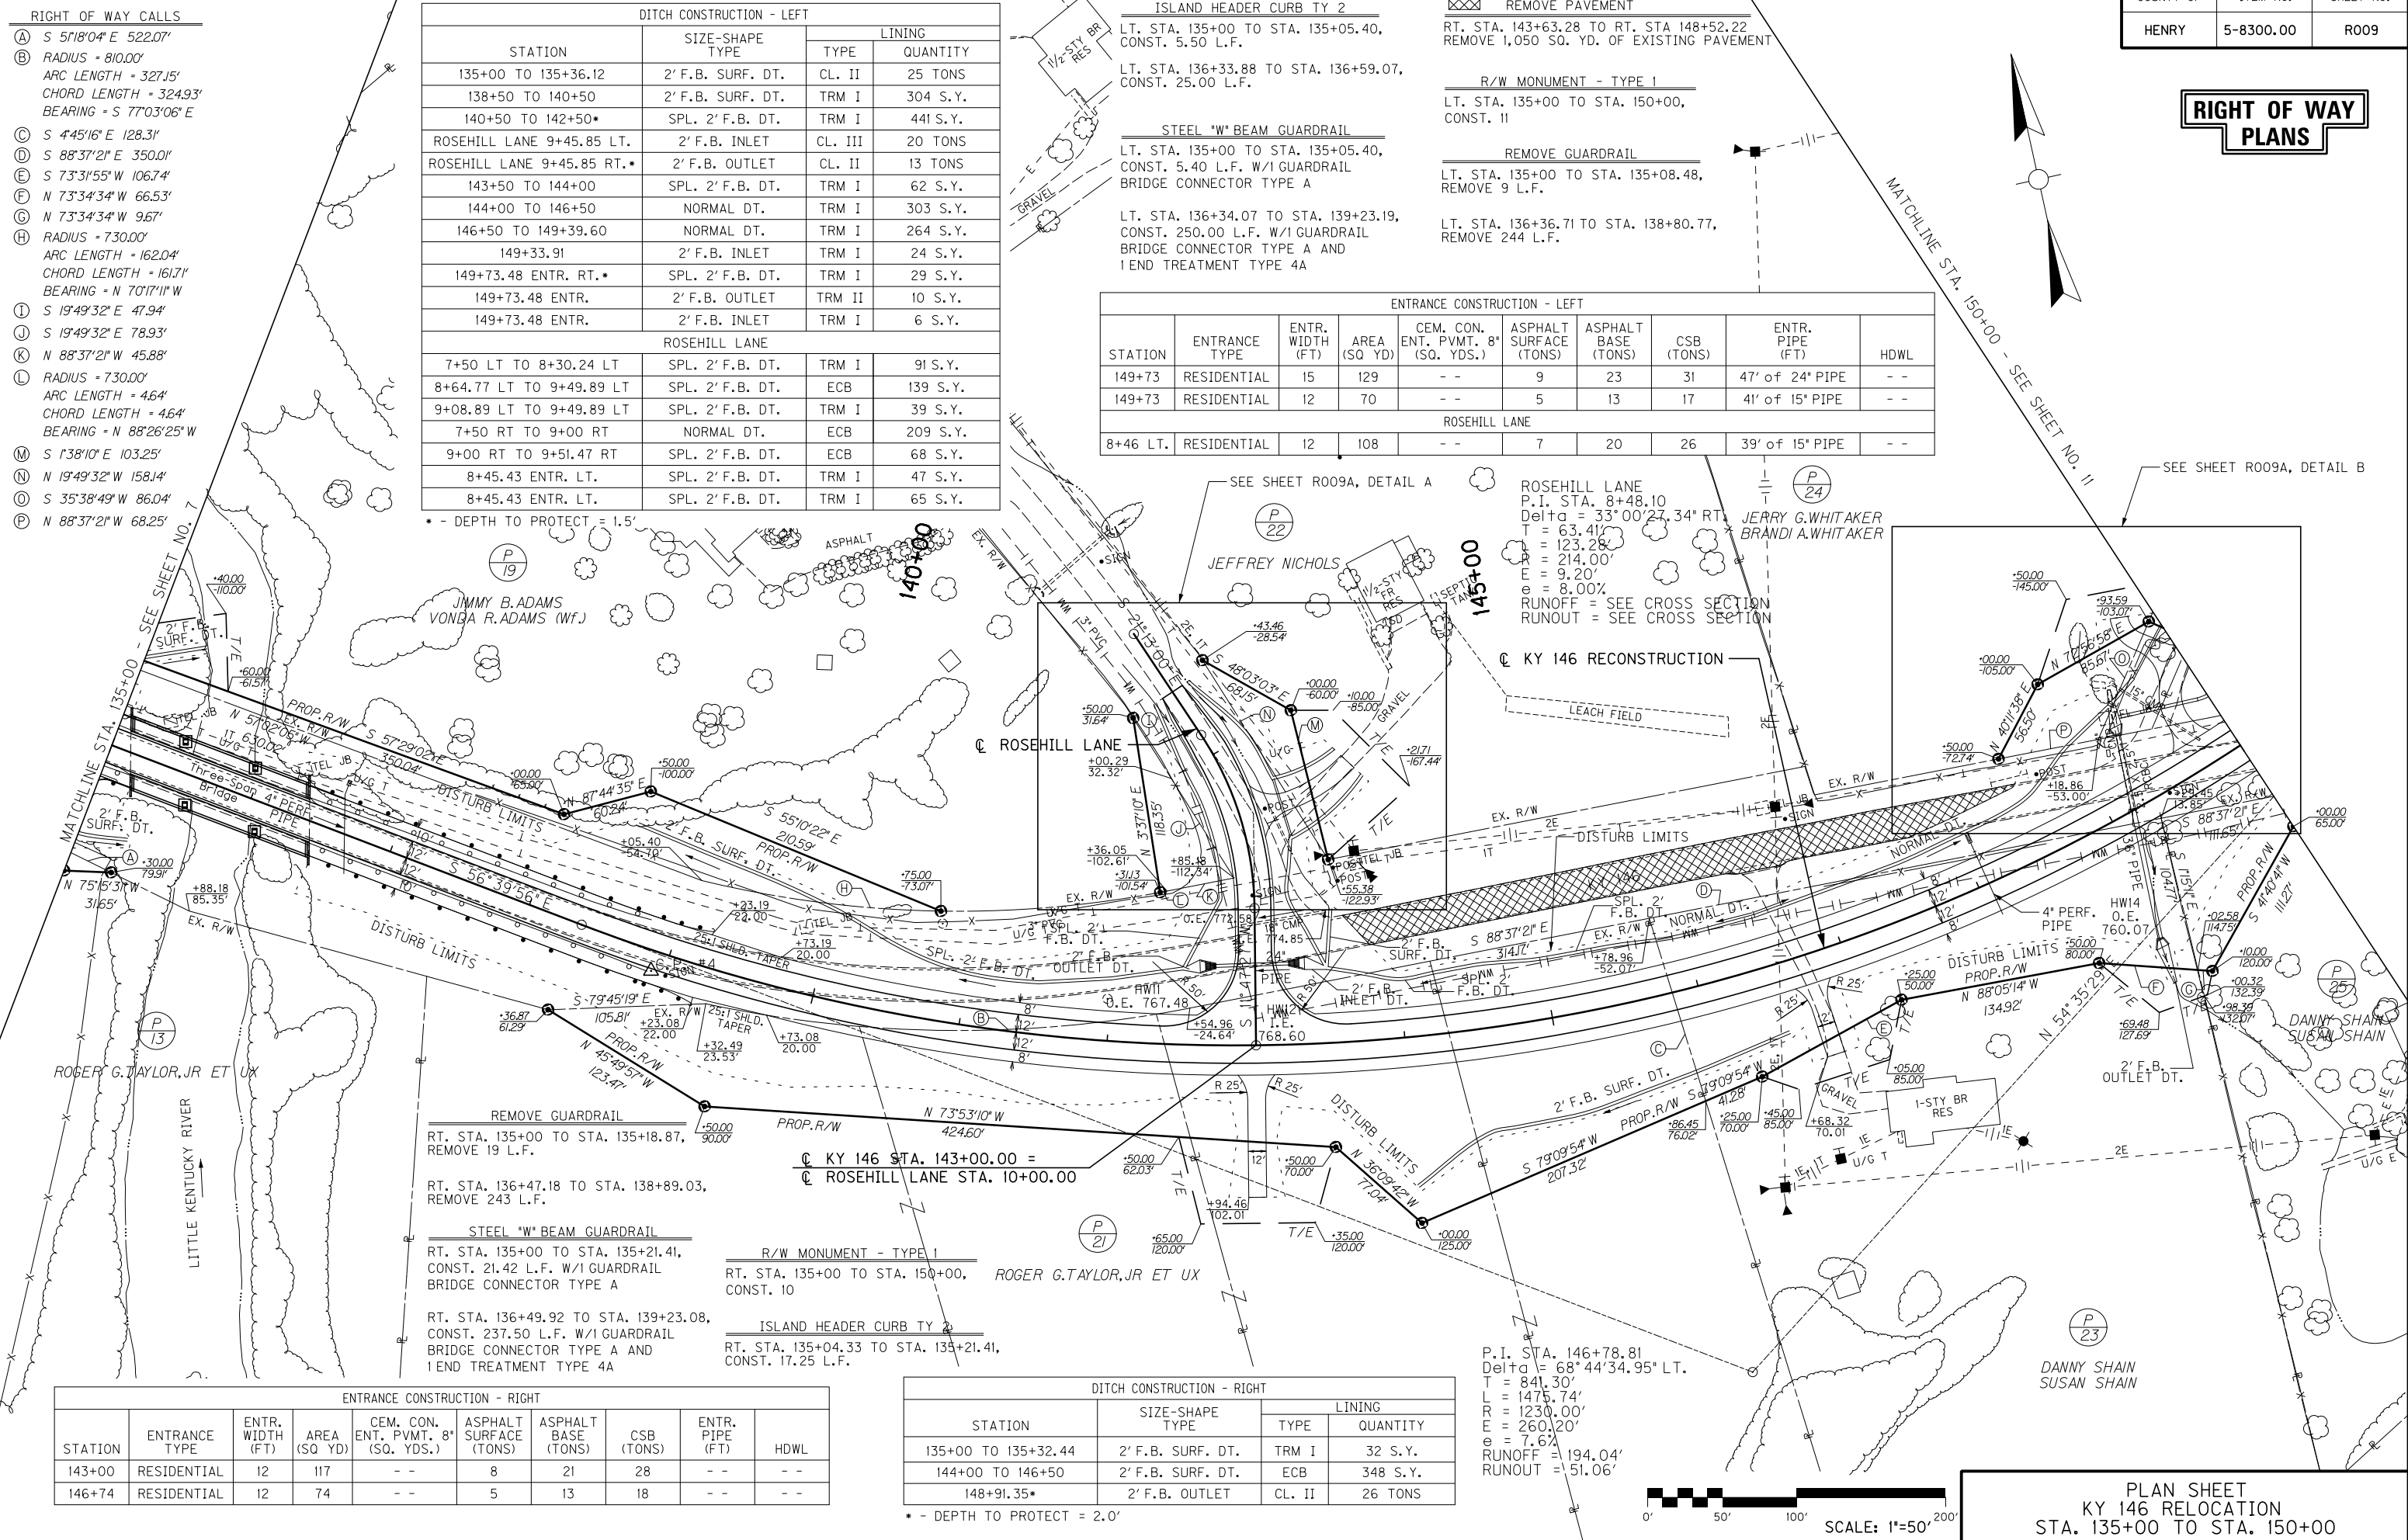


COUNTY OF	ITEM NO.	SHEET NO.
HENRY	5-8300.00	RO09A

**RIGHT OF WAY
PLANS**

DETAIL A

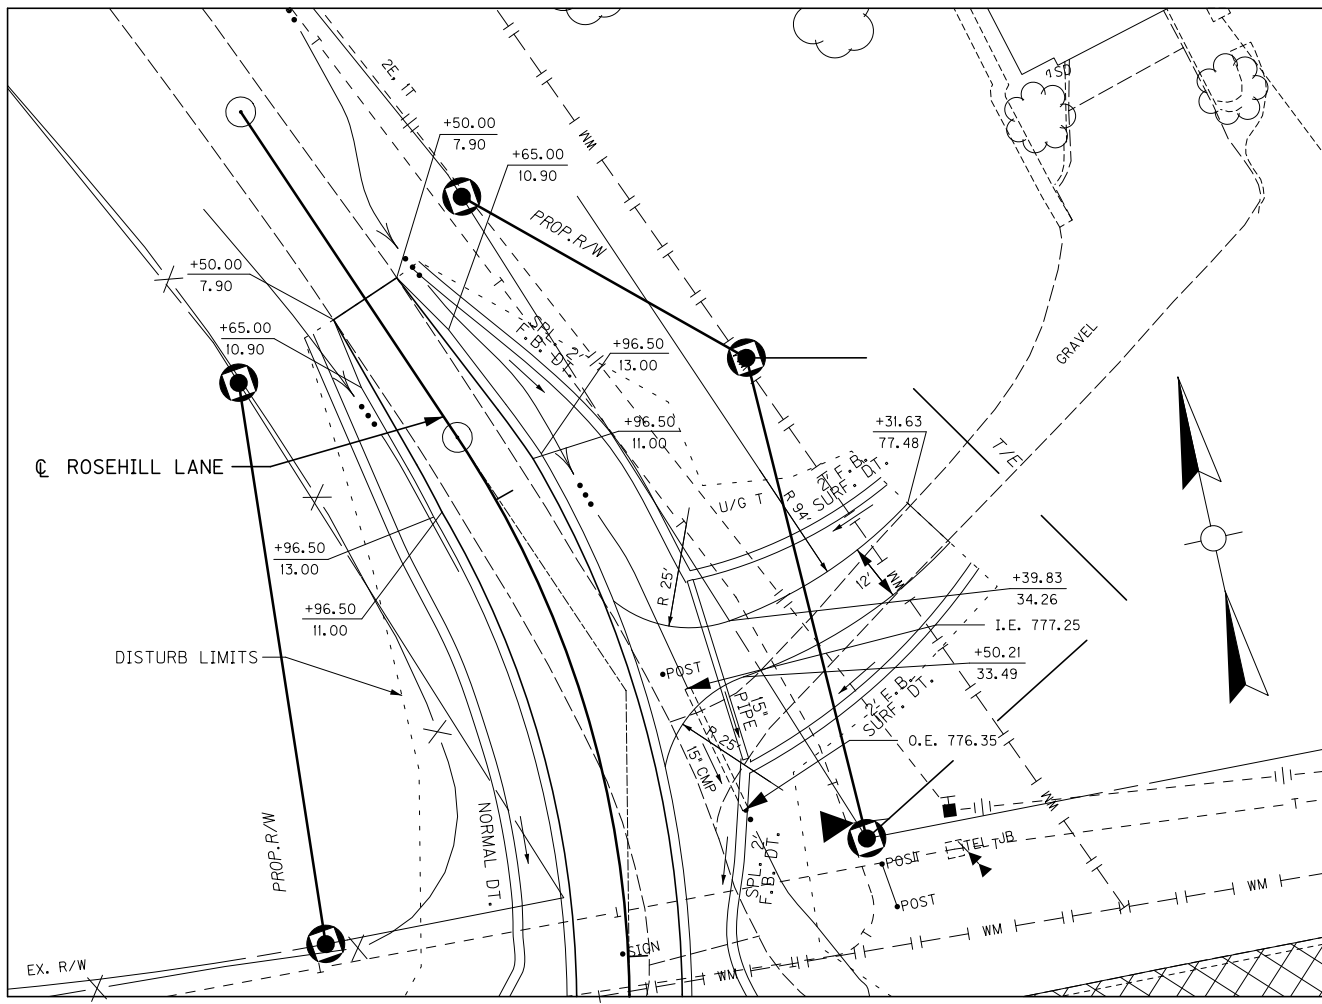

DETAIL B

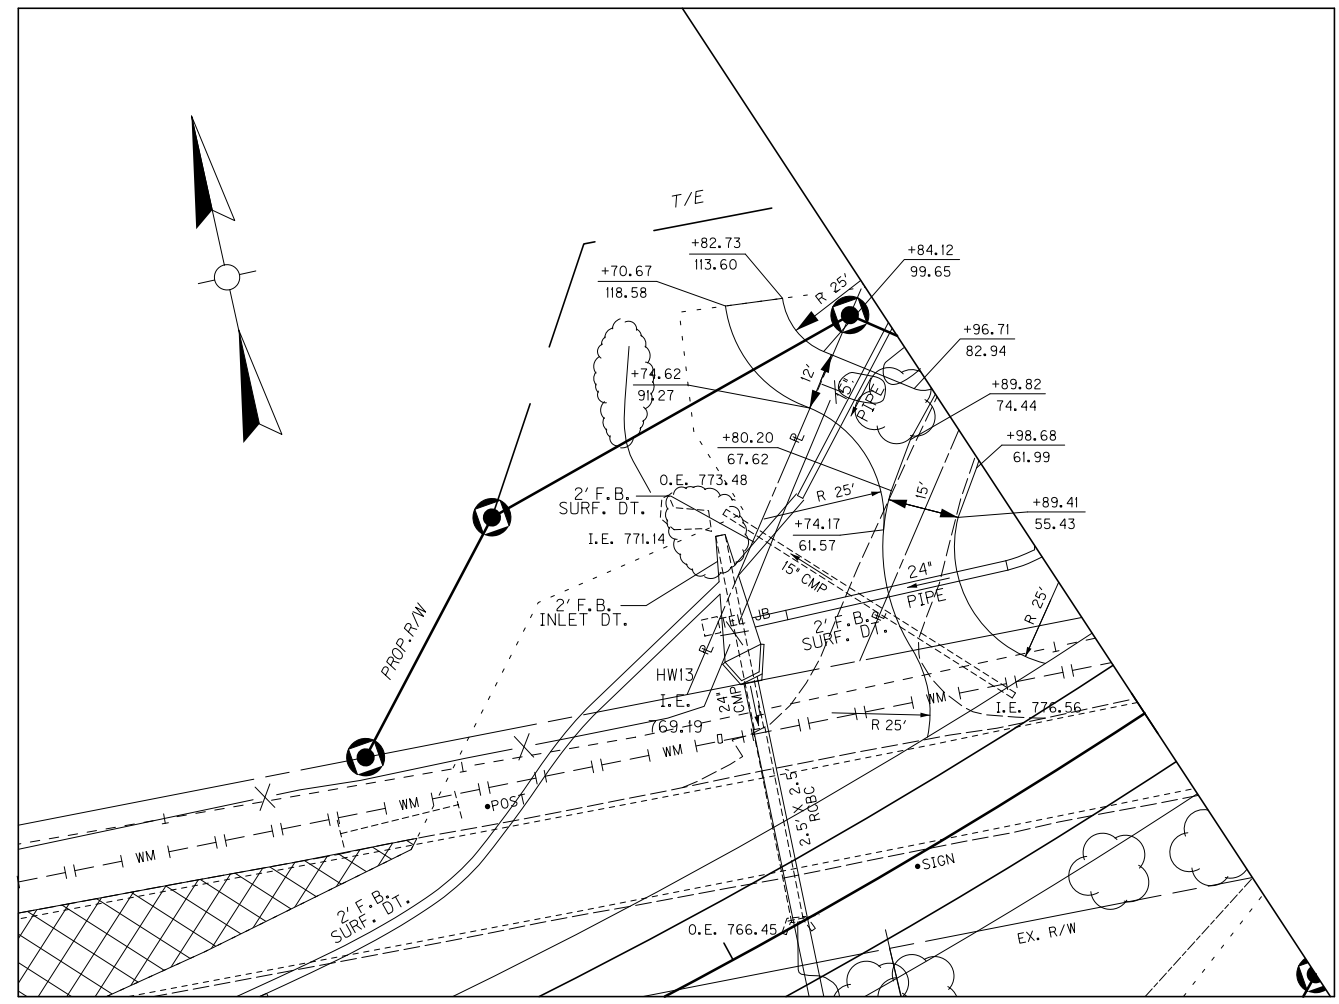

FILE NAME: I:\3886-KY 146 HENRY PHASE 2\SEGMENT 1\SENT\2014-12-12 ROW SET\PLAN\RO09A\PL-DGN

USER: TRobinson
DATE PLOTTED: December 8, 2014

E-SHEET NAME:

MicroStation v8.11.7.443


SCALE: 1"=20'

PLAN SHEET
KY 146 RELOCATION
STA. 135+00 TO STA. 150+00

MicroStation v8.11.7.443 E-SHEET NAME: DATE PLOTTED: December 8, 2014 USER: TRobinson FILE NAME: I:\3886-KY 146 HENRY PHASE 2 SEGMENT 1\ SHEETS\PROFILES\ROD000PR.DGN

COUNTY OF	ITEM NO.	SHEET NO.
HENRY	5-8300.00	RO10

**RIGHT OF WAY
PLANS**

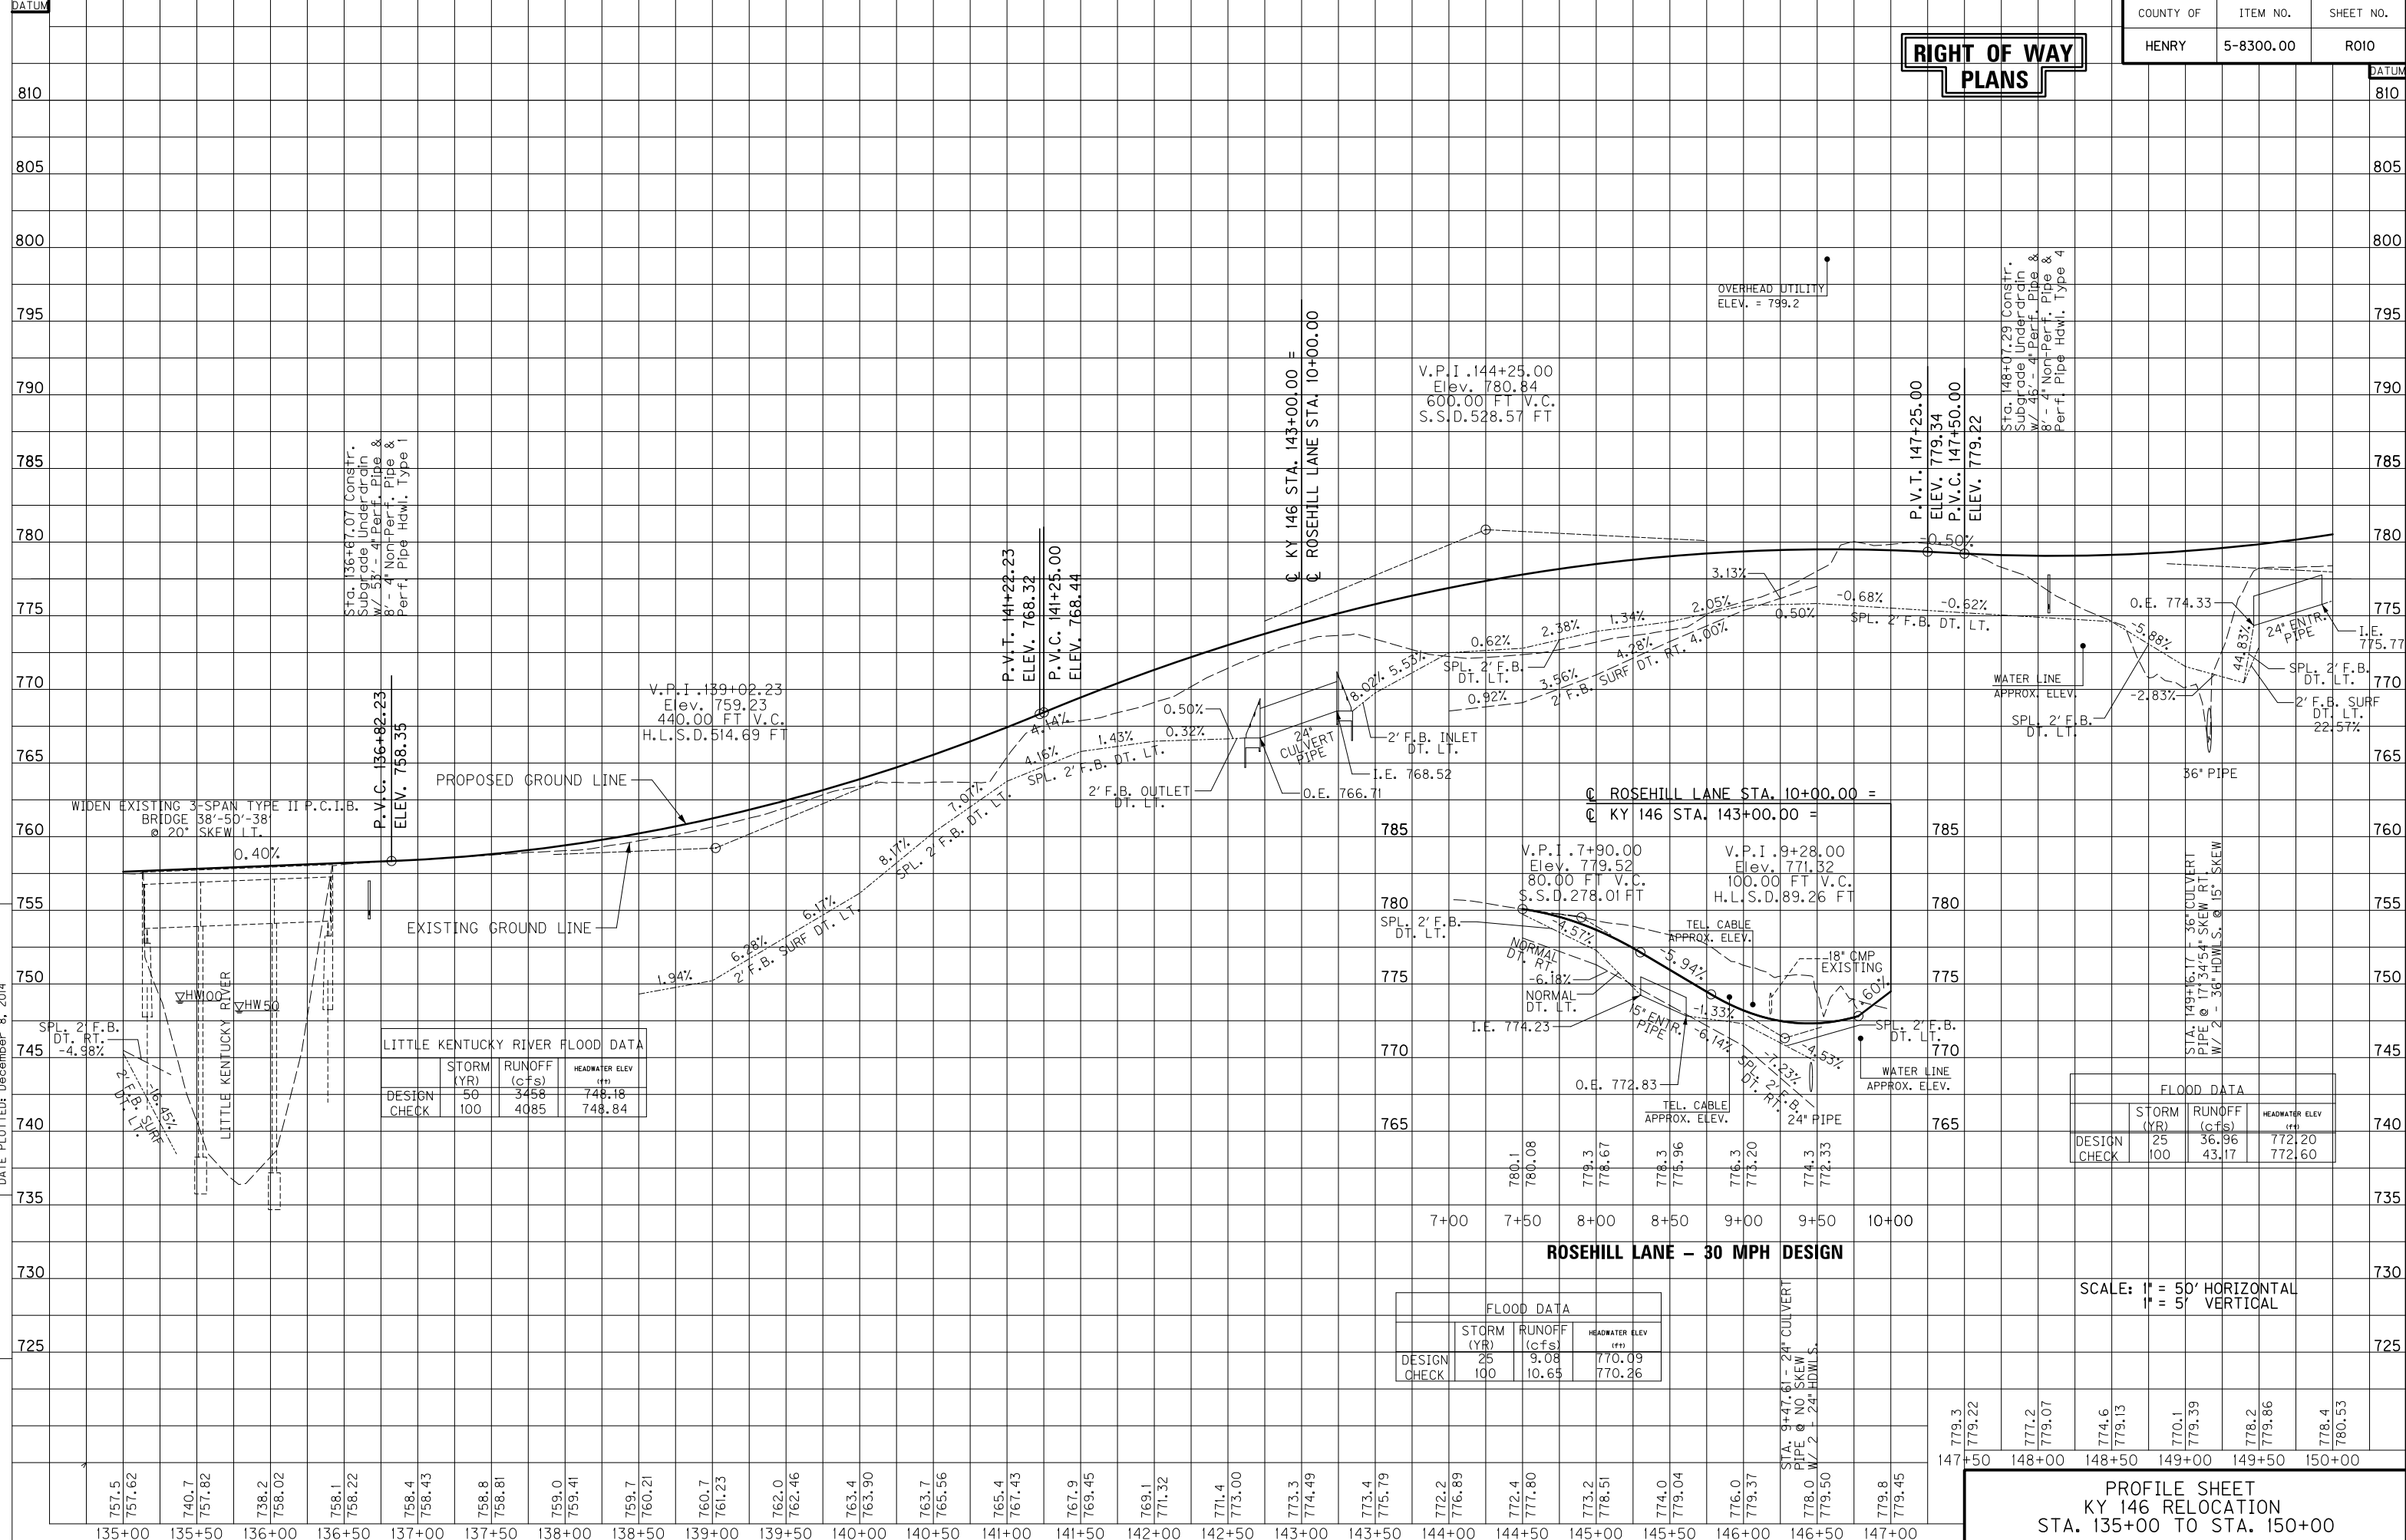

LITTLE KENTUCKY RIVER FLOOD DATA

DESIGN	STORM (YR)	RUNOFF (cfs)	HEADWATER ELEV (ft)
CHECK	50	3458	748.18
	100	4085	748.84

FLOOD DATA

DESIGN	STORM (YR)	RUNOFF (cfs)	HEADWATER ELEV (ft)
CHECK	25	36.96	772.20
	100	43.17	772.60

FLOOD DATA

DESIGN	STORM (YR)	RUNOFF (cfs)	HEADWATER ELEV (ft)
CHECK	25	9.08	770.09
	100	10.65	770.26

ROSEHILL LANE - 30 MPH DESIGN

SCALE: 1" = 50' HORIZONTAL
1" = 5' VERTICAL

**PROFILE SHEET
KY 146 RELOCATION
STA. 135+00 TO STA. 150+00**

757.5 757.62 740.7 757.82 738.2 758.02 758.1 758.22 758.4 758.43 758.8 758.81 759.0 759.41 759.7 760.21 760.7 761.23 762.0 762.46 763.4 763.90 763.7 765.56 765.4 767.43 767.9 769.45 769.1 771.32 771.4 773.00 773.3 774.49 773.4 775.79 772.2 776.89 772.4 777.80 773.2 778.51 774.0 779.04 776.0 779.37 778.0 779.50 779.8 779.45

780.1	780.08	779.3	778.67	778.3	775.96	776.3	773.20	774.3	772.35
7+00	7+50	8+00	8+50	9+00	9+50	10+00			

RIGHT OF WAY PLANS

RIGHT OF WAY CALLS

(A) S 54°01'00" E 48.88'	(D) S 88°37'21" E 111.65'
(B) RADIUS = 1529.65'	(E) RADIUS = 1589.65'
ARC LENGTH = 459.78'	ARC LENGTH = 188.03'
CHORD LENGTH = 458.05'	CHORD LENGTH = 187.92'
BEARING = S 80°04'46" W	BEARING = N 85°21'11" E
(C) N 88°37'21" W 141.52'	(F) S 77°31'26" W 107.93'

R/W MONUMENT - TYPE 1
 LT. STA. 150+00 TO STA. 165+00,
 CONST. 7

COUNTY OF	ITEM NO.	SHEET NO.
HENRY	5-8300.00	ROLL

DITCH CONSTRUCTION - LEFT


STATION	SIZE-SHAPE TYPE	LINING	
		TYPE	QUANTITY
149+73.48 ENTR. RT.	SPL. 2' F.B. DT.	ECB	43 S.Y.
PARCEL 24 ENTR. RT.	SPL. 2' F.B. DT.	ECB	11 S.Y.
150+00 TO 150+50	SPL. 2' F.B. DT.	TRM I	57 S.Y.
150+50 TO 154+50	NORMAL DT.	TRM I	449 S.Y.
154+50 TO 156+50	NORMAL DT.	ECB	322 S.Y.
156+50 TO 158+00	SPL. 2' F.B. DT.	ECB	242 S.Y.
158+00 TO 159+50	SPL. 2' F.B. DT.	ECB	242 S.Y.
159+50 TO 160+13.72	2' F.B. SURF. DT.	TRM I	68 S.Y.
160+32.80	2' F.B. INLET	TRM I	24 S.Y.
160+13.72 TO 161+00	2' F.B. SURF. DT.	ECB	121 S.Y.
161+00 TO 165+00	NORMAL DT.	ECB	652 S.Y.

DITCH CONSTRUCTION - RIGHT

STATION	SIZE-SHAPE TYPE	LINING	
		TYPE	QUANTITY
152+62.28 TO 154+50	2' F.B. SURF. DT.	TRM I	178 S.Y.
154+50 TO 157+00	NORMAL DT.	TRM I	287 S.Y.
159+19 TO 159+50	SPL. 2' F.B. DT.	TRM I	28 S.Y.
159+50 TO 159+96.91	2' F.B. SURF. DT.	TRM I	57 S.Y.
159+96.91 TO 161+00	2' F.B. SURF. DT.	TRM I	110 S.Y.
160+04.80	2' F.B. OUTLET	CL. III	30 TONS
161+00 TO 161+90	SPL. 2' F.B. DT.	ECB	157 S.Y.
CONNECTOR NO. 2			
11+00 TO 13+00	SPL. 2' F.B. DT.	TRM I	169 S.Y.
13+00 TO 13+09.07	SPL. 2' F.B. DT.	TRM I	8 S.Y.


ENTRANCE CONSTRUCTION - RIGHT

STATION	ENTRANCE TYPE	ENTR. WIDTH (FT)	AREA (SQ YD)	CEM. CON. ENT. PVMT. 8" (SQ YDS.)	ASPHALT SURFACE (TONS)	ASPHALT BASE (TONS)	CSB (TONS)	ENTR. PIPE (FT)	HDWL
150+37	RESIDENTIAL	12	123	123	-	-	30	-	-

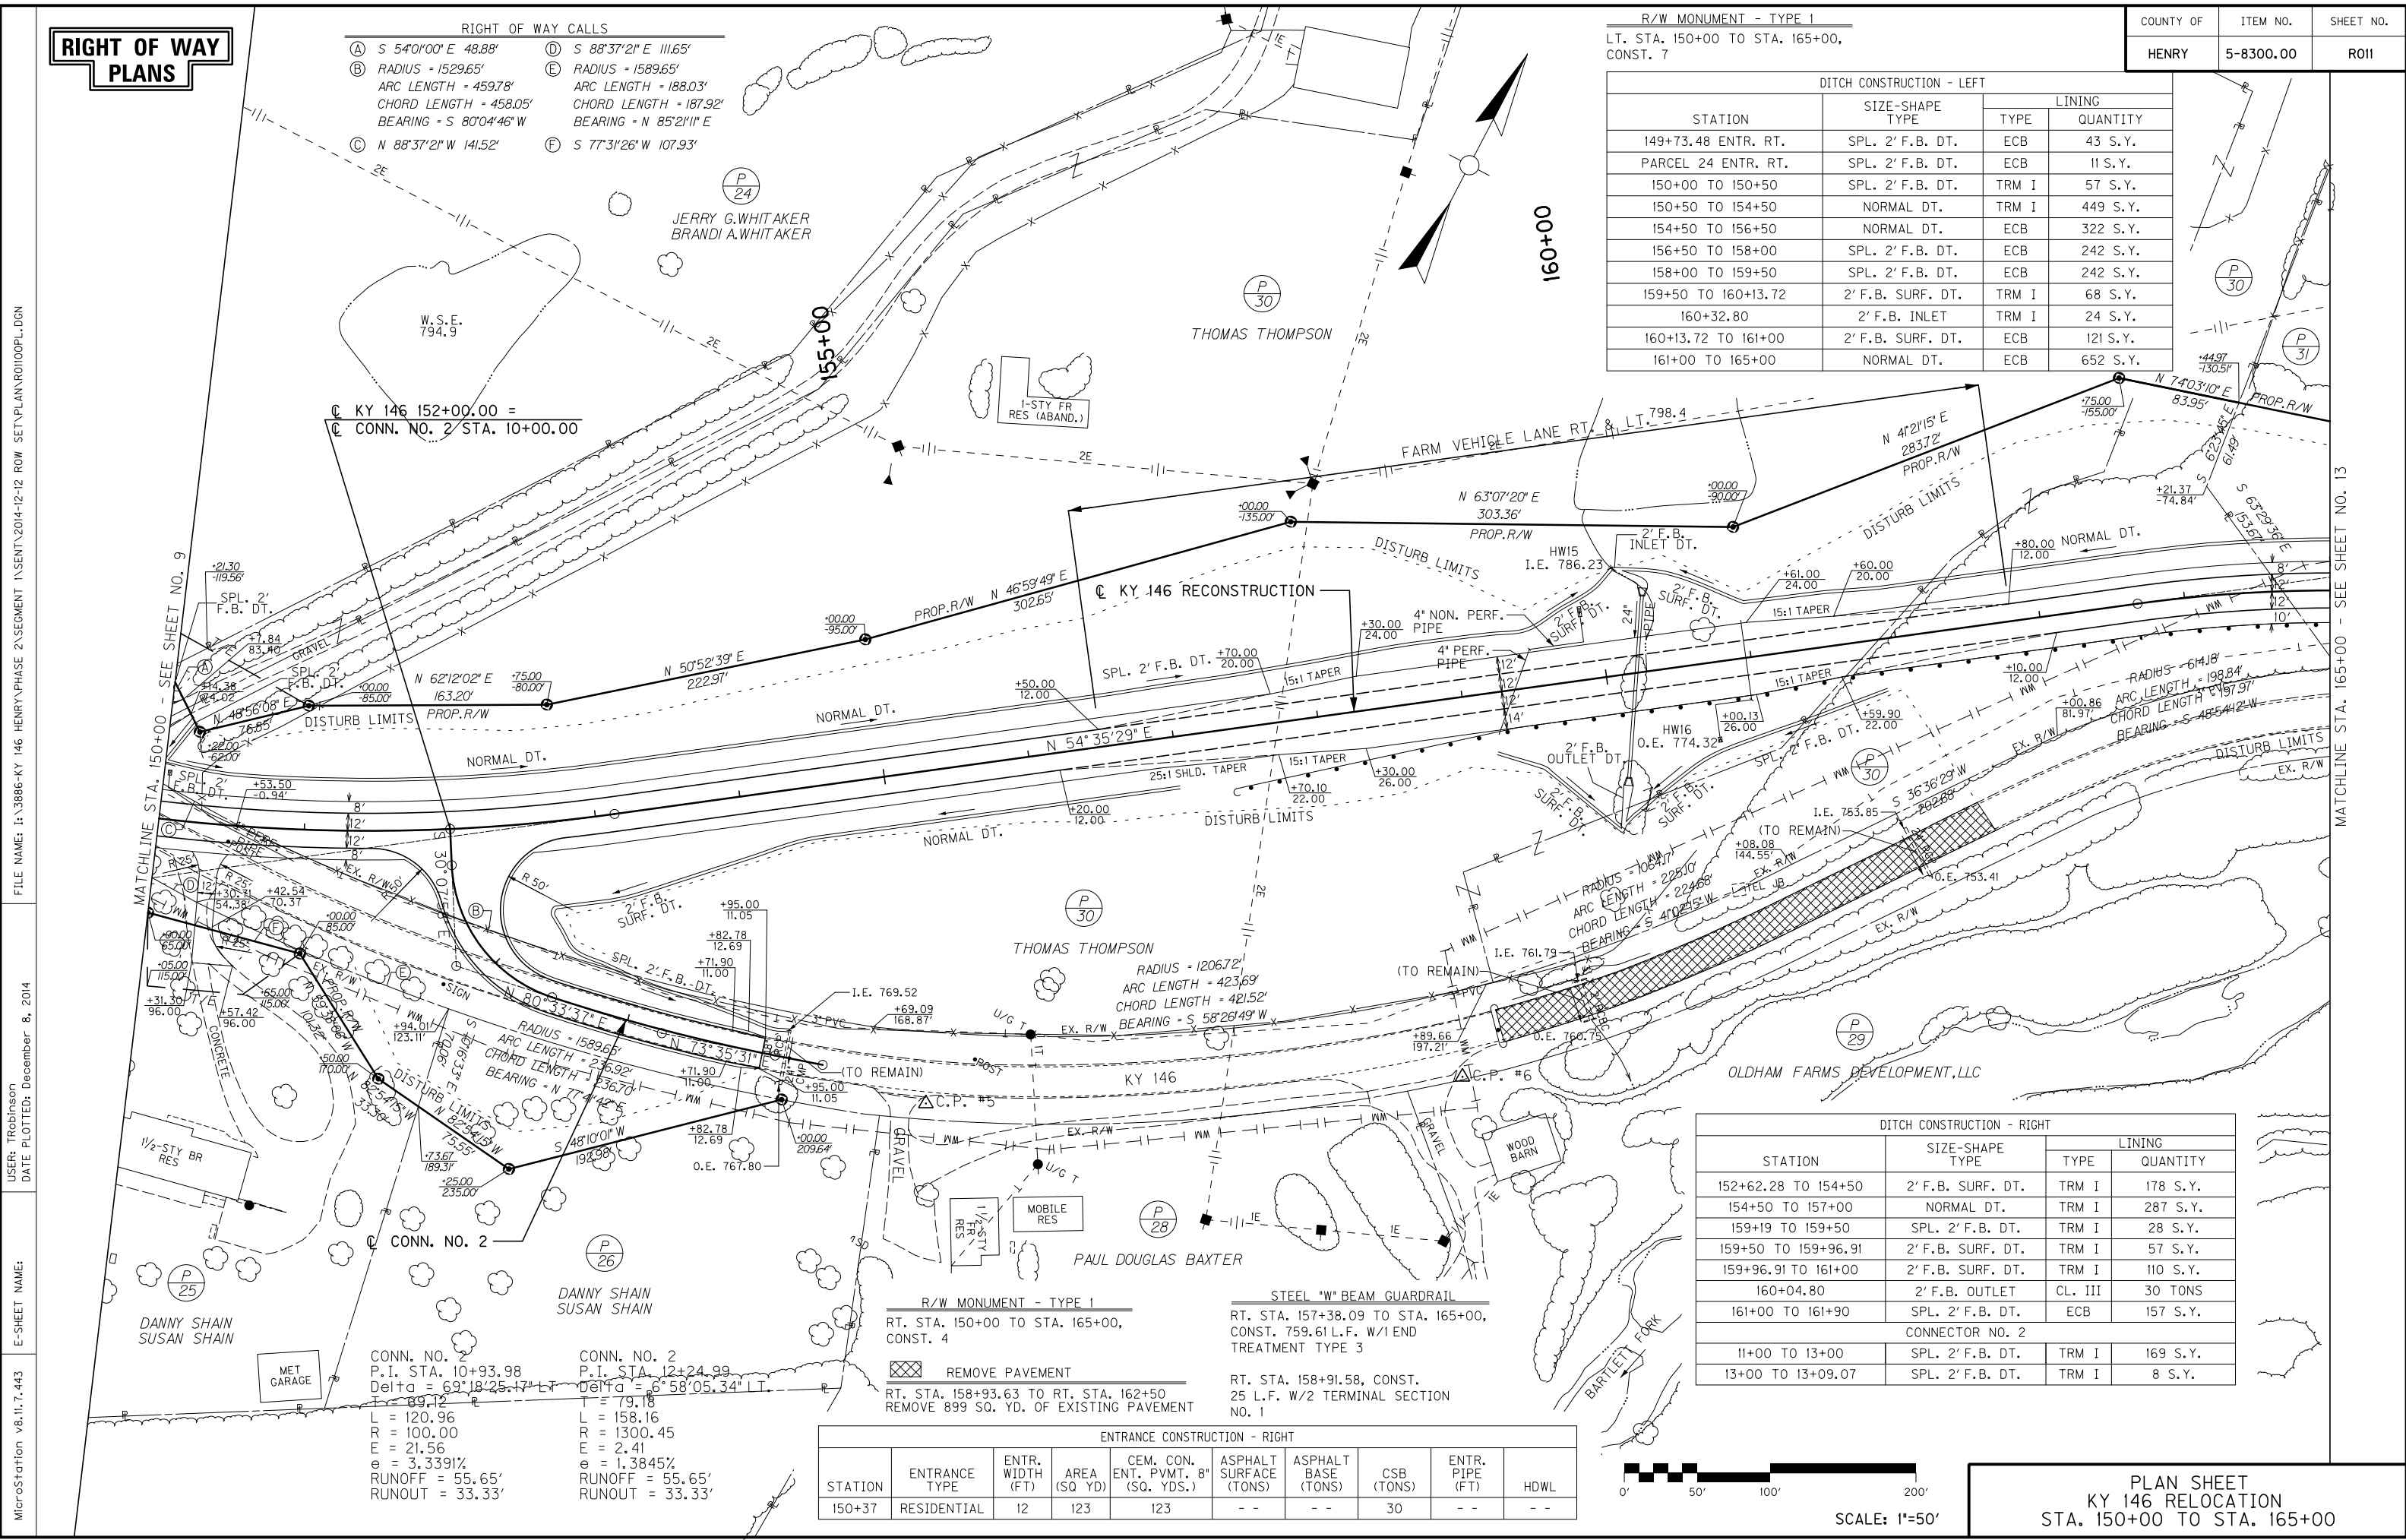


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 USER: TROBINSON
 DATE PLOTTED: December 8, 2014
 E-SHEET NAME:
 MicroStation v8.11.7.443

MATCHLINE STA. 165+00 - SEE SHEET NO. 13

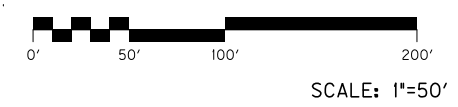

PLAN SHEET
 KY 146 RELOCATION
 STA. 150+00 TO STA. 165+00

**RIGHT OF WAY
PLANS**

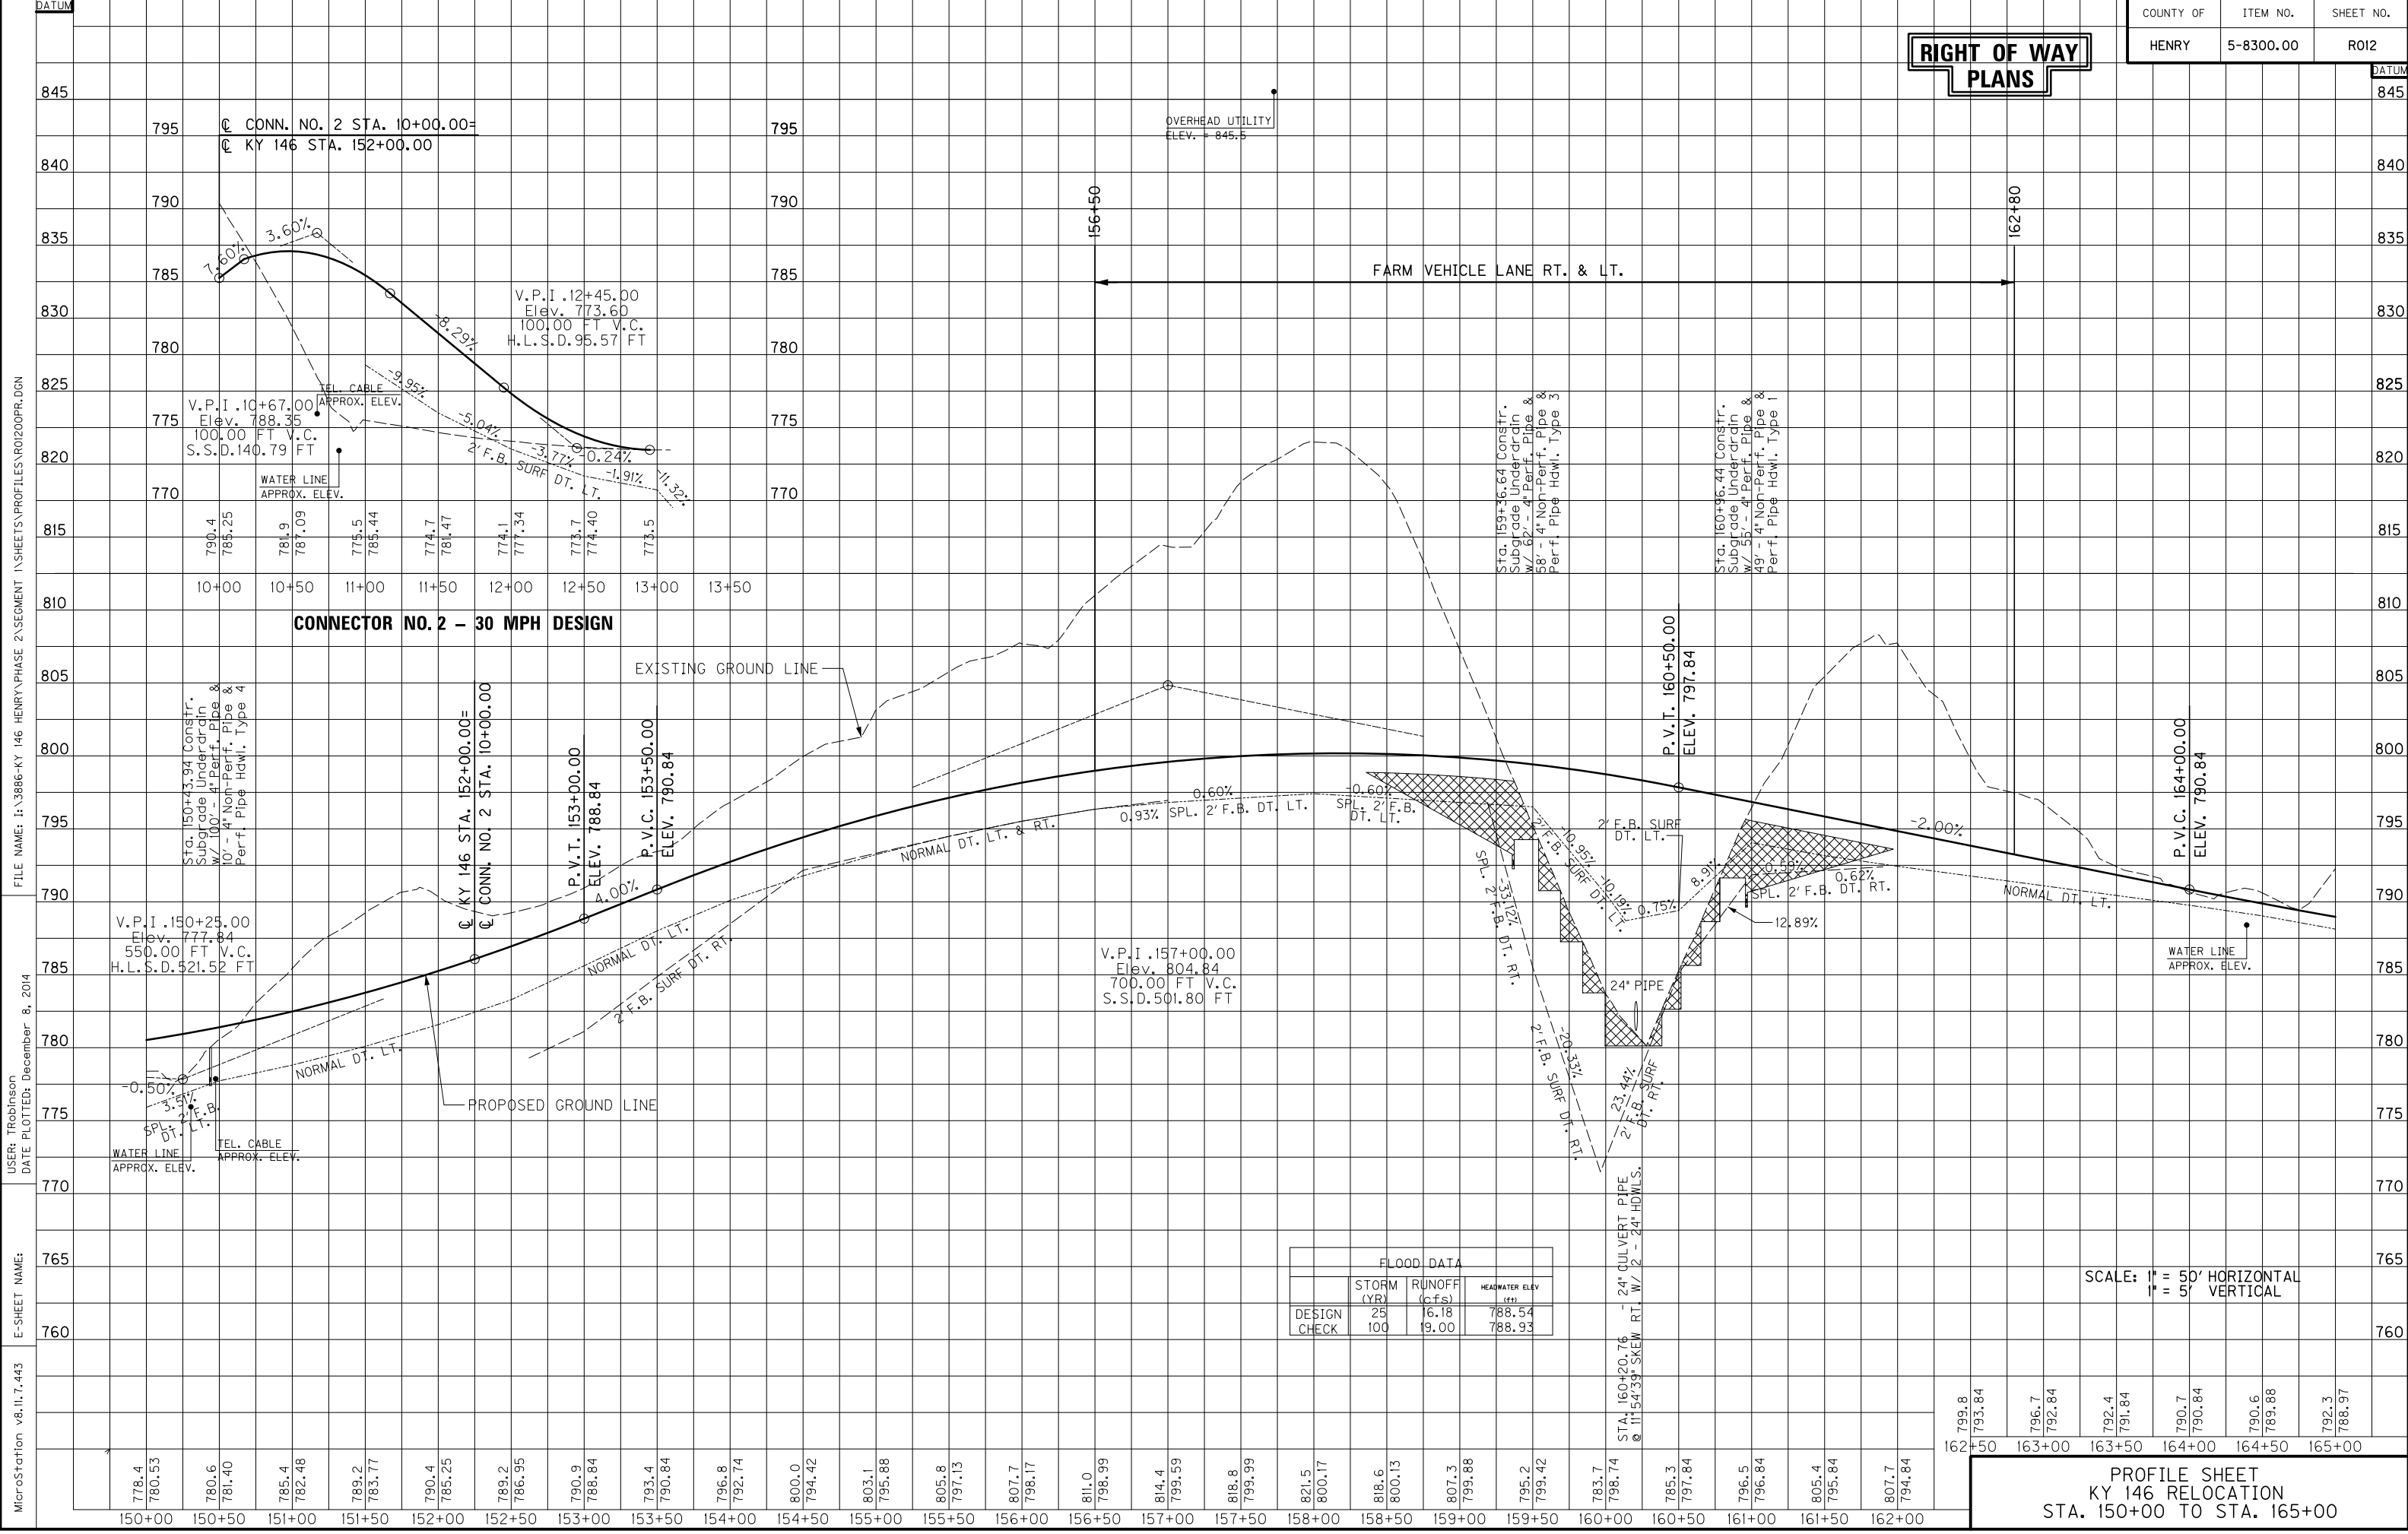

FILE NAME: I:\3886-KY 146 HENRY\PHASE 2\SEGMENT 1\SHEETS\PROFILES\RO12\PROF.DGN
 USER: Tr Robinson
 DATE PLOTTED: December 8, 2014
 E-SHEET NAME: MicroStation v8.11.7.443

FLOOD DATA		
STORM (YR)	RUNOFF (cfs)	HEADWATER ELEV (FEET)
DESIGN	25	16.18
CHECK	100	19.00
		788.54
		788.93

SCALE: 1" = 50' HORIZONTAL
1" = 5' VERTICAL

**PROFILE SHEET
KY 146 RELOCATION
STA. 150+00 TO STA. 165+00**

778.4 780.53 780.6 781.40 785.4 782.48 789.2 783.77 790.4 785.25 789.2 786.95 790.9 788.84 793.4 790.84 796.8 792.74 800.0 794.42 803.1 795.88 805.8 797.13 807.7 798.17 811.0 798.99 814.4 799.59 818.8 799.99 821.5 800.17 818.6 800.13 807.3 799.88 795.2 799.42 783.7 798.74 785.3 797.84 796.5 796.84 805.4 795.84 807.7 794.84
 150+00 150+50 151+00 151+50 152+00 152+50 153+00 153+50 154+00 154+50 155+00 155+50 156+00 156+50 157+00 157+50 158+00 158+50 159+00 159+50 160+00 160+50 161+00 161+50 162+00
 799.8 793.84 796.7 792.84 792.4 791.84 790.7 790.84 790.6 789.88 792.3 788.97
 162+50 163+00 163+50 164+00 164+50 165+00

RIGHT OF WAY PLANS

FILE NAME: I:\3886-KY 146 HENRY PHASE 2\SEGMENT 1\SENT\2014-12-12 ROW SET\PLAN\ROI300P.L.DGN

USER: TRobinson
DATE PLOTTED: December 8, 2014

E-SHEET NAME:

MicroStation v8.11.7.443

DITCH CONSTRUCTION - LEFT			
STATION	SIZE-SHAPE TYPE	LINING	
		TYPE	QUANTITY
165+00 TO 166+79	NORMAL DT.	ECB	299 S.Y.
166+79 TO 168+87.61	2' F.B. SURF. DT.	TRM I	131 S.Y.
167+83.21*	2' F.B. INLET	TRM I	32 S.Y.
167+87.61 TO 168+25	2' F.B. SURF. DT.	TRM I	83 S.Y.
168+25 TO 175+75	NORMAL DT.	ECB	1241 S.Y.
175+75 TO 176+01.79	2' F.B. SURF. DT.	TRM I	50 S.Y.
176+15.46**	2' F.B. INLET	TRM I	41 S.Y.
176+01.79 TO 176+50*	2' F.B. SURF. DT.	CL. III	63 TONS
176+50 TO 176+62.74*	2' F.B. OUTLET	CL. III	18 TONS
177+32.24 TO 177+50	2' F.B. INLET	TRM I	22 S.Y.
177+50 TO 178+00	2' F.B. SURF. DT.	TRM I	55 S.Y.
178+00 TO 180+00	SPL. 2' F.B. DT.	ECB	324 S.Y.
DAWKINS LANE			
8+00 TO 9+32.04	SPL. 2' F.B. DT.	TRM I	132 S.Y.

* - DEPTH TO PROTECT = 1.5'
** - DEPTH TO PROTECT = 2.0'

R/W MONUMENT - TYPE 1
L.T. STA. 165+00 TO STA. 180+00,
CONST. 9

P.I. STA. 169+47.36
Delta = 61°59'25.85" RT.
T = 579.72'
L = 1044.07'
R = 965.00'
E = 160.75'
e = 8.0%
RUNOFF = 204.26'
RUNOUT = 51.06'


CATHY DALENE McCANN

RIGHT OF WAY CALLS

- (A) N 63°29'36" W 153.67'
- (B) N 29°49'43" E 100.01'
- (C) S 7°16'02" W 304.30'
- (D) RADIUS = 614.18'
ARC LENGTH = 575.52'
CHORD LENGTH = 554.70'
BEARING = S 85°01'22" W
- (E) N 7°16'02" E 312.27'

ROBERT ALLEN HUNTER, TRUSTEE


DAWKINS LANE
P.I. STA. 8+98.59
Delta = 19°29'17.06" RT.
T = 36.75'
L = 72.79'
R = 214.00'
E = 3.13'

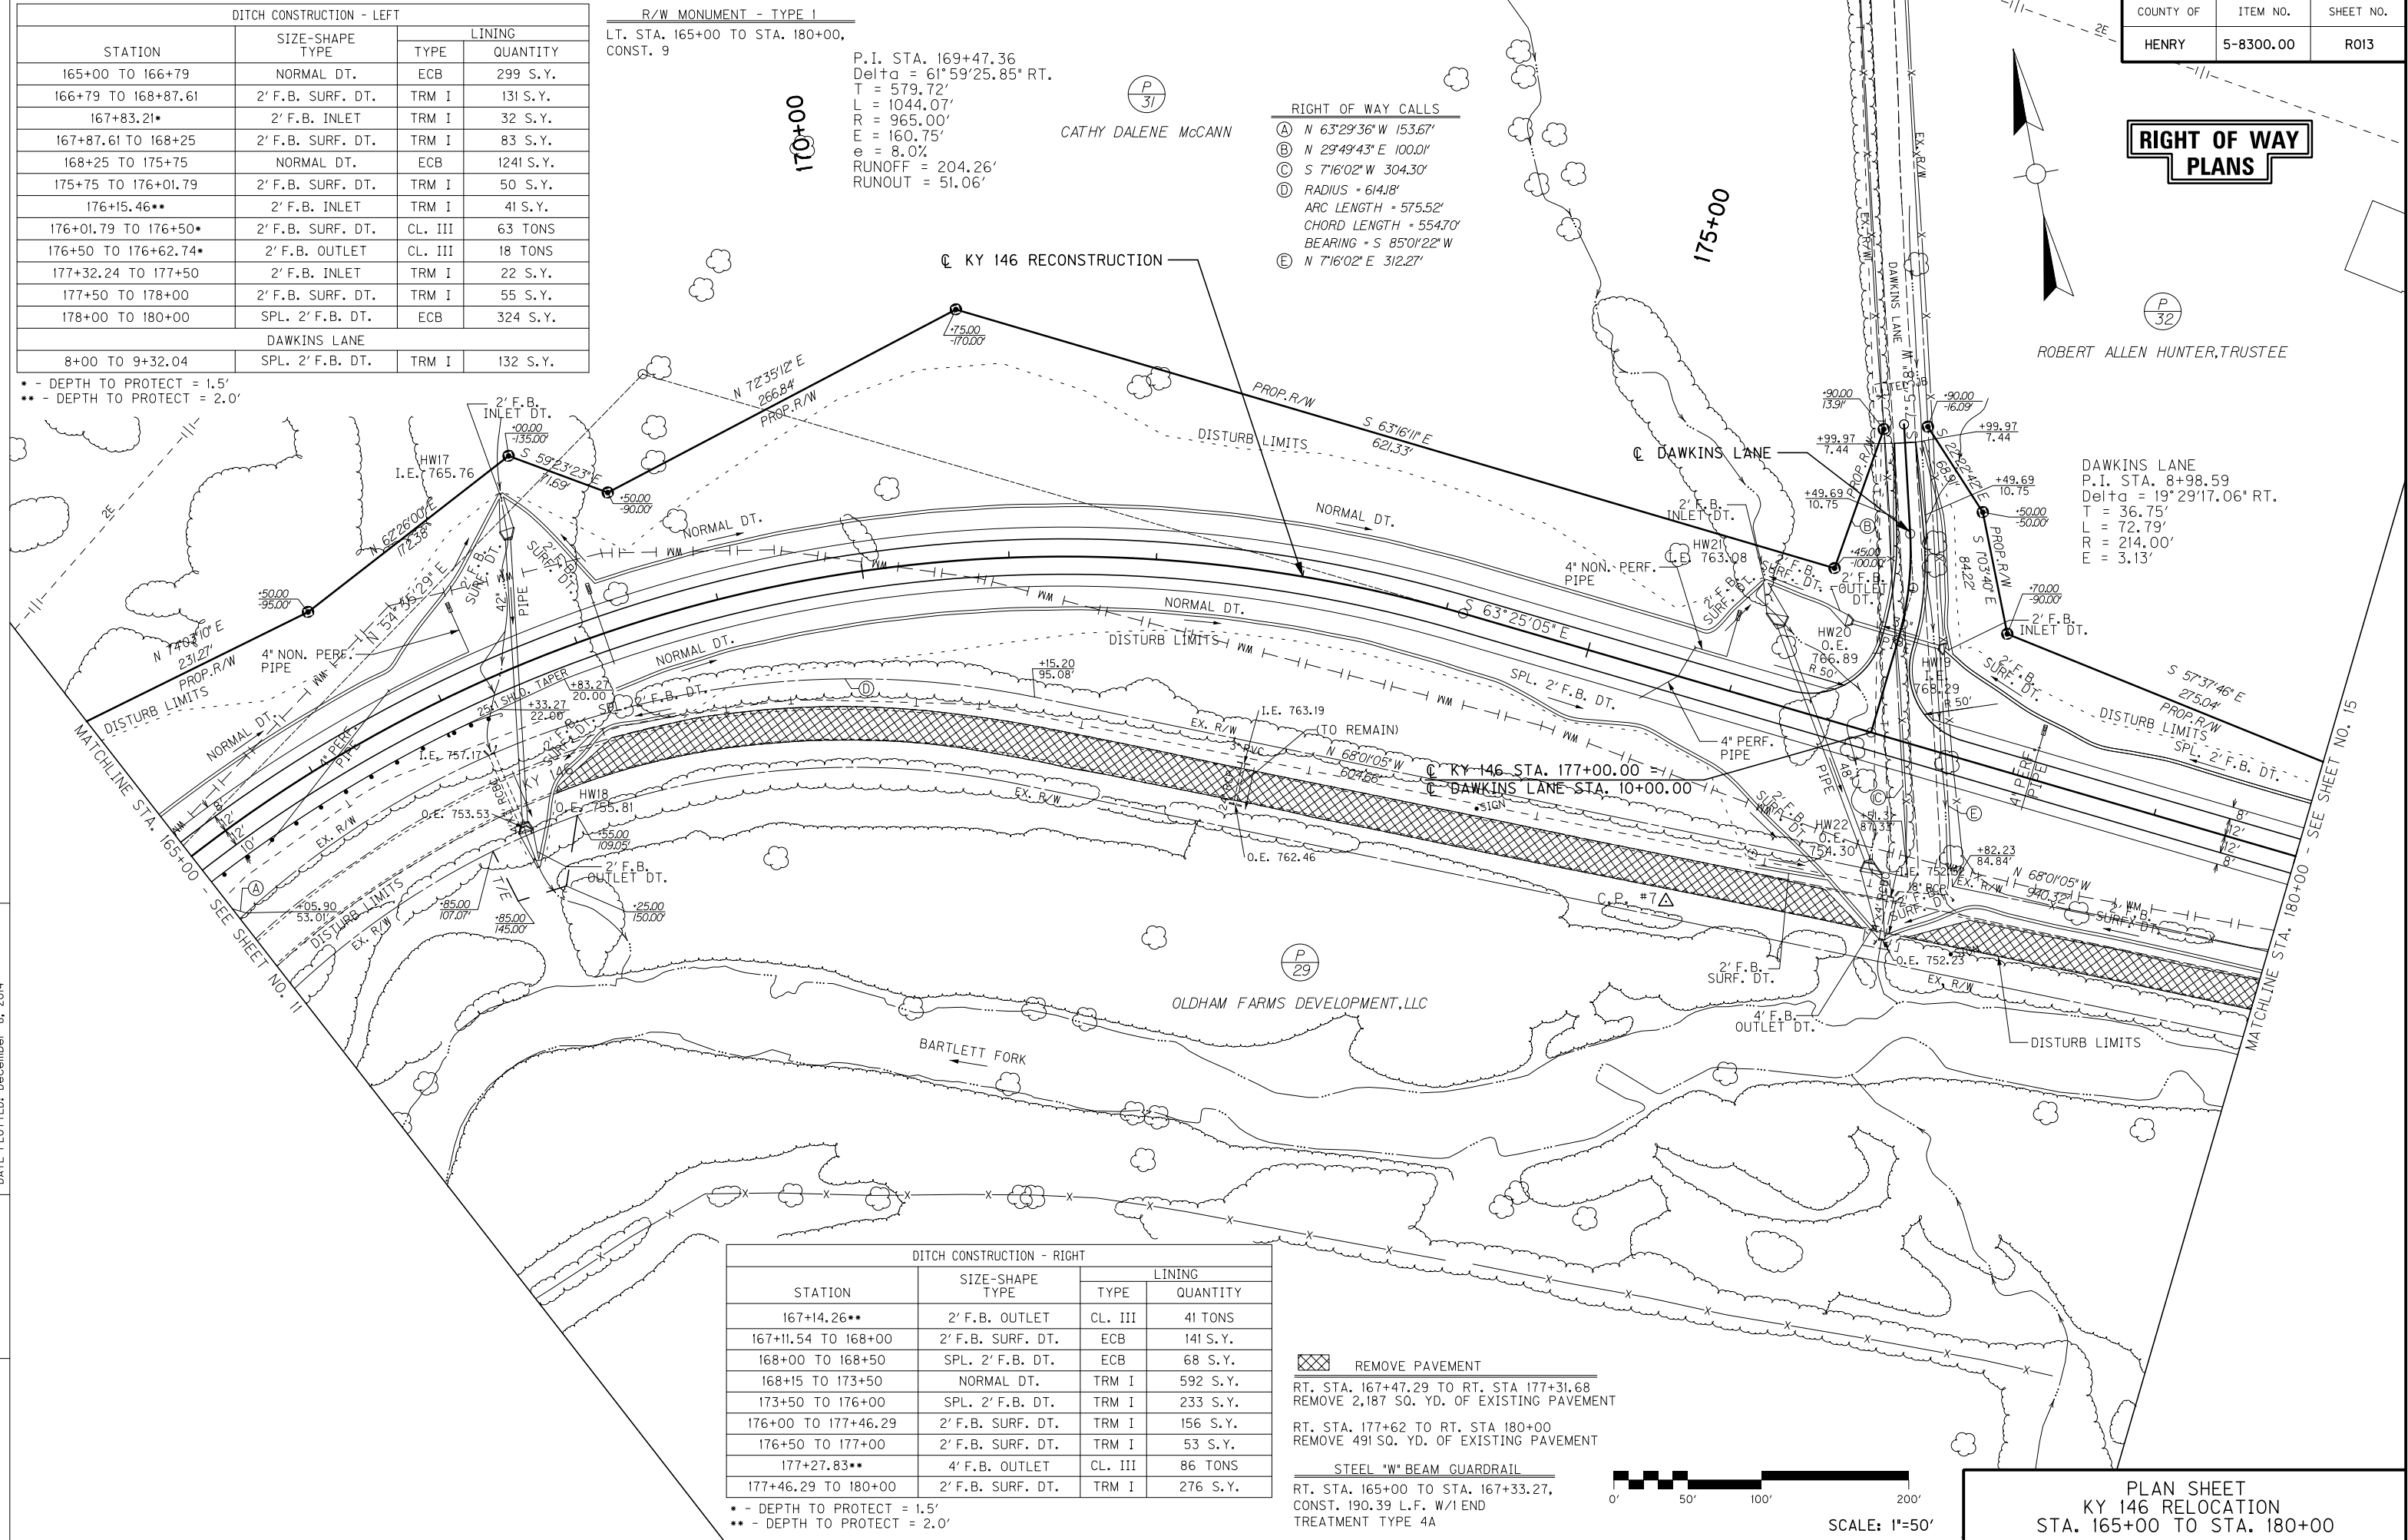

DITCH CONSTRUCTION - RIGHT			
STATION	SIZE-SHAPE TYPE	LINING	
		TYPE	QUANTITY
167+14.26**	2' F.B. OUTLET	CL. III	41 TONS
167+11.54 TO 168+00	2' F.B. SURF. DT.	ECB	141 S.Y.
168+00 TO 168+50	SPL. 2' F.B. DT.	ECB	68 S.Y.
168+15 TO 173+50	NORMAL DT.	TRM I	592 S.Y.
173+50 TO 176+00	SPL. 2' F.B. DT.	TRM I	233 S.Y.
176+00 TO 177+46.29	2' F.B. SURF. DT.	TRM I	156 S.Y.
176+50 TO 177+00	2' F.B. SURF. DT.	TRM I	53 S.Y.
177+27.83**	4' F.B. OUTLET	CL. III	86 TONS
177+46.29 TO 180+00	2' F.B. SURF. DT.	TRM I	276 S.Y.

* - DEPTH TO PROTECT = 1.5'
** - DEPTH TO PROTECT = 2.0'

REMOVE PAVEMENT
RT. STA. 167+47.29 TO RT. STA 177+31.68
REMOVE 2,187 SQ. YD. OF EXISTING PAVEMENT
RT. STA. 177+62 TO RT. STA 180+00
REMOVE 491 SQ. YD. OF EXISTING PAVEMENT
STEEL "W" BEAM GUARDRAIL
RT. STA. 165+00 TO STA. 167+33.27,
CONST. 190.39 L.F. W/1 END
TREATMENT TYPE 4A

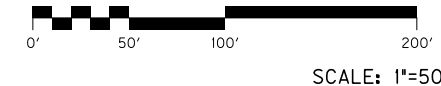


PLAN SHEET
KY 146 RELOCATION
STA. 165+00 TO STA. 180+00

RIGHT OF WAY PLANS

ENTRANCE CONSTRUCTION - LEFT									
STATION	ENTRANCE TYPE	ENTR. WIDTH (FT)	AREA (SQ YD)	CEM. CON. ENT. PVMT. 8" (SQ. YDS.)	ASPHALT SURFACE (TONS)	ASPHALT BASE (TONS)	CSB (TONS)	ENTR. PIPE (FT)	HWL
181+20	RESIDENTIAL	12	140	--	10	26	34	42' of 15" PIPE	--
190+00	RESIDENTIAL	12	135	--	9	24	33	41' of 15" PIPE	--
193+32	RESIDENTIAL	12	140	--	10	25	34	39' of 15" PIPE	--

DITCH CONSTRUCTION - LEFT			
STATION	SIZE-SHAPE TYPE	LINING	
		TYPE	QUANTITY
180+00 TO 180+97.33	SPL. 2' F.B. DT.	ECB	157 S.Y.
181+20 ENTR. LT.	SPL. 2' F.B. DT.	ECB	132 S.Y.
181+20 ENTR. RT.	SPL. 2' F.B. DT.	ECB	128 S.Y.
181+39.33 TO 181+50	2' F.B. INLET	TRM I	14 S.Y.
181+50 TO 183+45	NORMAL DT.	TRM I	224 S.Y.
183+45 TO 184+79.10	2' F.B. SURF. DT.	TRM I	142 S.Y.
184+66.75*	2' F.B. INLET	TRM I	41 S.Y.
184+79.10 TO 186+00	2' F.B. SURF. DT.	TRM I	129 S.Y.
186+00 TO 188+09.88	SPL. 2' F.B. DT.	ECB	336 S.Y.
188+09.88 TO 189+79.91	SPL. 2' F.B. DT.	ECB	273 S.Y.
190+00 ENTR. LT.	SPL. 2' F.B. DT.	ECB	110 S.Y.
190+00 ENTR. RT.	SPL. 2' F.B. DT.	ECB	110 S.Y.
190+20.91 TO 190+50	2' F.B. OUTLET	ECB	47 S.Y.
190+50 TO 192+33.94	2' F.B. SURF. DT.	TRM I	182 S.Y.
192+04.25**	4' F.B. INLET	TRM I	117 S.Y.
192+33.94 TO 192+76	2' F.B. SURF. DT.	TRM I	77 S.Y.
192+76 TO 193+00	NORMAL DT.	ECB	39 S.Y.
193+00 193+13.35	SPL. 2' F.B. DT.	ECB	23 S.Y.
193+32 ENTR. LT.	SPL. 2' F.B. DT.	ECB	137 S.Y.
193+32 ENTR. RT.	SPL. 2' F.B. DT.	ECB	101 S.Y.
193+52.34 TO 195+00	SPL. 2' F.B. DT.	ECB	238 S.Y.

* - DEPTH TO PROTECT = 2.0'
 ** - DEPTH TO PROTECT = 3.5'

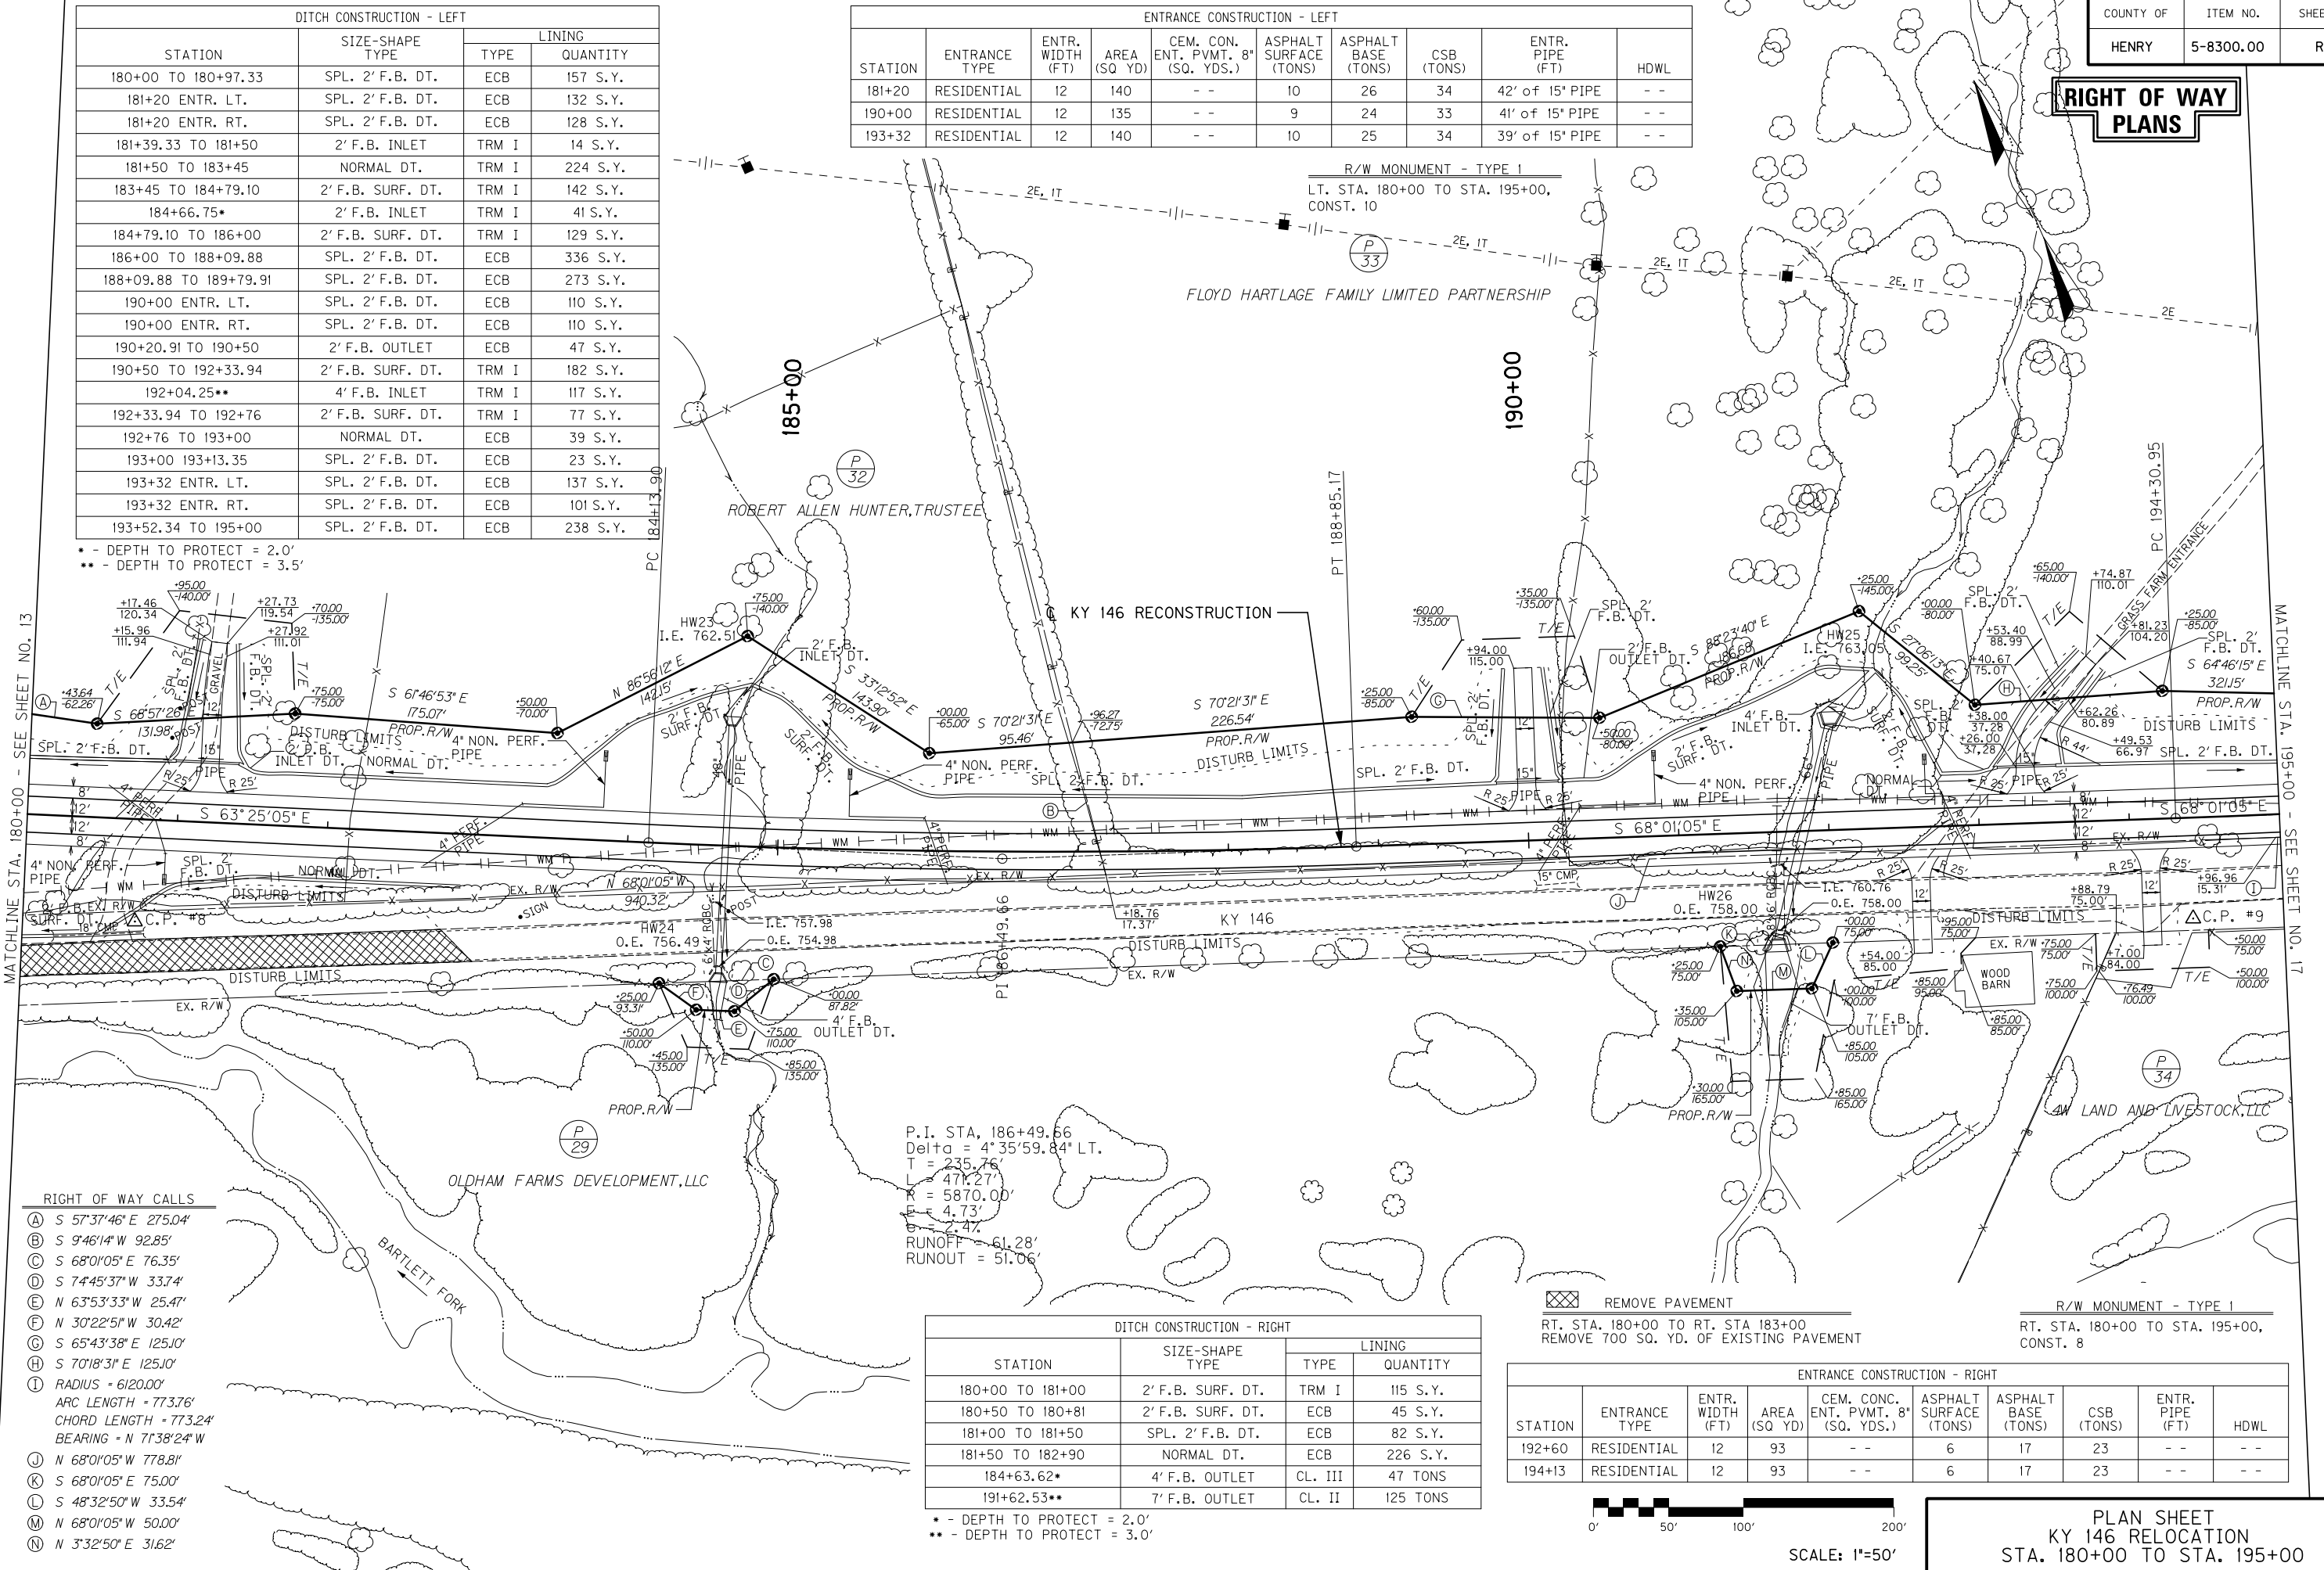

MATCHLINE STA. 180+00 - SEE SHEET NO. 13

MATCHLINE STA. 195+00 - SEE SHEET NO. 17

RIGHT OF WAY CALLS


- (A) S 57°37'46" E 275.04'
- (B) S 9°46'14" W 92.85'
- (C) S 68°01'05" E 76.35'
- (D) S 74°45'37" W 33.74'
- (E) N 63°53'33" W 25.47'
- (F) N 30°22'51" W 30.42'
- (G) S 65°43'38" E 125.10'
- (H) S 70°18'31" E 125.10'
- (I) RADIUS = 6120.00'
ARC LENGTH = 773.76'
CHORD LENGTH = 773.24'
BEARING = N 71°38'24" W
- (J) N 68°01'05" W 778.81'
- (K) S 68°01'05" E 75.00'
- (L) S 48°32'50" W 33.54'
- (M) N 68°01'05" W 50.00'
- (N) N 3°32'50" E 316.2'

P.I. STA. 186+49.66
 Delta = 4°35'59.84" LT.
 T = 235.76'
 L = 471.27'
 R = 5870.00'
 E = 4.73'
 B = 2.47'
 RUNOFF = 61.28'
 RUNOUT = 51.06'

DITCH CONSTRUCTION - RIGHT			
STATION	SIZE-SHAPE TYPE	LINING	
		TYPE	QUANTITY
180+00 TO 181+00	2' F.B. SURF. DT.	TRM I	115 S.Y.
180+50 TO 180+81	2' F.B. SURF. DT.	ECB	45 S.Y.
181+00 TO 181+50	SPL. 2' F.B. DT.	ECB	82 S.Y.
181+50 TO 182+90	NORMAL DT.	ECB	226 S.Y.
184+63.62*	4' F.B. OUTLET	CL. III	47 TONS
191+62.53**	7' F.B. OUTLET	CL. II	125 TONS

* - DEPTH TO PROTECT = 2.0'
 ** - DEPTH TO PROTECT = 3.0'

ENTRANCE CONSTRUCTION - RIGHT									
STATION	ENTRANCE TYPE	ENTR. WIDTH (FT)	AREA (SQ YD)	CEM. CONC. ENT. PVMT. 8" (SQ. YDS.)	ASPHALT SURFACE (TONS)	ASPHALT BASE (TONS)	CSB (TONS)	ENTR. PIPE (FT)	HWL
192+60	RESIDENTIAL	12	93	--	6	17	23	--	--
194+13	RESIDENTIAL	12	93	--	6	17	23	--	--

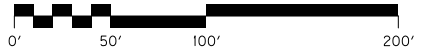

SCALE: 1"=50'

PLAN SHEET
 KY 146 RELOCATION
 STA. 180+00 TO STA. 195+00


DITCH CONSTRUCTION - LEFT			
STATION	SIZE-SHAPE TYPE	LINING	
		TYPE	QUANTITY
195+00 TO 197+50	NORMAL DT.	ECB	401 S.Y.
197+50 TO 198+00	2' F.B. SURF. DT.	TRM I	53 S.Y.
197+95.78	2' F.B. INLET	ECB	32 S.Y.
198+00 TO 198+21	2' F.B. SURF. DT.	ECB	43 S.Y.
198+21 TO 203+00	NORMAL DT.	ECB	768 S.Y.
201+00 INTERCEPTOR DT.	2' INTERCEPTOR DT.	TRM I	104 S.Y.
203+00 TO 203+50	SPL. 2' F.B. DT.	ECB	81 S.Y.
203+50 TO 204+59.90*	2' F.B. SURF. DT.	TRM I	146 S.Y.
204+56.50	4' F.B. INLET	TRM III	14 S.Y.
204+59.90 TO 204+71	2' F.B. SURF. DT.	TRM I	23 S.Y.
204+71 TO 208+00	NORMAL DT.	ECB	539 S.Y.
208+22.12 ENTR. LT.	SPL. 2' F.B. DT.	TRM I	118 S.Y.
208+22.12 ENTR. RT.	SPL. 2' F.B. DT.	ECB	168 S.Y.
208+35 TO 209+12.57	2' F.B. SURF. DT.	ECB	121 S.Y.
209+18.90**	4' F.B. INLET	TRM I	53 S.Y.
209+12.57 TO 209+67.29	2' F.B. SURF. DT.	TRM I	64 S.Y.

ENTRANCE CONSTRUCTION - LEFT									
STATION	ENTRANCE TYPE	ENTR. WIDTH (FT)	AREA (SQ YD)	CEM. CONC. ENT. PVMT. 8" (SQ. YDS.)	ASPHALT SURFACE (TONS)	ASPHALT BASE (TONS)	CSB (TONS)	ENTR. PIPE (FT)	HDWL
208+22	RESIDENTIAL	12	179	--	12	33	44	--	--
209+91	RESIDENTIAL	14	147	--	10	27	36	43' of 15" PIPE	--

R/W MONUMENT - TYPE 1
 LT. STA. 195+00 TO STA. 210+00,
 CONST. 6

P.I. STA. 208+86.51
 Delta = 25°50'16.02" RT.
 T = 339.48'
 L = 667.41'
 R = 1480.00'
 E = 38.44'
 e = 7.0%
 RUNOFF = 178.72'
 RUNOUT = 51.06'


* - DEPTH TO PROTECT = 1.5'
 ** - DEPTH TO PROTECT = 2.0'

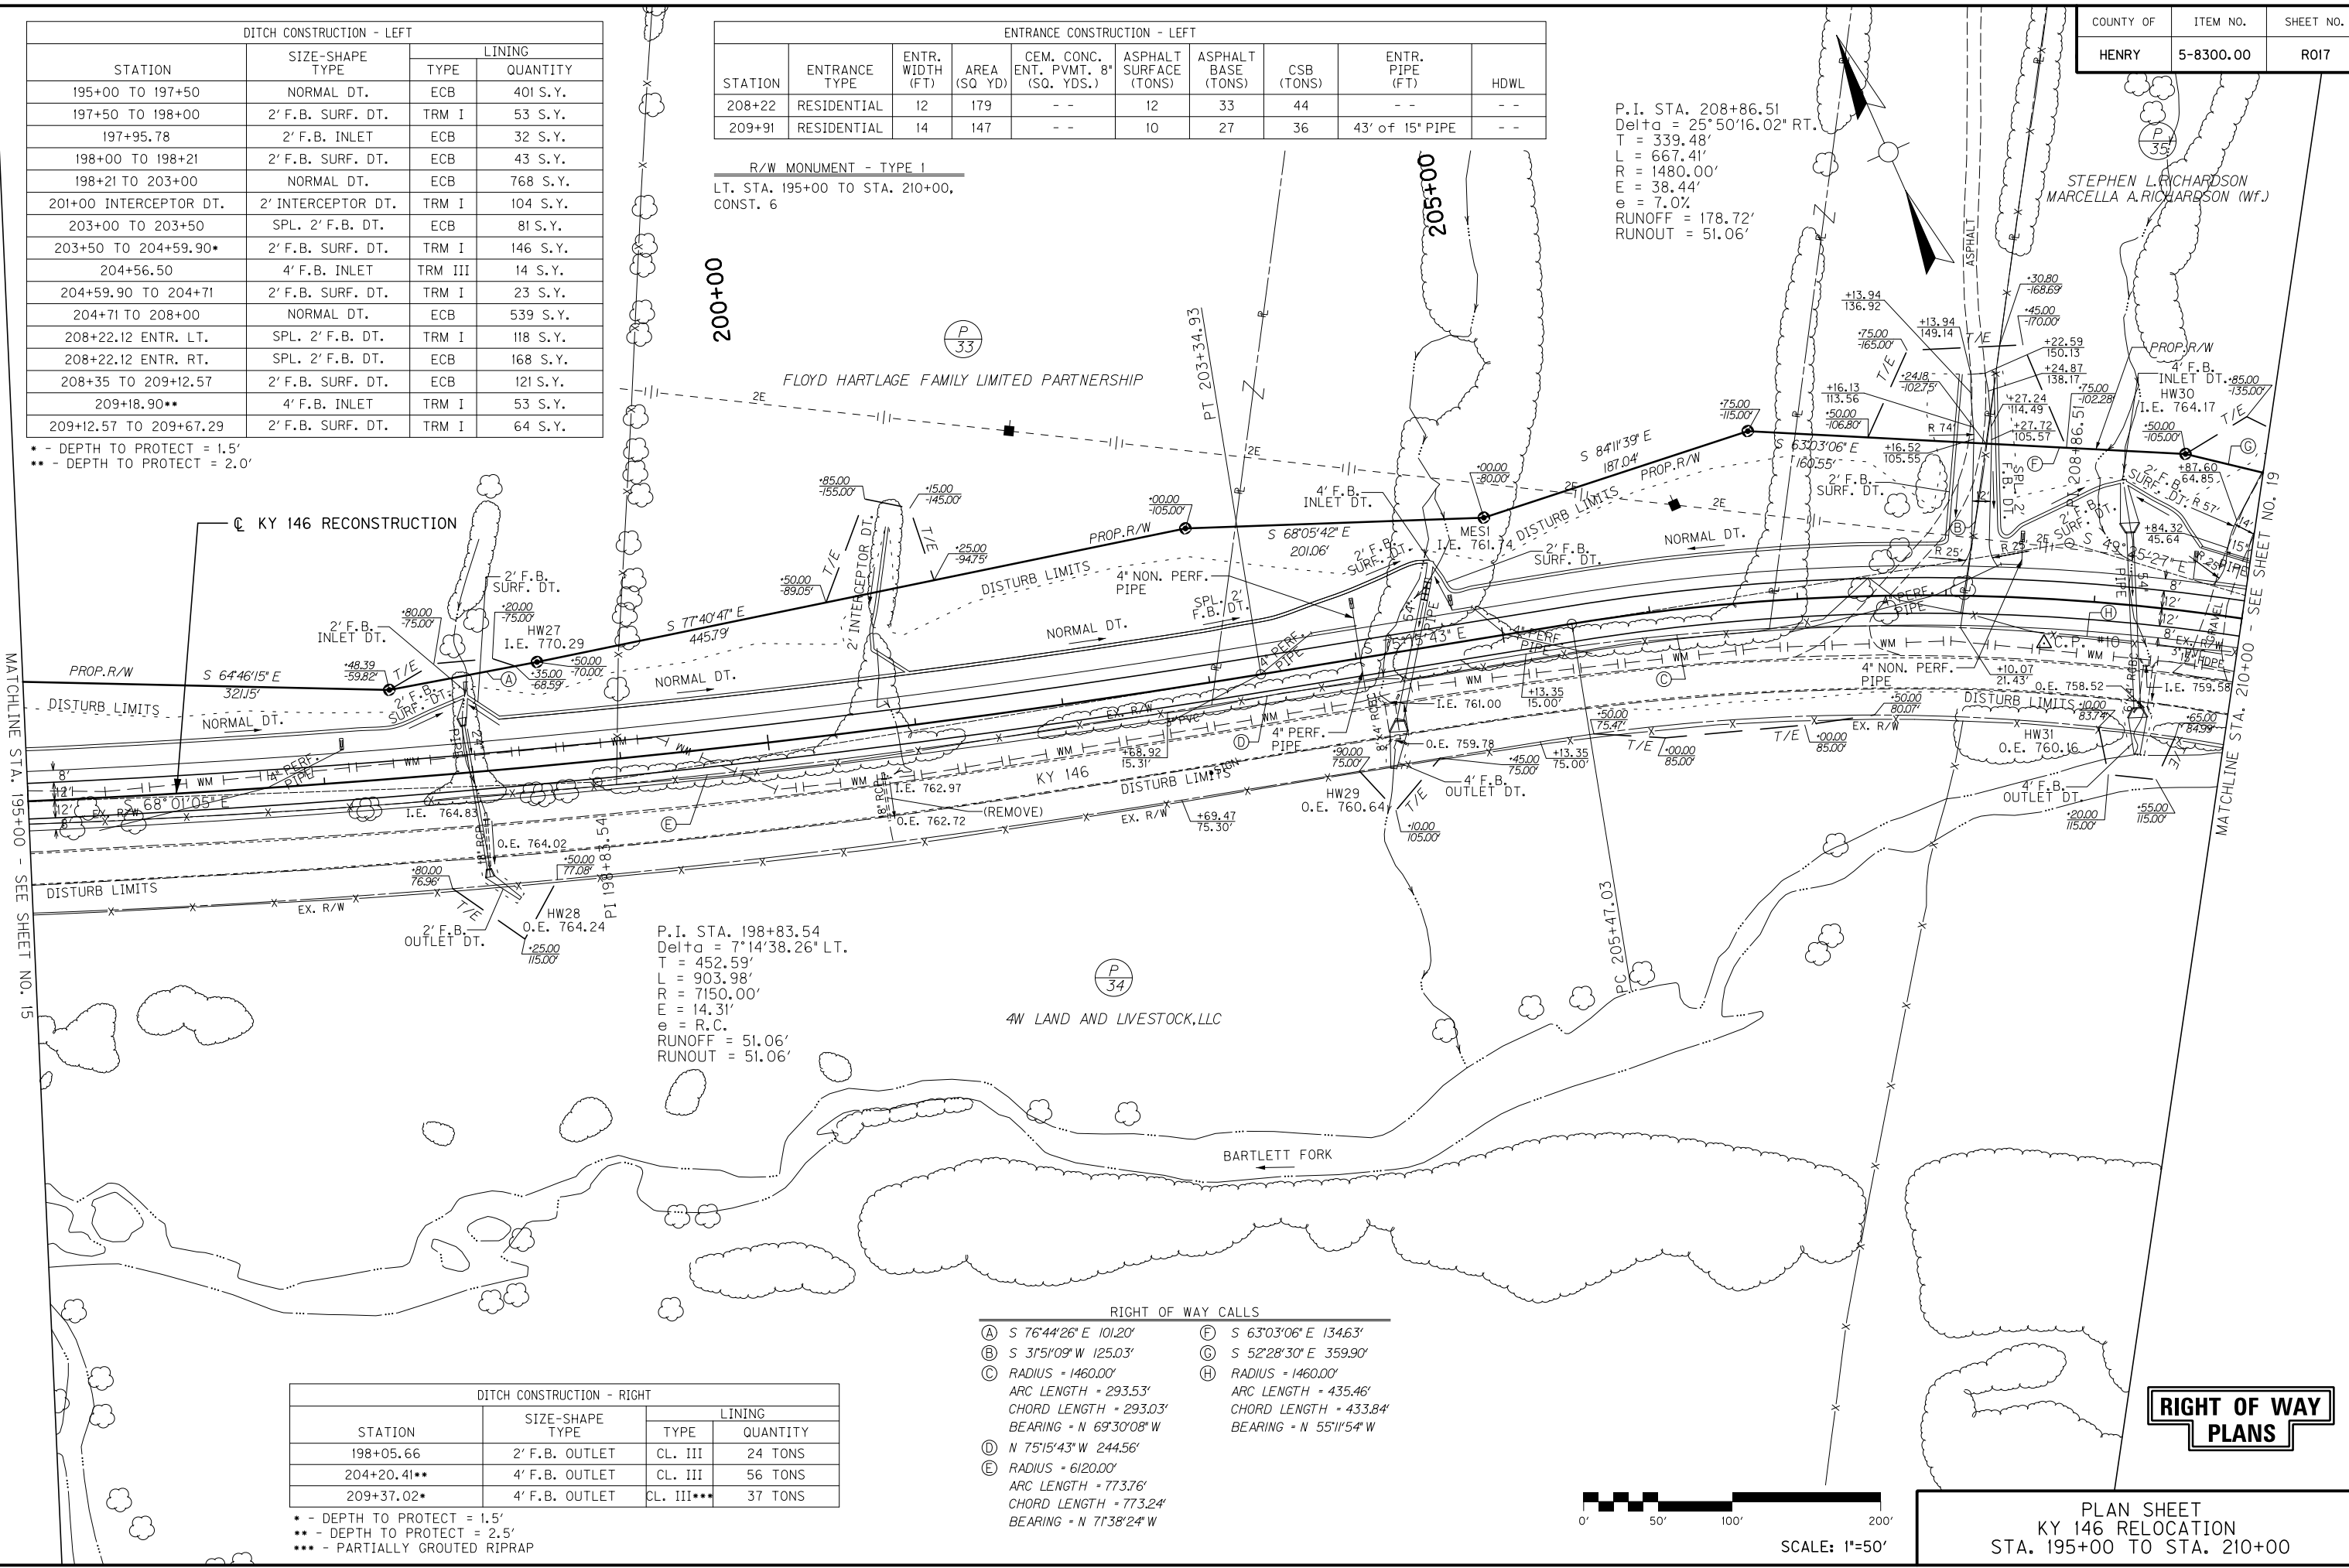

DITCH CONSTRUCTION - RIGHT			
STATION	SIZE-SHAPE TYPE	LINING	
		TYPE	QUANTITY
198+05.66	2' F.B. OUTLET	CL. III	24 TONS
204+20.41**	4' F.B. OUTLET	CL. III	56 TONS
209+37.02*	4' F.B. OUTLET	CL. III**	37 TONS

* - DEPTH TO PROTECT = 1.5'
 ** - DEPTH TO PROTECT = 2.5'
 *** - PARTIALLY GROUTED RIPRAP

- RIGHT OF WAY CALLS
- (A) S 76°44'26" E 101.20'
 - (B) S 31°51'09" W 125.03'
 - (C) RADIUS = 1460.00'
ARC LENGTH = 293.53'
CHORD LENGTH = 293.03'
BEARING = N 69°30'08" W
 - (D) N 75°15'43" W 244.56'
 - (E) RADIUS = 6120.00'
ARC LENGTH = 773.76'
CHORD LENGTH = 773.24'
BEARING = N 71°38'24" W
 - (F) S 63°03'06" E 134.63'
 - (G) S 52°28'30" E 359.90'
 - (H) RADIUS = 1460.00'
ARC LENGTH = 435.46'
CHORD LENGTH = 433.84'
BEARING = N 55°11'54" W

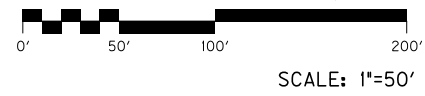

RIGHT OF WAY PLANS

PLAN SHEET
 KY 146 RELOCATION
 STA. 195+00 TO STA. 210+00

FILE NAME: I:\3886-KY 146 HENRY PHASE 2\SEGMENT 1\SENT\2014-12-12 ROW SET\PLAN\RO1700PL.DGN


USER: TRobinson
DATE PLOTTED: December 8, 2014

E-SHEET NAME:

MicroStation v8.11.7.443

MicroStation v8.11.7.443 E-SHEET NAME: DATE PLOTTED: December 8, 2014 USER: TRobinson FILE NAME: I:\3886-KY 146 HENRY\PHASE 2\SEGMENT 1\SHEETS\PROFILES\RO1800PR.DGN

**RIGHT OF WAY
PLANS**

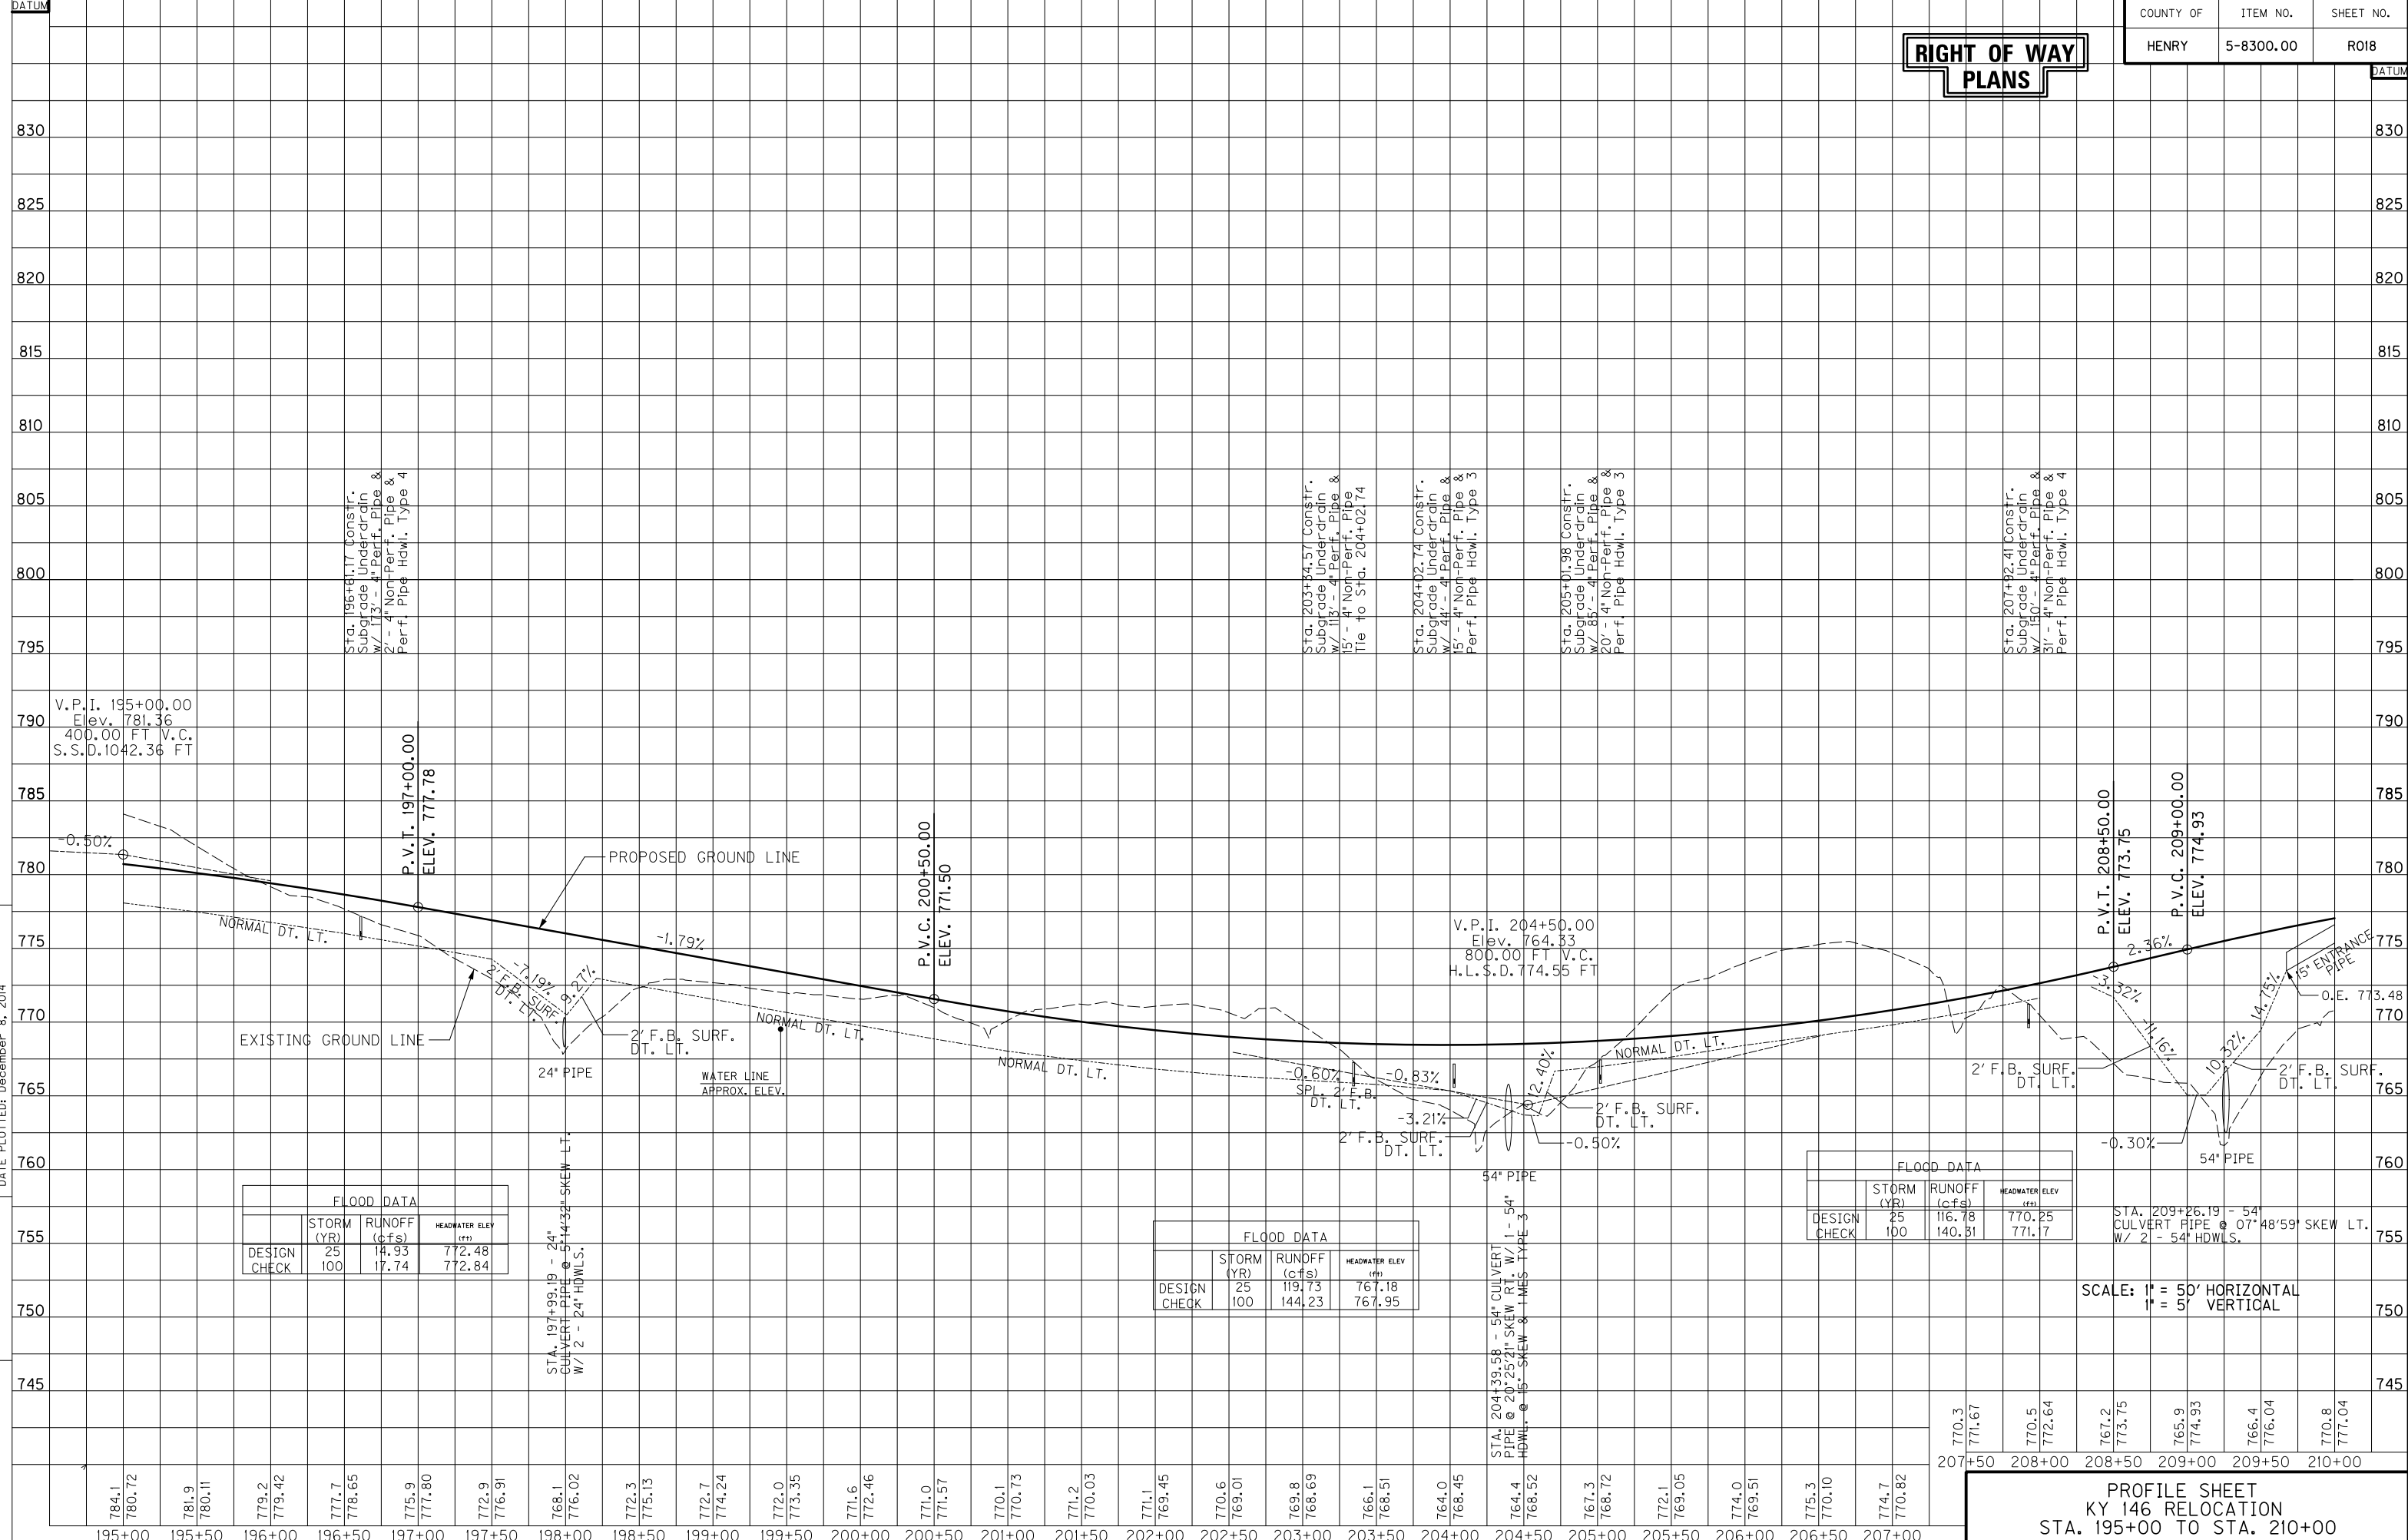

FLOOD DATA			
	STORM (YR)	RUNOFF (cfs)	HEADWATER ELEV (ft)
DESIGN	25	14.93	772.48
CHECK	100	17.74	772.84

FLOOD DATA			
	STORM (YR)	RUNOFF (cfs)	HEADWATER ELEV (ft)
DESIGN	25	119.73	767.18
CHECK	100	144.23	767.95

FLOOD DATA			
	STORM (YR)	RUNOFF (cfs)	HEADWATER ELEV (ft)
DESIGN	25	116.78	770.25
CHECK	100	140.81	771.7

STA. 209+26.19 - 54" CULVERT PIPE @ 07° 48' 59" SKEW LT. W/ 2 - 54" HDWLS.

SCALE: 1" = 50' HORIZONTAL
1" = 5' VERTICAL

770.3	771.67	770.5	772.64	767.2	773.75	765.9	774.93	766.4	776.04	770.8	777.04
207+50	208+00	208+50	209+00	209+50	210+00						

**PROFILE SHEET
KY 146 RELOCATION
STA. 195+00 TO STA. 210+00**


ENTRANCE CONSTRUCTION - LEFT									
STATION	ENTRANCE TYPE	ENTR. WIDTH (FT)	AREA (SQ YD)	CEM. CONC. ENT. PVMT. 8" (SQ. YDS.)	ASPHALT SURFACE (TONS)	ASPHALT BASE (TONS)	CSB (TONS)	ENTR. PIPE (FT)	HWL
217+00	RESIDENTIAL	12	141	--	10	26	34	51' of 15" PIPE	--
218+88	RESIDENTIAL	12	405	--	28	74	99	65' of 24" PIPE	--
225+00	RESIDENTIAL	12	51	--	3	9	12	--	--

DITCH CONSTRUCTION - LEFT			
STATION	SIZE-SHAPE TYPE	LINING	
		TYPE	QUANTITY
209+91.11 ENTR. RT.	SPL. 2' F.B. DT.	ECB	97 S.Y.
210+08.60 TO 211+00	NORMAL DT.	ECB	151 S.Y.
211+00 TO 212+50	SPL. 2' F.B. DT.	ECB	246 S.Y.
212+50 TO 212+54.99	NORMAL DT.	ECB	9 S.Y.
212+54.99 TO 216+30	SPL. 2' F.B. DT.	ECB	604 S.Y.
216+30 TO 216+74.30	2' F.B. SURF. DT.	TRM I	54 S.Y.
217+25.30 TO 217+94.14	2' F.B. SURF. DT.	TRM I	65 S.Y.
217+91.05	10' F.B. INLET	CL. II	26 TONS
217+94.14 TO 218+49.44	2' F.B. SURF. DT.	TRM I	52 S.Y.
204+59.90 TO 204+71	2' F.B. SURF. DT.	TRM I	23 S.Y.
218+88.40 ENTR. LT.	SPL. 2' F.B. DT.	TRM I	290 S.Y.
218+88.40 ENTR. RT.	SPL. 2' F.B. DT.	TRM I	271 S.Y.
219+11.75 TO 223+50	SPL. 2' F.B. DT.	ECB	699 S.Y.
223+50 TO 224+81	NORMAL DT.	ECB	209 S.Y.

R/W MONUMENT - TYPE 1
 LT. STA. 210+00 TO STA. 225+00,
 CONST. 7

215+00

FILE NAME: I: 3886-KY 146 HENRY PHASE 2 SEGMENT 11 SENT 2014-12-12 ROW SET PLAN R01900PL.DGN
 USER: T Robinson
 DATE PLOTTED: December 8, 2014
 E-SHEET NAME:
 MicroStation v8.11.7.443

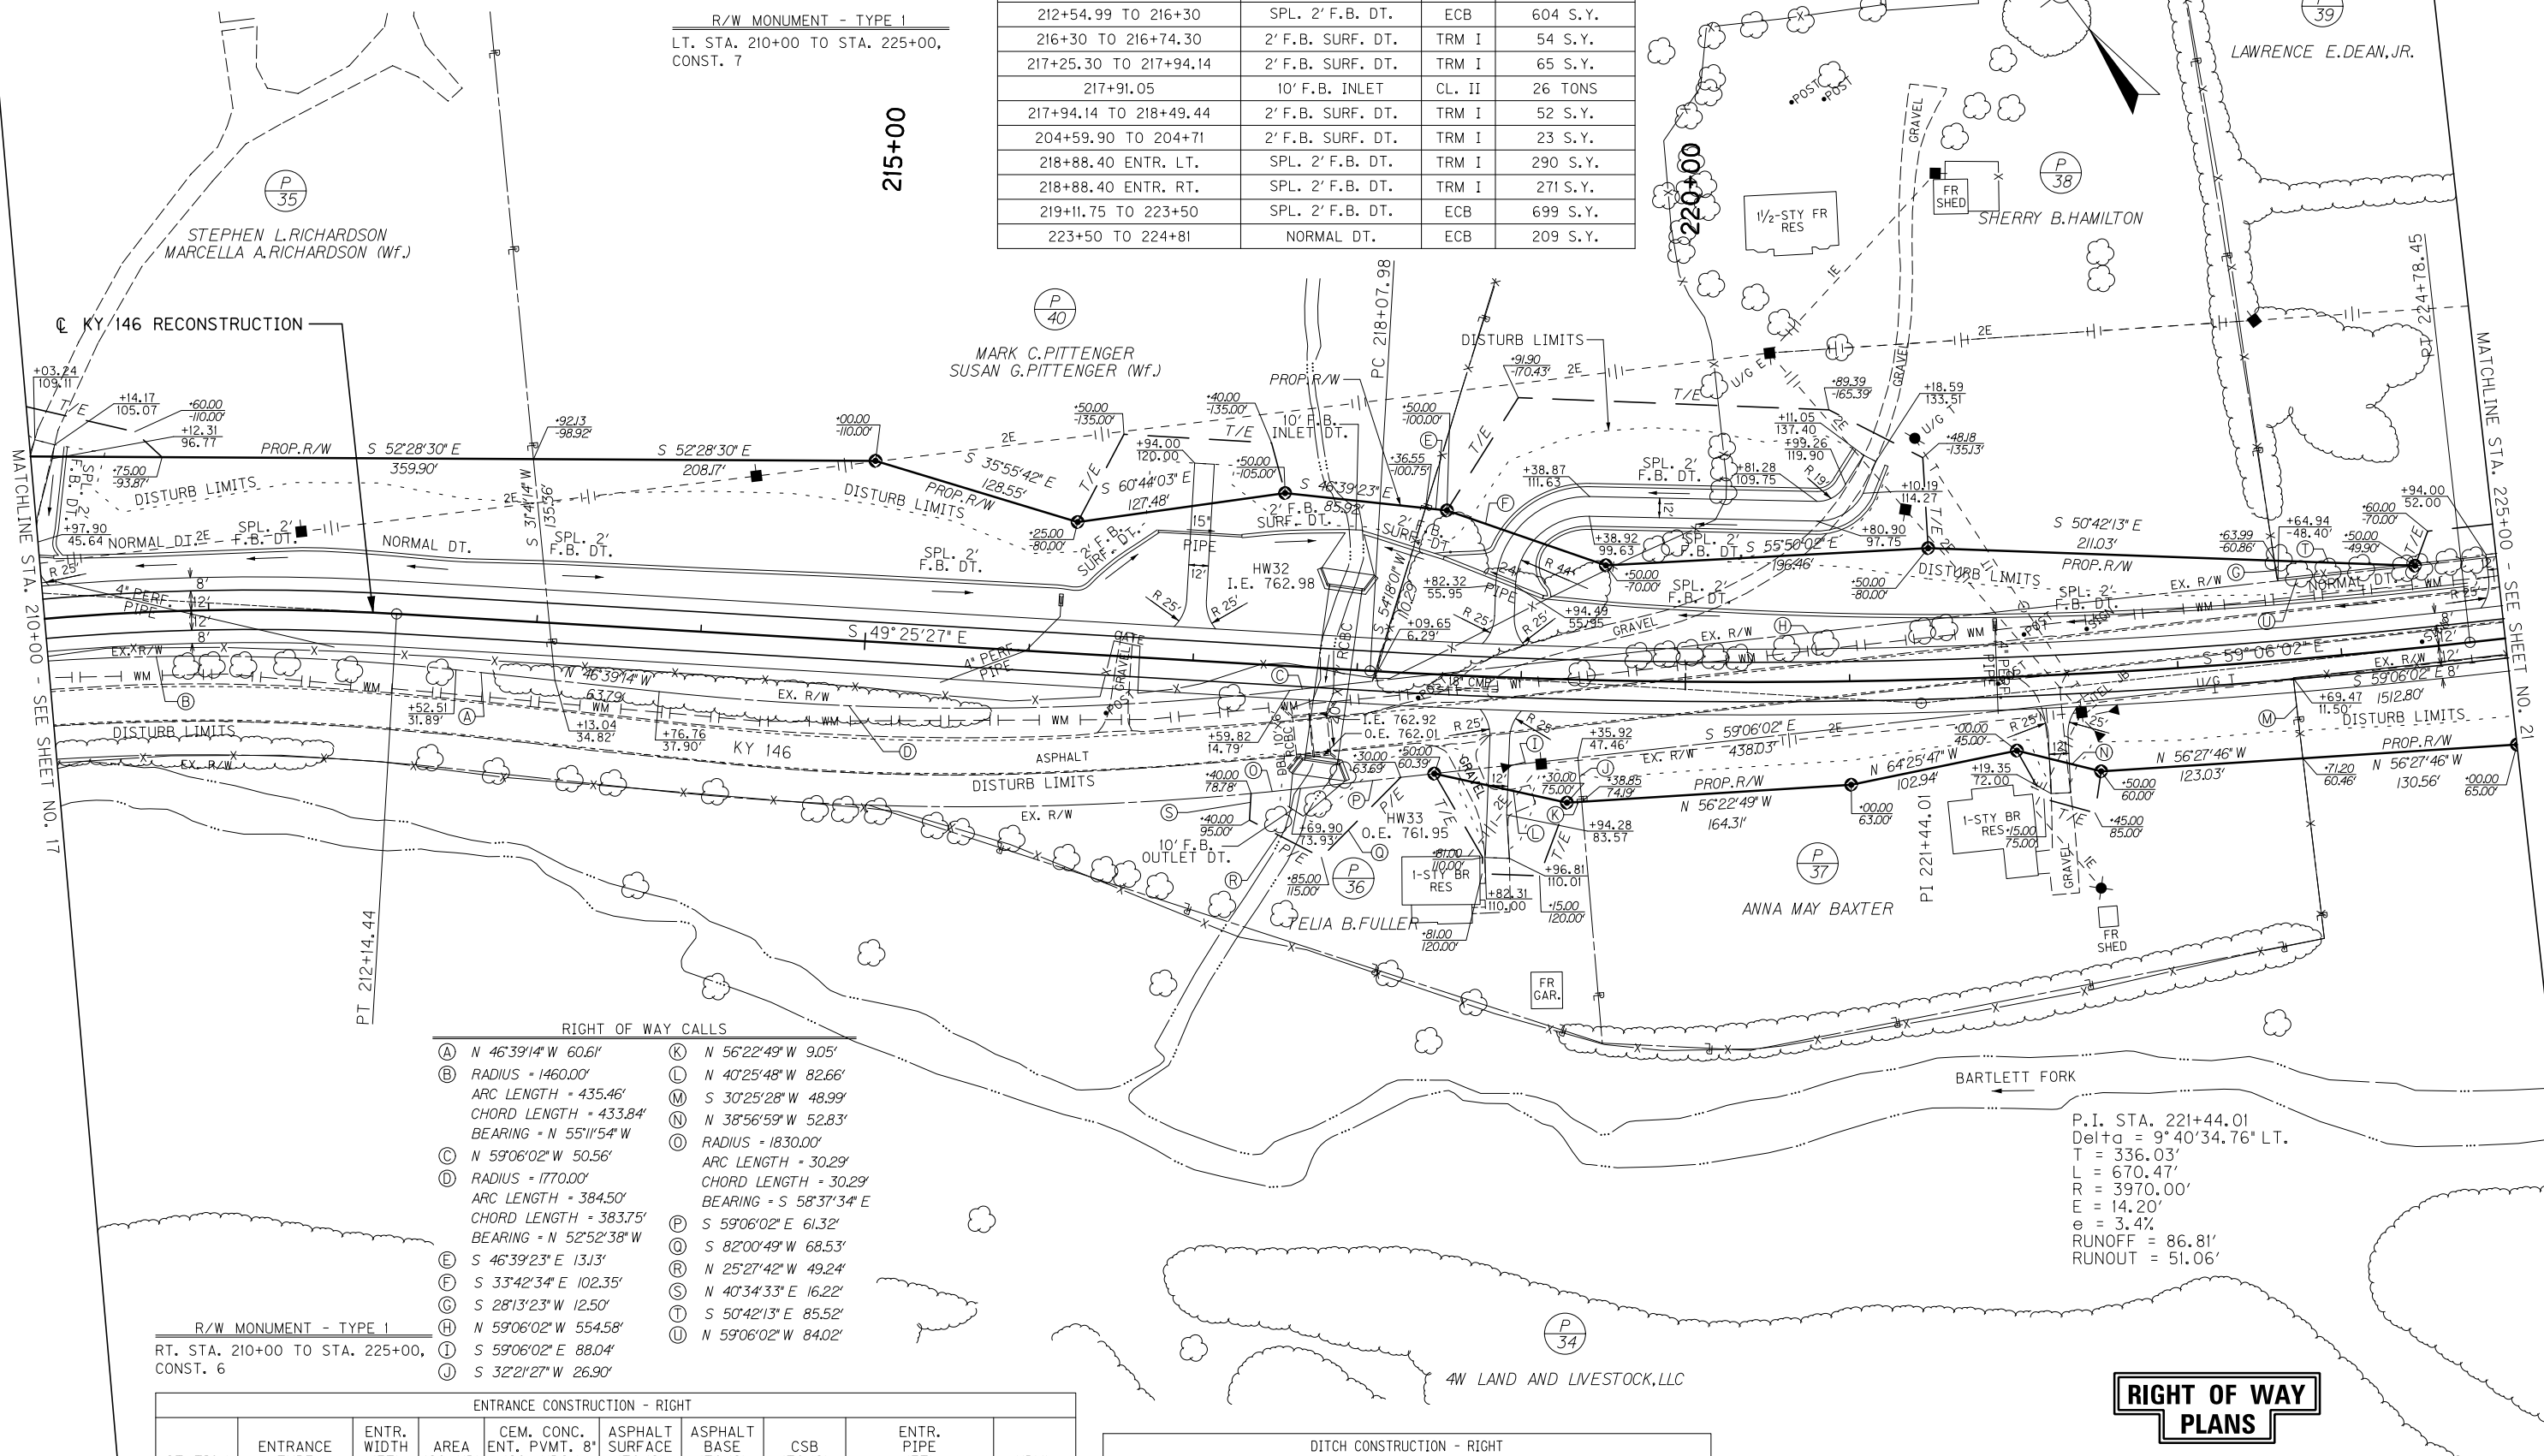

RIGHT OF WAY CALLS

(A) N 46°39'14" W 60.61'	(K) N 56°22'49" W 9.05'
(B) RADIUS = 1460.00'	(L) N 40°25'48" W 82.66'
ARC LENGTH = 435.46'	(M) S 30°25'28" W 48.99'
CHORD LENGTH = 433.84'	(N) N 38°56'59" W 52.83'
BEARING = N 55°11'54" W	(O) RADIUS = 1830.00'
(C) N 59°06'02" W 50.56'	ARC LENGTH = 30.29'
(D) RADIUS = 1770.00'	CHORD LENGTH = 30.29'
ARC LENGTH = 384.50'	BEARING = S 58°37'34" E
CHORD LENGTH = 383.75'	(P) S 59°06'02" E 61.32'
BEARING = N 52°52'38" W	(Q) S 82°00'49" W 68.53'
(E) S 46°39'23" E 13.13'	(R) N 25°27'42" W 49.24'
(F) S 33°42'34" E 102.35'	(S) N 40°34'33" E 16.22'
(G) S 28°13'23" W 12.50'	(T) S 50°42'13" E 85.52'
(H) N 59°06'02" W 554.58'	(U) N 59°06'02" W 84.02'
(I) S 59°06'02" E 88.04'	
(J) S 32°21'27" W 26.90'	


R/W MONUMENT - TYPE 1
 RT. STA. 210+00 TO STA. 225+00,
 CONST. 6

ENTRANCE CONSTRUCTION - RIGHT									
STATION	ENTRANCE TYPE	ENTR. WIDTH (FT)	AREA (SQ YD)	CEM. CONC. ENT. PVMT. 8" (SQ. YDS.)	ASPHALT SURFACE (TONS)	ASPHALT BASE (TONS)	CSB (TONS)	ENTR. PIPE (FT)	HWL
218+88	RESIDENTIAL	12	132	--	9	24	32	--	--
222+25	RESIDENTIAL	12	77	--	5	14	19	--	--

DITCH CONSTRUCTION - RIGHT			
STATION	SIZE-SHAPE TYPE	LINING	
		TYPE	QUANTITY
217+80.62	10' F.B. OUTLET	CL. III	41 TONS


P.I. STA. 221+44.01
 Delta = 9° 40' 34.76" LT.
 T = 336.03'
 L = 670.47'
 R = 3970.00'
 E = 14.20'
 e = 3.4%
 RUNOFF = 86.81'
 RUNOUT = 51.06'

RIGHT OF WAY PLANS

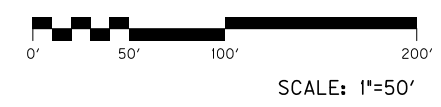

PLAN SHEET
 KY 146 RELOCATION
 STA. 210+00 TO STA. 225+00

**RIGHT OF WAY
PLANS**

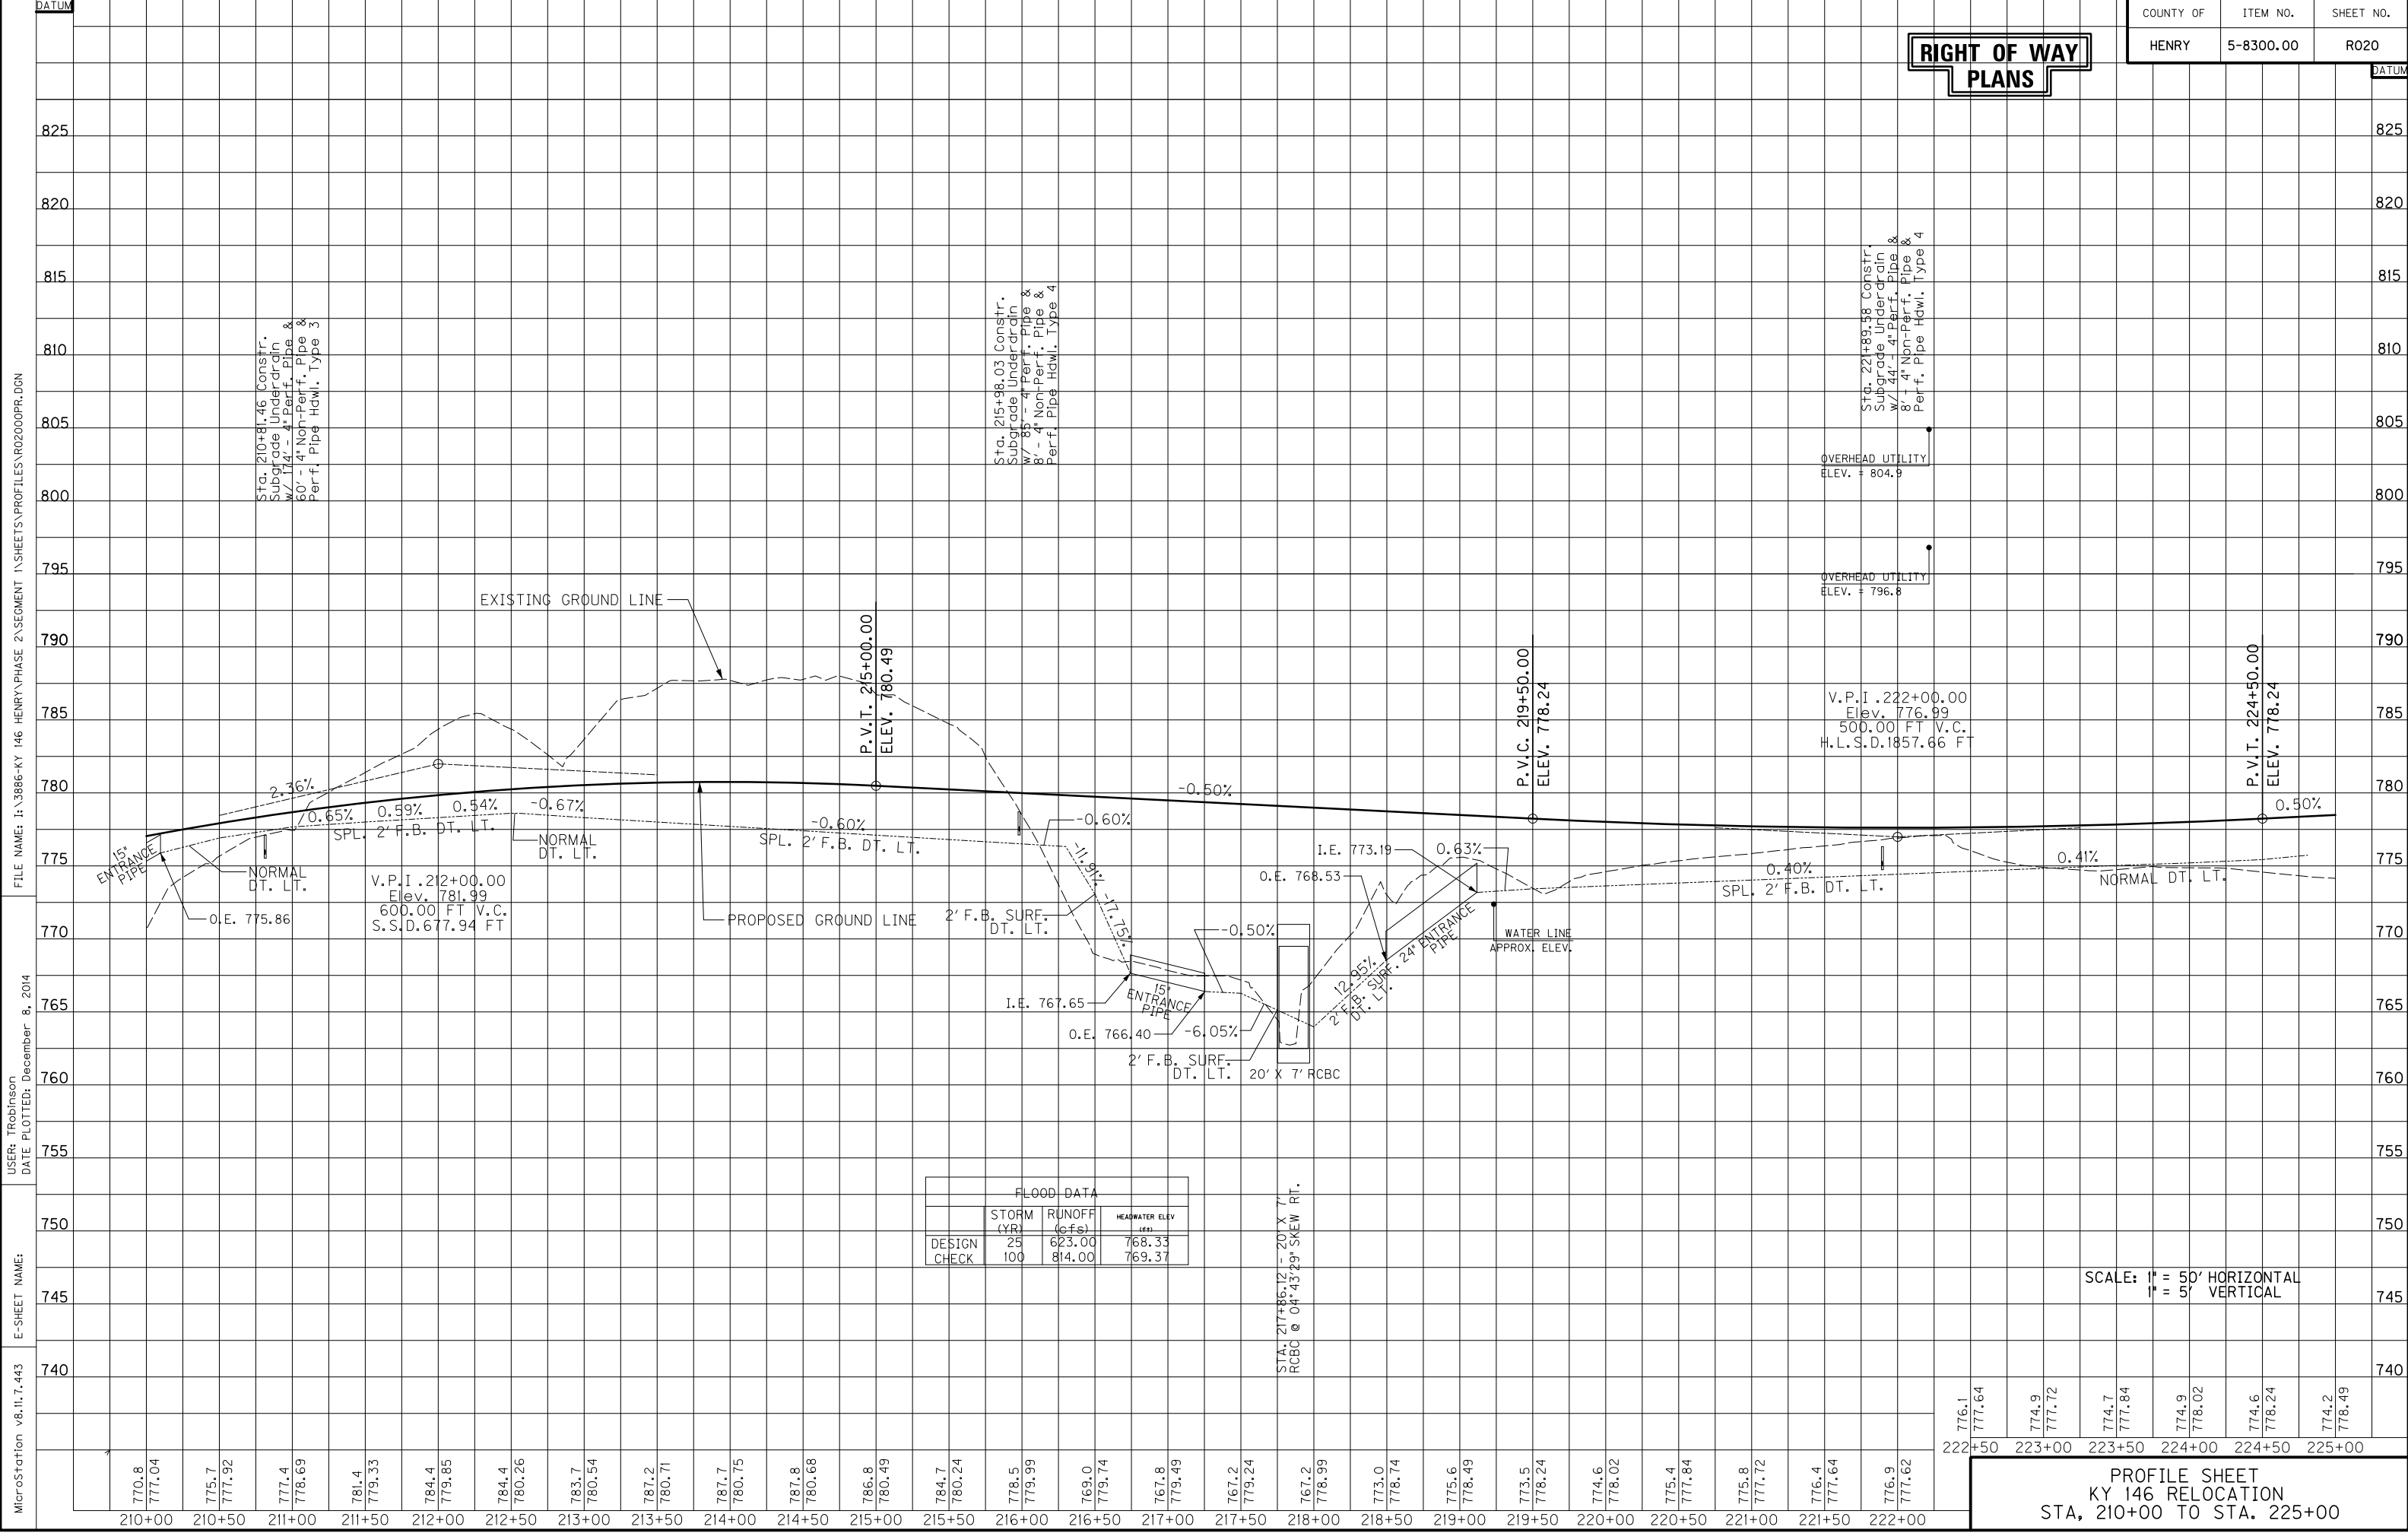

MicroStation v8.11.7.443 E-SHEET NAME: DATE PLOTTED: December 8, 2014 USER: TRobinson FILE NAME: I:\3886-KY 146 HENRY PHASE 2\SEGMENT 1\SHEETS\PROFILES\R02000PR.DGN

FLOOD DATA		
STORM (YR)	RUNOFF (cfs)	HEADWATER ELEV (ft)
DESIGN	25	623.00
CHECK	100	814.00
		768.33
		769.37

SCALE: 1" = 50' HORIZONTAL
1" = 5' VERTICAL

PROFILE SHEET
KY 146 RELOCATION
STA, 210+00 TO STA. 225+00

770.8	777.04	775.7	777.92	777.4	778.69	781.4	779.33	784.4	779.85	784.4	780.26	783.7	780.54	787.2	780.71	787.7	780.75	787.8	780.68	786.8	780.49	784.7	780.24	778.5	779.99	769.0	779.74	767.8	779.49	767.2	779.24	767.2	778.99	773.0	778.74	775.6	778.49	773.5	778.24	774.6	778.02	775.4	777.84	775.8	777.72	776.4	777.64	776.9	777.62	776.1	777.64	774.9	777.72	774.7	777.84	774.9	778.02	774.6	778.24	774.2	778.49
210+00	210+50	211+00	211+50	212+00	212+50	213+00	213+50	214+00	214+50	215+00	215+50	216+00	216+50	217+00	217+50	218+00	218+50	219+00	219+50	220+00	220+50	221+00	221+50	222+00	222+50	223+00	223+50	224+00	224+50	225+00																															

FILE NAME: I:\3886-KY 146 HENRY PHASE 2\SEGMENT 1\SENT\2014-12-12 ROW SET\PLAN\RO200PL.DGN
 USER: TRobinson
 DATE PLOTTED: December 8, 2014
 E-SHEET NAME:
 MicroStation v8.11.7.443

COUNTY OF	ITEM NO.	SHEET NO.
HENRY	5-8300.00	RO21

DITCH CONSTRUCTION - LEFT			
STATION	SIZE-SHAPE TYPE	LINING	
		TYPE	QUANTITY
225+23.99 TO 227+50	SPL. 2' F.B. DT.	TRM I	260 S.Y.
227+50 TO 227+95*	NORMAL DT.	ECB	94 S.Y.
228+27 TO 229+95.40	SPL. 2' F.B. DT.	TRM I	157 S.Y.
230+41.35 TO 230+46.06	SPL. 2' F.B. DT.	TRM I	9 S.Y.
230+46.06	2' F.B. INLET	TRM I	18 S.Y.
230+46.06 TO 231+25	2' F.B. SURF. DT.	TRM I	82 S.Y.
231+62 TO 234+00	SPL. 2' F.B. DT.	ECB	361 S.Y.
234+00 TO 234+46	NORMAL DT.	ECB	75 S.Y.
234+46 TO 235+00	SPL. 2' F.B. DT.	ECB	89 S.Y.
234+98.97	2' F.B. INLET	TRM I	5 S.Y.
235+00 TO 235+50	SPL. 2' F.B. DT.	TRM I	59 S.Y.
235+50 TO 238+50	NORMAL DT.	ECB	484 S.Y.
238+74.51 ENTR. LT.	SPL. 2' F.B. DT.	ECB	78 S.Y.
238+74.51 ENTR. RT.	SPL. 2' F.B. DT.	ECB	90 S.Y.
239+00 TO 239+68.42	SPL. 2' F.B. DT.	TRM I	88 S.Y.
239+68.42*	2' F.B. INLET	TRM I	31 S.Y.
239+68.42 TO 240+00	SPL. 2' F.B. DT.	TRM I	34 S.Y.


ENTRANCE CONSTRUCTION - LEFT									
STATION	ENTRANCE TYPE	ENTR. WIDTH (FT)	AREA (SQ YD)	CEM. CONC. ENT. PVMT. 8" (SQ. YDS.)	ASPHALT SURFACE (TONS)	ASPHALT BASE (TONS)	CSB (TONS)	ENTR. PIPE (FT)	HDWL
228+10	RESIDENTIAL	12	60	--	4	11	15	--	--
230+19	RESIDENTIAL	12	64	--	4	12	16	46' of 15" PIPE	--
231+44	RESIDENTIAL	12	51	--	4	9	12	37' of 15" PIPE	--
238+75	RESIDENTIAL	12	98	--	7	18	24	--	--

REMOVE GUARDRAIL
 LT. STA. 238+96.67 TO STA. 240+00,
 REMOVE 114 L.F.
 R/W MONUMENT - TYPE 1
 LT. STA. 225+00 TO STA. 240+00,
 CONST. 2

RIGHT OF WAY PLANS

P.I. STA. 235+59.65
 Delta = 2°20'27.50" RT
 T = 206.36'
 L = 412.66'
 R = 10100.00'
 E = 2.11'
 e = N.C.

* - DEPTH TO PROTECT = 2.0'

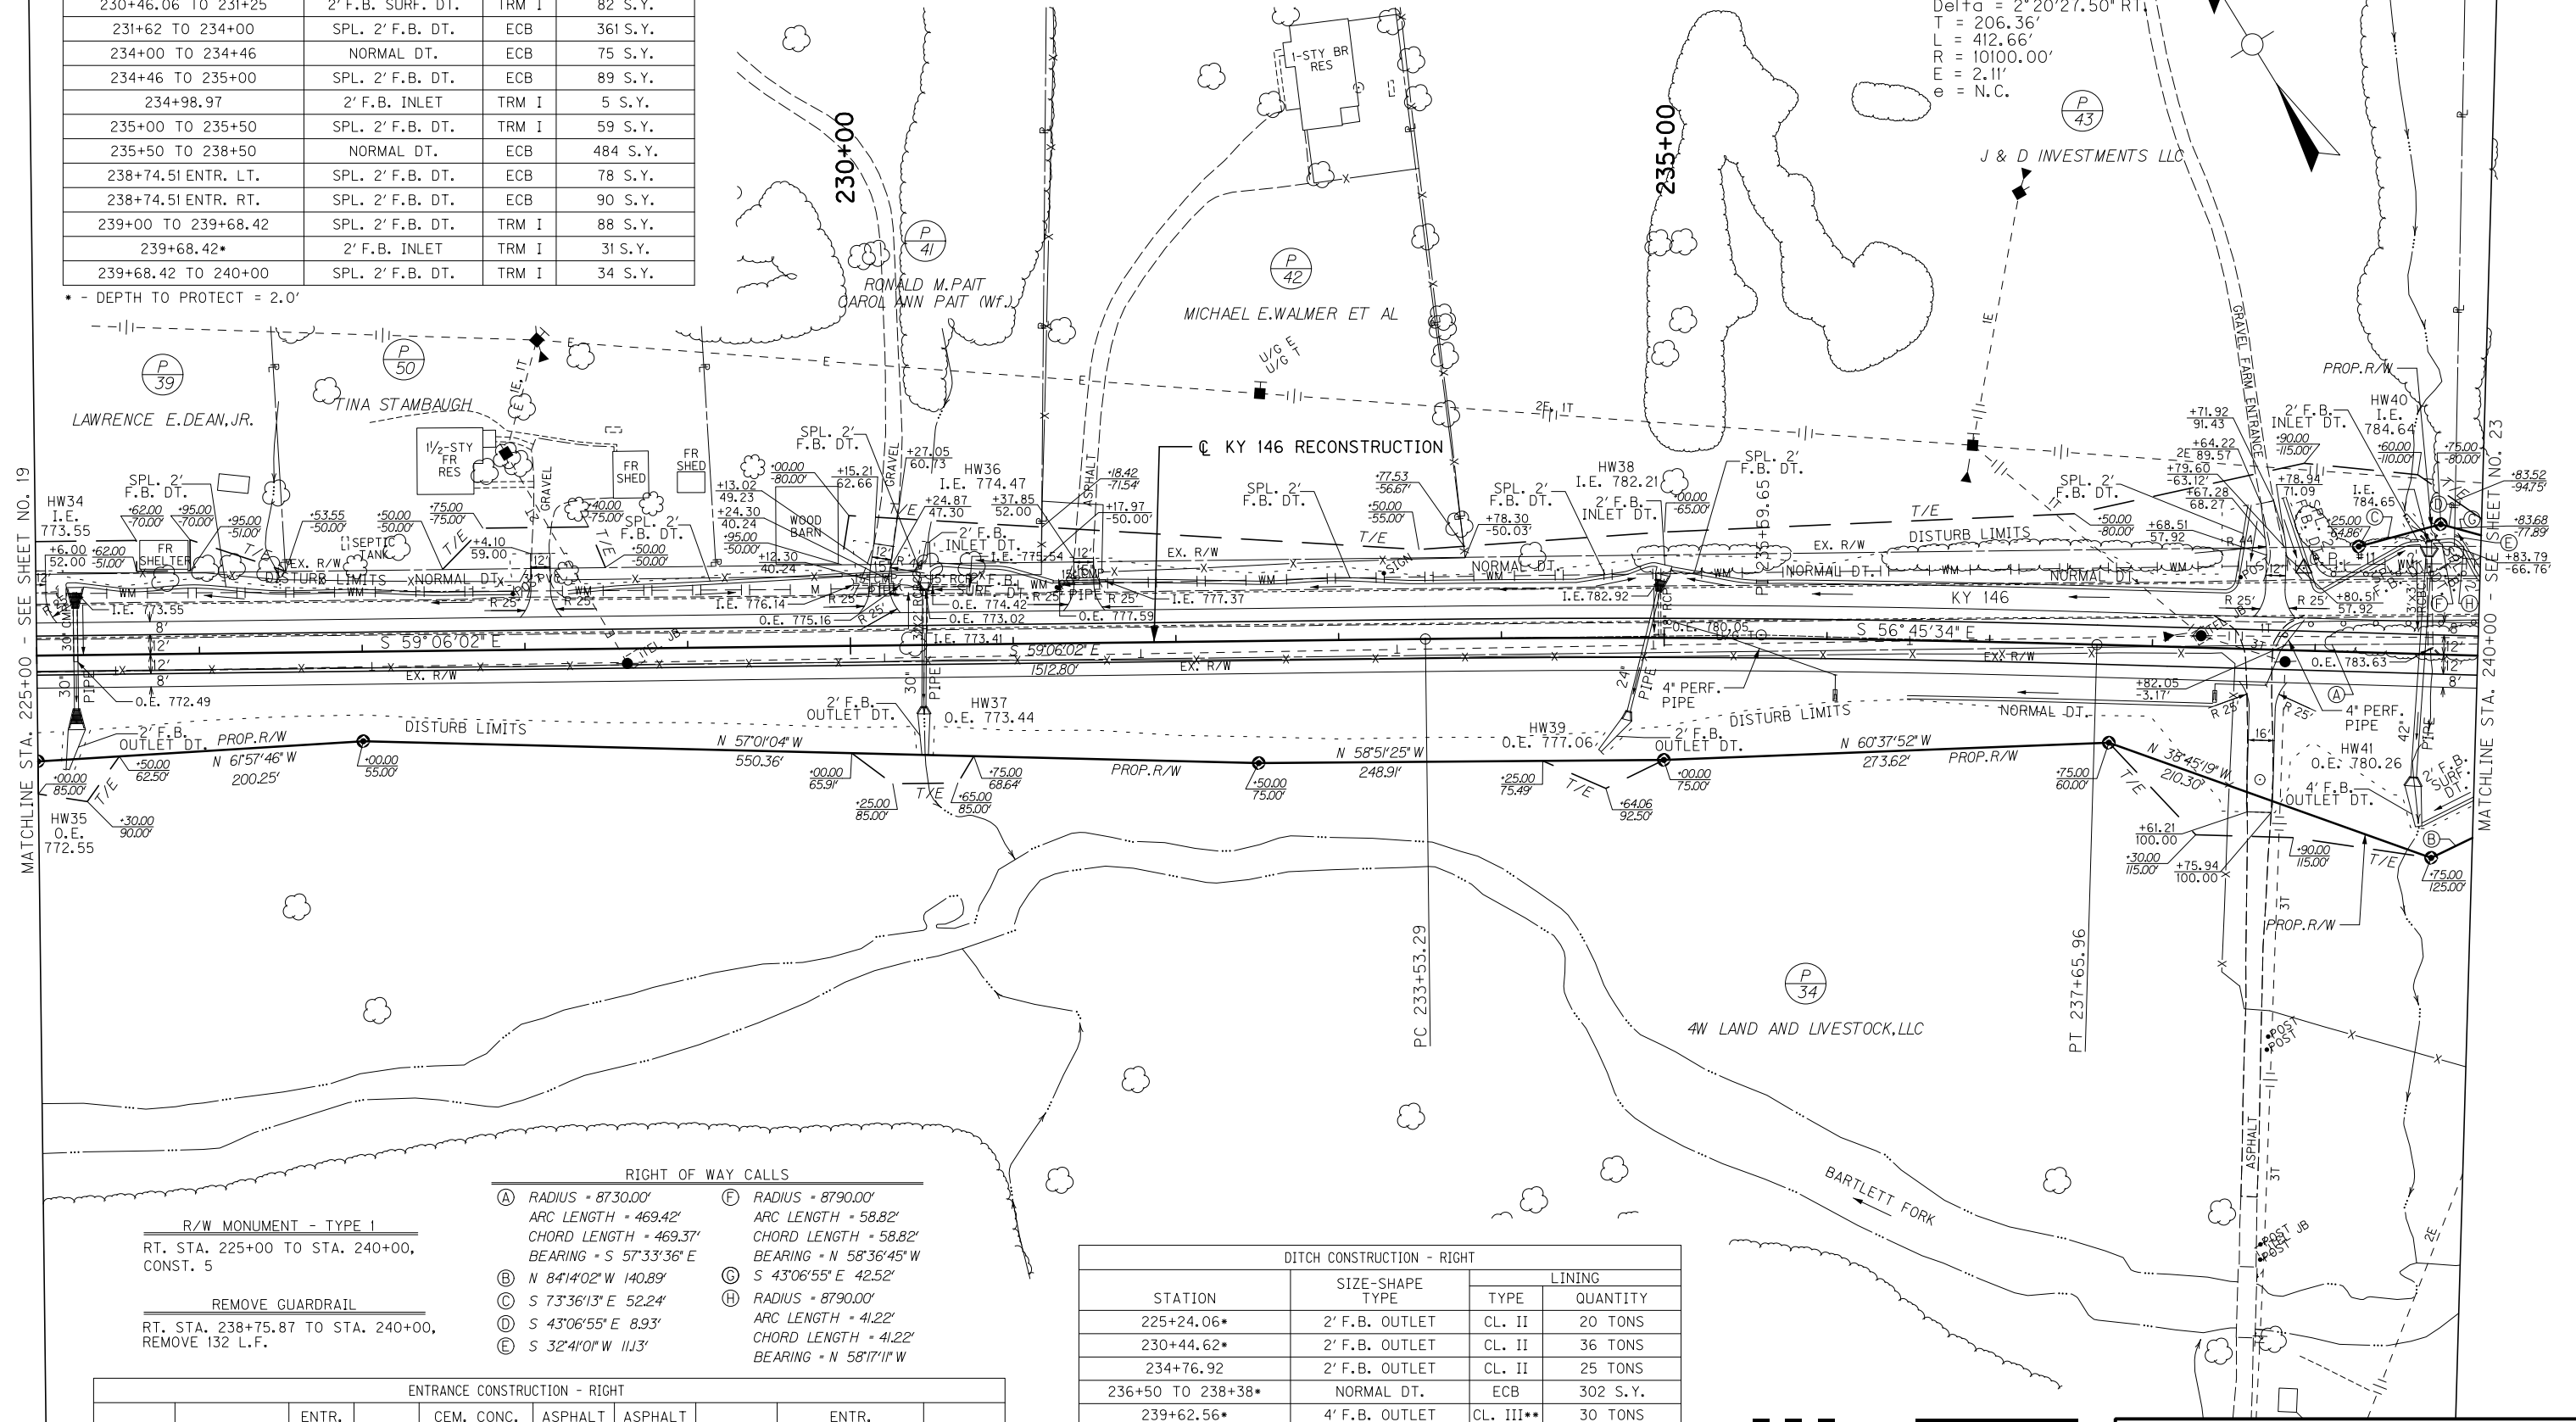

RIGHT OF WAY CALLS

(A) RADIUS = 8730.00' ARC LENGTH = 469.42' CHORD LENGTH = 469.37' BEARING = S 57°33'36" E	(F) RADIUS = 8790.00' ARC LENGTH = 58.82' CHORD LENGTH = 58.82' BEARING = N 58°36'45" W
(B) N 84°14'02" W 140.89'	(G) S 43°06'55" E 42.52'
(C) S 73°36'13" E 52.24'	(H) RADIUS = 8790.00' ARC LENGTH = 41.22' CHORD LENGTH = 41.22' BEARING = N 58°17'11" W
(D) S 43°06'55" E 8.93'	
(E) S 32°41'01" W 113.1'	


R/W MONUMENT - TYPE 1
 RT. STA. 225+00 TO STA. 240+00,
 CONST. 5

REMOVE GUARDRAIL
 RT. STA. 238+75.87 TO STA. 240+00,
 REMOVE 132 L.F.

ENTRANCE CONSTRUCTION - RIGHT									
STATION	ENTRANCE TYPE	ENTR. WIDTH (FT)	AREA (SQ YD)	CEM. CONC. ENT. PVMT. 8" (SQ. YDS.)	ASPHALT SURFACE (TONS)	ASPHALT BASE (TONS)	CSB (TONS)	ENTR. PIPE (FT)	HDWL
238+69	RESIDENTIAL	16	150	--	10	27	36	--	--

DITCH CONSTRUCTION - RIGHT			
STATION	SIZE-SHAPE TYPE	LINING	
		TYPE	QUANTITY
225+24.06*	2' F.B. OUTLET	CL. II	20 TONS
230+44.62*	2' F.B. OUTLET	CL. II	36 TONS
234+76.92	2' F.B. OUTLET	CL. II	25 TONS
236+50 TO 238+38*	NORMAL DT.	ECB	302 S.Y.
239+62.56*	4' F.B. OUTLET	CL. III**	30 TONS
239+66.73 TO 240+00	2' F.B. SURF. DT.	TRM I	35 S.Y.

* - DEPTH TO PROTECT = 1.5'
 ** - PARTIALLY GROUTED RIPRAP

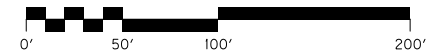


SCALE: 1"=50'

PLAN SHEET
 KY 146 RELOCATION
 STA. 225+00 TO STA. 240+00

MicroStation v8.11.7.443 E-SHEET NAME: USER: TRobinson DATE PLOTTED: December 8, 2014 FILE NAME: I:\3886-KY 146 HENRY PHASE 2\SEGMENT 1\SHEETS\PROFILES\PROFILES\RO2200PR.DGN

**RIGHT OF WAY
PLANS**

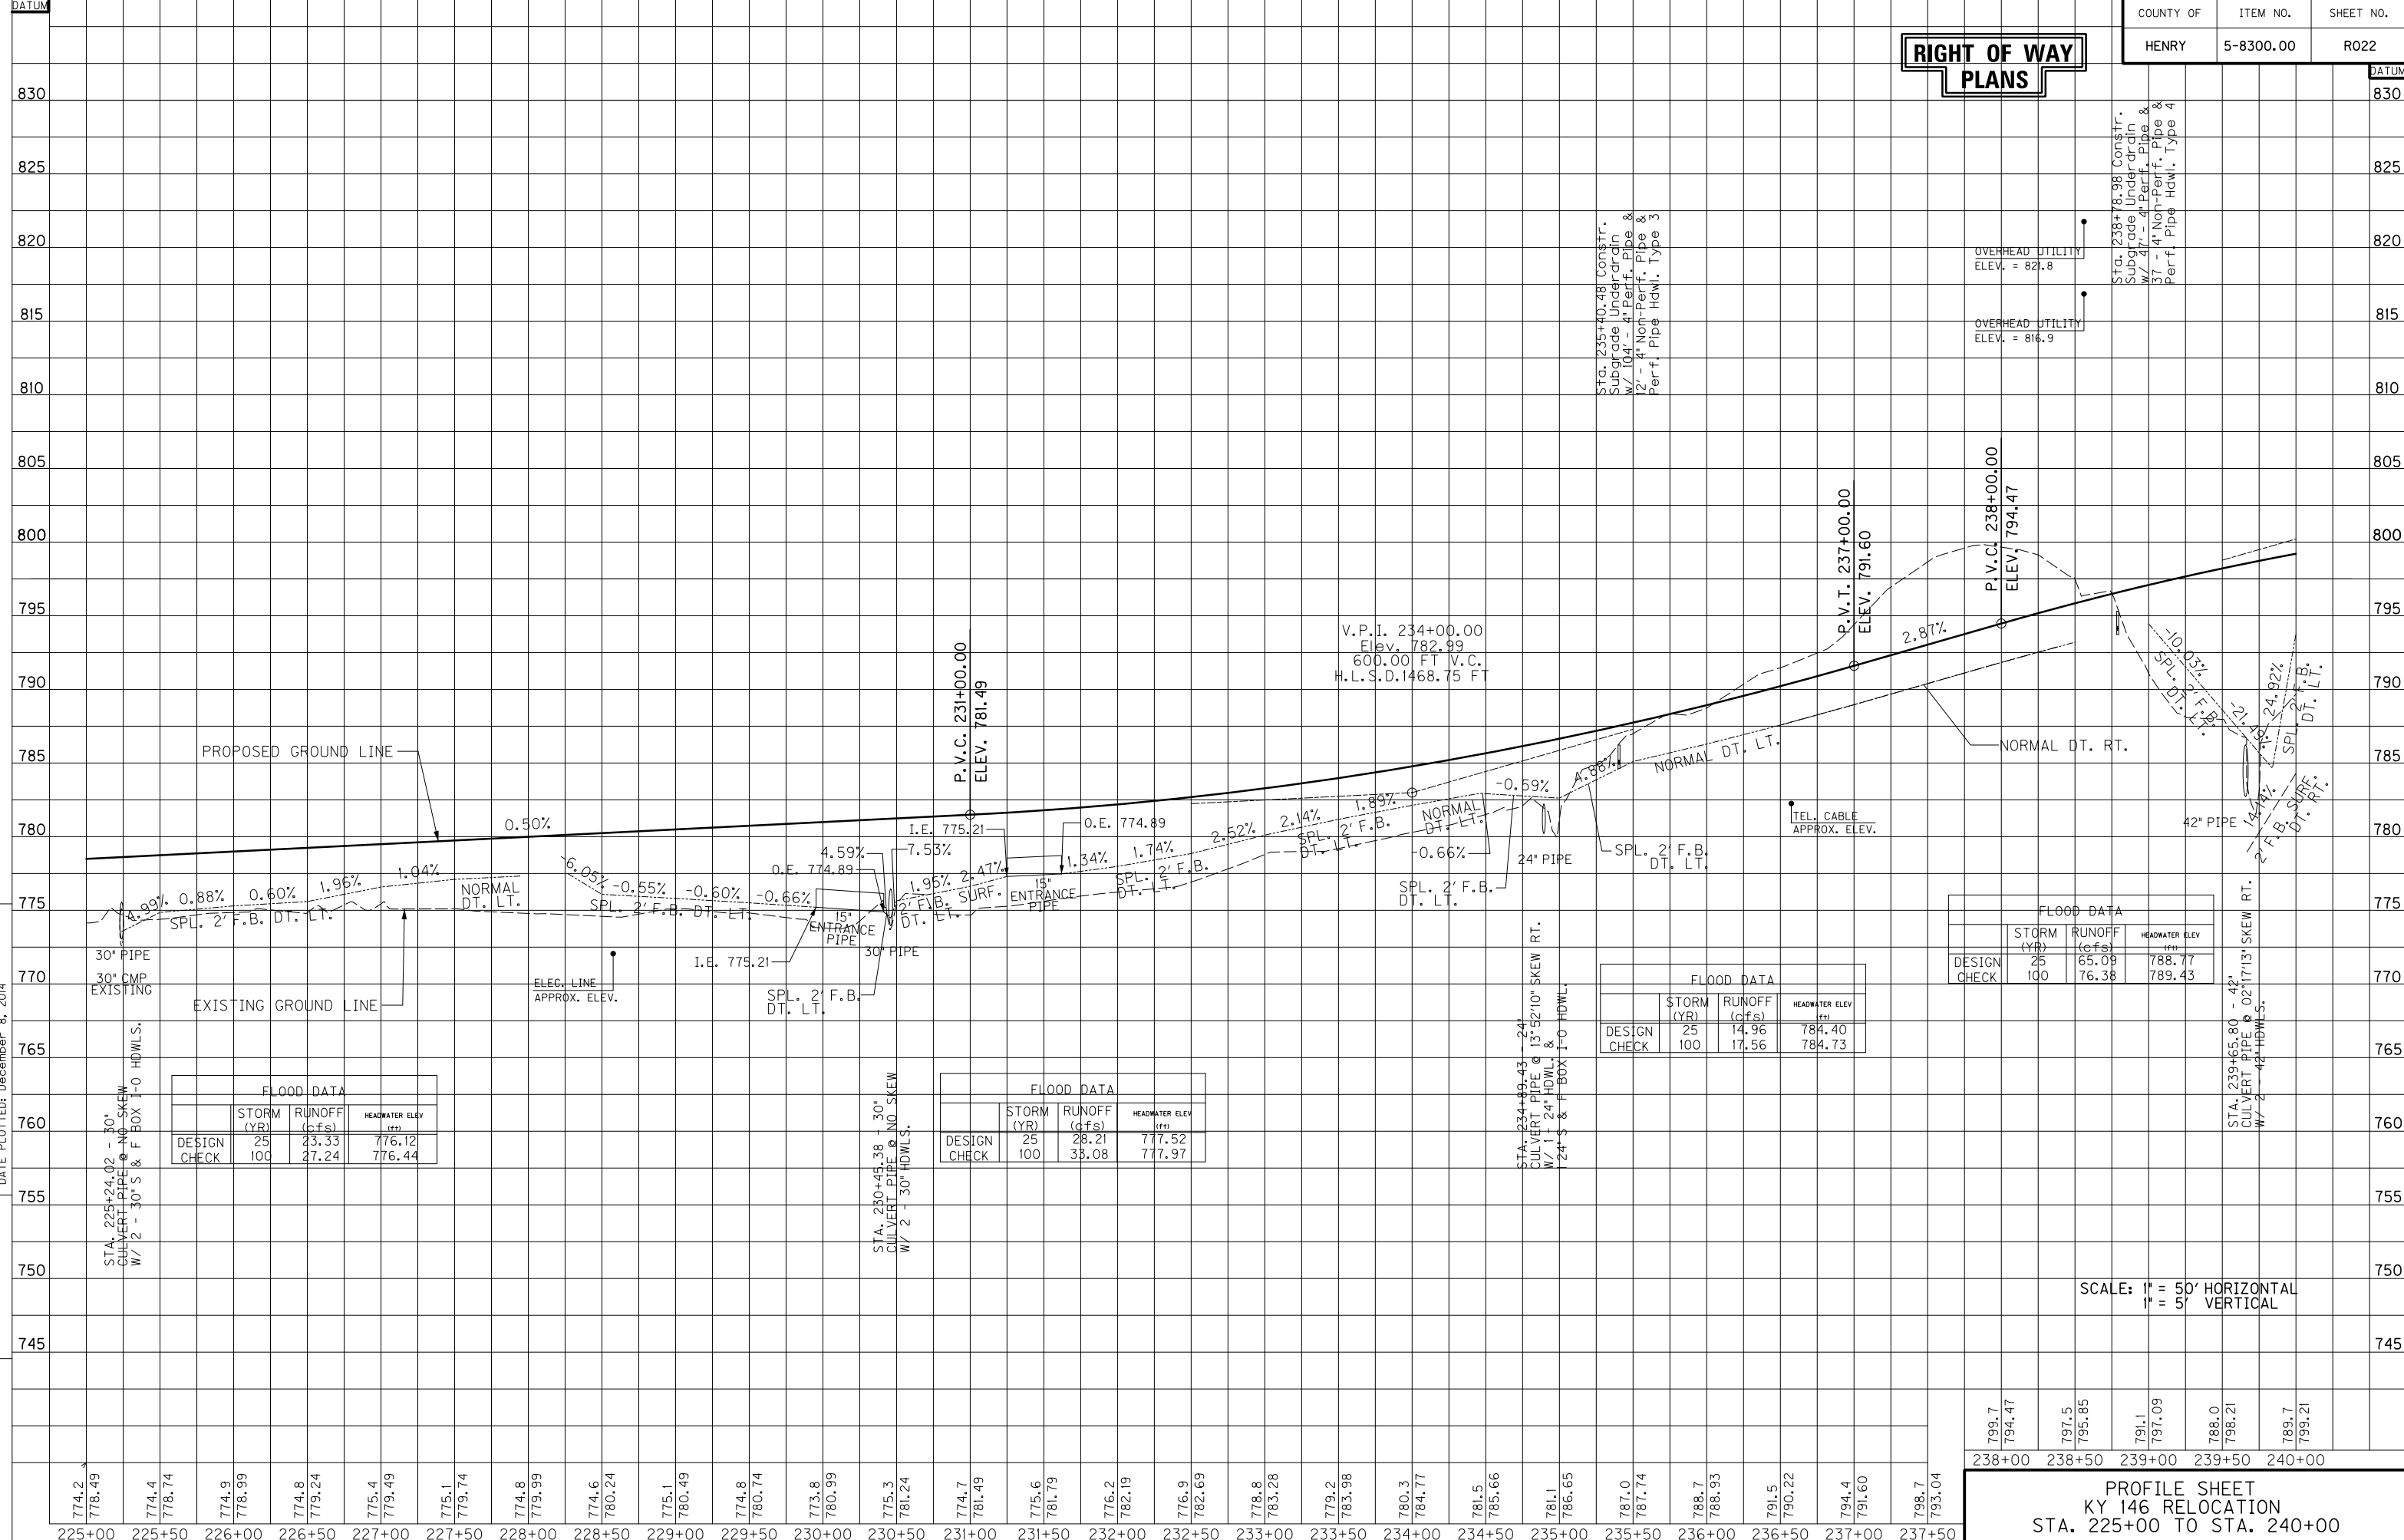

FLOOD DATA			
	STORM (YR)	RUNOFF (cfs)	HEADWATER ELEV (ft)
DESIGN	25	23.33	776.12
CHECK	100	27.24	776.44

FLOOD DATA			
	STORM (YR)	RUNOFF (cfs)	HEADWATER ELEV (ft)
DESIGN	25	28.21	777.52
CHECK	100	33.08	777.97

FLOOD DATA			
	STORM (YR)	RUNOFF (cfs)	HEADWATER ELEV (ft)
DESIGN	25	14.96	784.40
CHECK	100	17.56	784.73

FLOOD DATA			
	STORM (YR)	RUNOFF (cfs)	HEADWATER ELEV (ft)
DESIGN	25	65.09	788.77
CHECK	100	76.38	789.43

SCALE: 1" = 50' HORIZONTAL
1" = 5' VERTICAL

**PROFILE SHEET
KY 146 RELOCATION
STA. 225+00 TO STA. 240+00**


799.7	794.47	797.5	795.85	791.1	797.09	788.0	798.21	789.7	799.21
238+00	238+50	239+00	239+50	240+00					

COUNTY OF	ITEM NO.	SHEET NO.
HENRY	5-8300.00	RO23

DITCH CONSTRUCTION - LEFT			
STATION	SIZE-SHAPE TYPE	LINING	
		TYPE	QUANTITY
240+00 TO 240+12	SPL. 2' F.B. DT.	TRM I	18 S.Y.
240+12 TO 240+50	NORMAL DT.	ECB	62 S.Y.
240+50 TO 240+92.77*	SPL. 2' F.B. DT.	TRM I	69 S.Y.
241+13.82 ENTR. LT.	SPL. 2' F.B. DT.	ECB	152 S.Y.
241+13.82 ENTR. RT.	SPL. 2' F.B. DT.	ECB	134 S.Y.
241+32.77 TO 243+69.89	SPL. 2' F.B. DT.	ECB	382 S.Y.
243+69.89 TO 244+88	SPL. 2' F.B. DT.	ECB	191 S.Y.
244+88 TO 245+39.84	SPL. 2' F.B. DT.	TRM I	82 S.Y.
245+35.71*	2' F.B. INLET	TRM I	18 S.Y.
245+39.84 TO 246+04	SPL. 2' F.B. DT.	ECB	135 S.Y.
251+34.05 TO 252+00	SPL. 2' F.B. DT.	TRM I	83 S.Y.
251+94.02**	2' F.B. INLET	TRM I	44 S.Y.
252+00 TO 253+40	SPL. 2' F.B. DT.	ECB	236 S.Y.
253+40 TO 254+00	NORMAL DT.	ECB	98 S.Y.
254+00 TO 254+25.59	2' F.B. INLET	TRM I	31 S.Y.
254+82.83 TO 255+00	2' F.B. OUTLET	ECB	28 S.Y.
BROKO LANE			
9+23.59 TO 9+56.86 LT.	SPL. 2' F.B. DT.	TRM I	51 S.Y.
9+25 TO 9+57.53 RT.	SPL. 2' F.B. DT.	TRM I	49 S.Y.

ENTRANCE CONSTRUCTION - LEFT									
STATION	ENTRANCE TYPE	ENTR. WIDTH (FT)	AREA (SQ YD)	CEM. CONC. ENT. PVMT. 8" (SQ. YDS.)	ASPHALT SURFACE (TONS)	ASPHALT BASE (TONS)	CSB (TONS)	ENTR. PIPE (FT)	HDWL
241+14	RESIDENTIAL	14.6	196	--	13	36	47	40' of 15" PIPE	--
251+08	RESIDENTIAL	15	70	--	5	13	17	45' of 18" PIPE	--

* - DEPTH TO PROTECT = 1.5'
** - DEPTH TO PROTECT = 3.0'

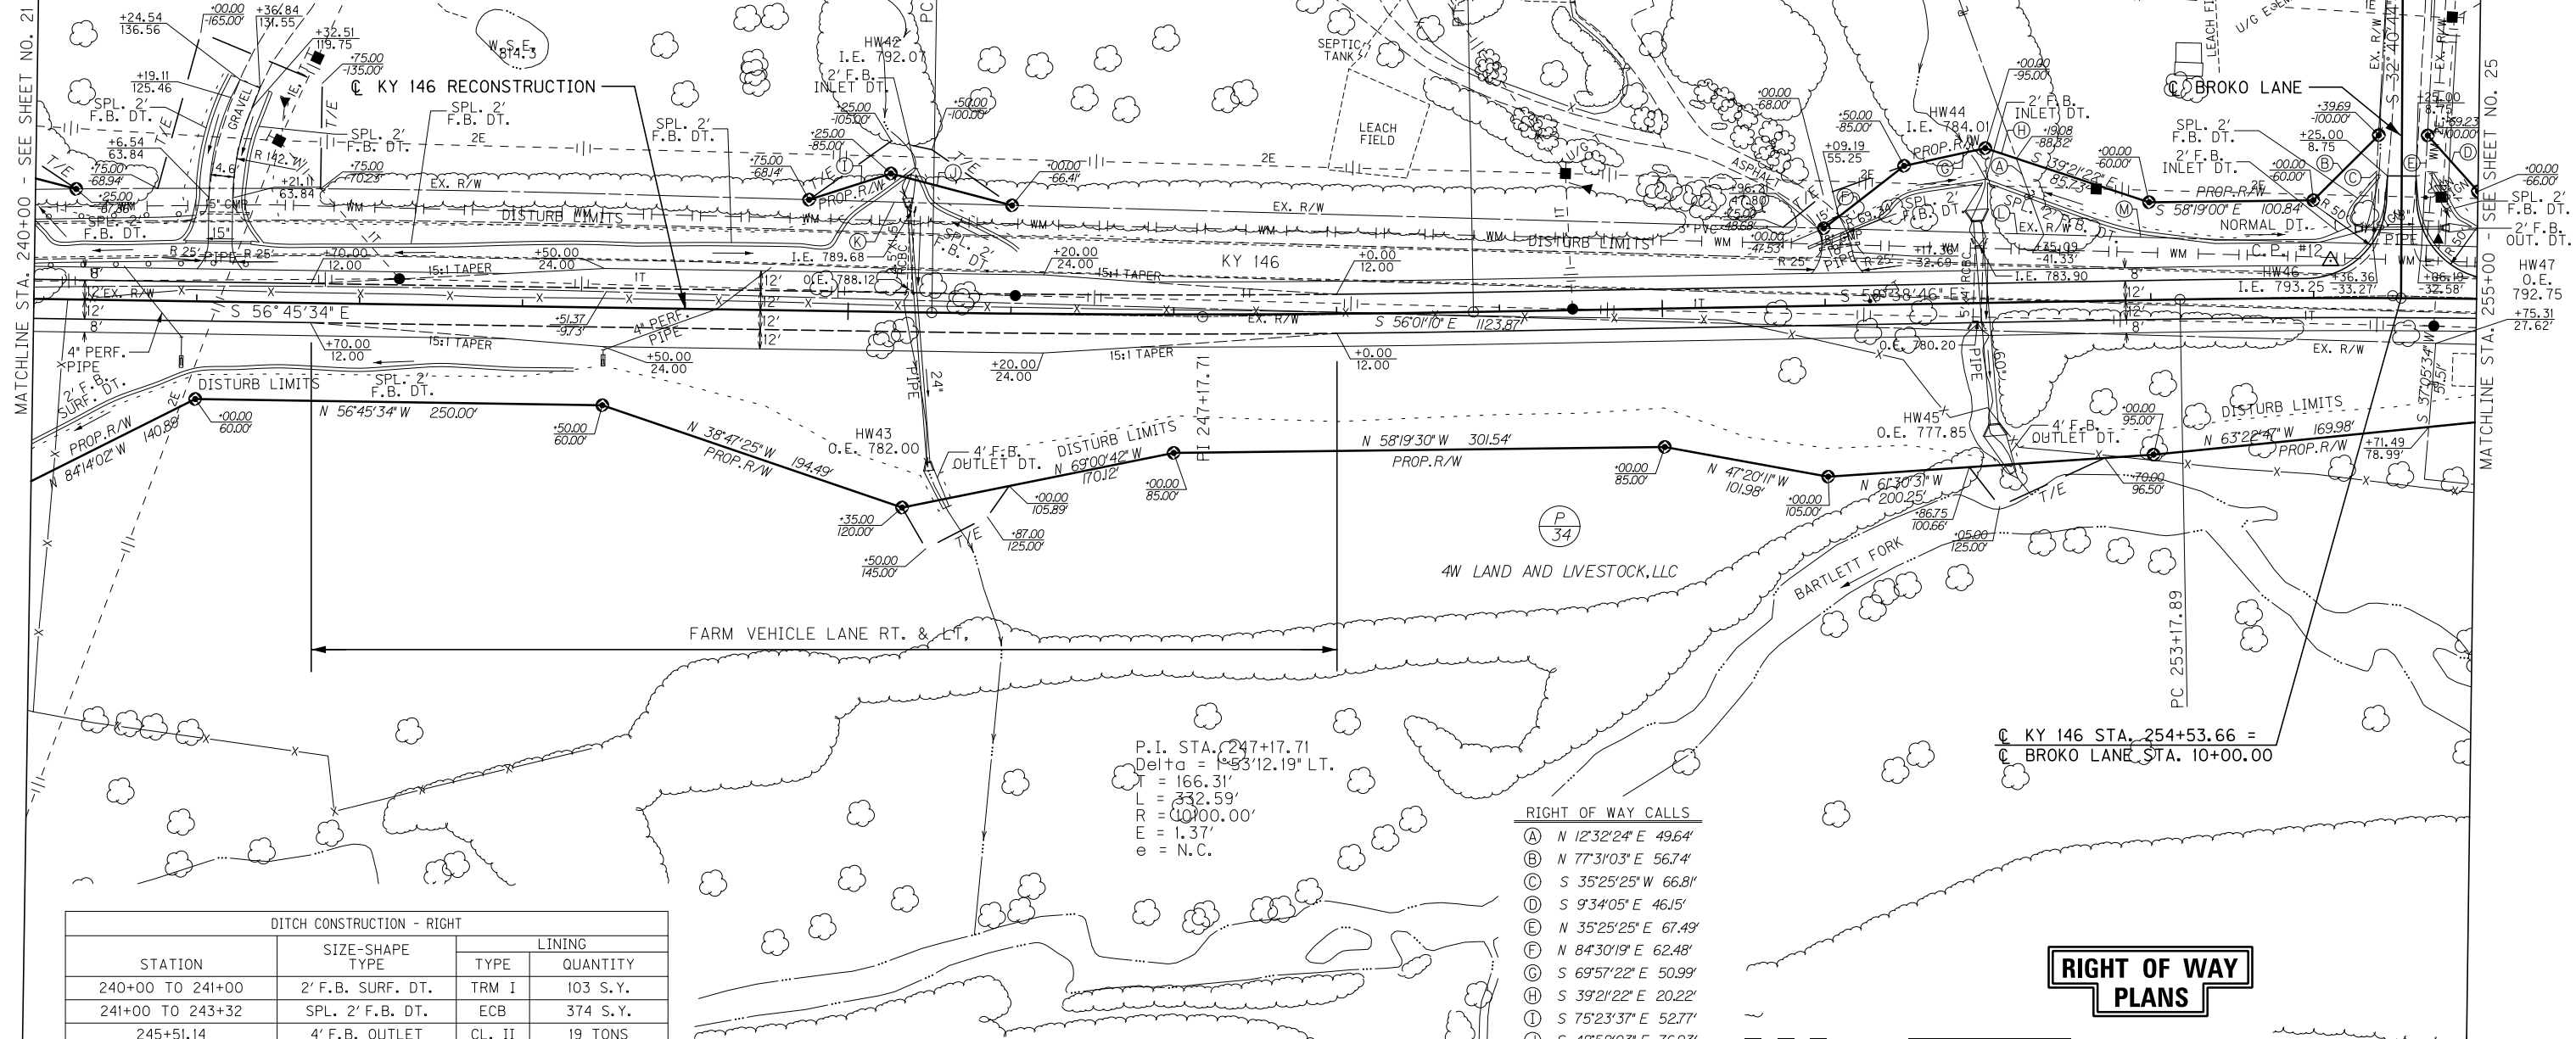


DITCH CONSTRUCTION - RIGHT			
STATION	SIZE-SHAPE TYPE	LINING	
		TYPE	QUANTITY
240+00 TO 241+00	2' F.B. SURF. DT.	TRM I	103 S.Y.
241+00 TO 243+32	SPL. 2' F.B. DT.	ECB	374 S.Y.
245+51.14	4' F.B. OUTLET	CL. II	19 TONS
252+03*	4' F.B. OUTLET	CL. III	57 TONS

* - DEPTH TO PROTECT = 2.0'

REMOVE GUARDRAIL
LT. STA. 240+00 TO STA. 241+32.19, REMOVE 133 L.F.

R/W MONUMENT - TYPE I
RT. STA. 240+00 TO STA. 255+00, CONST. 7

- RIGHT OF WAY CALLS
- (A) N 12°32'24" E 49.64'
 - (B) N 77°31'03" E 56.74'
 - (C) S 35°25'25" W 66.81'
 - (D) S 9°34'05" E 46.15'
 - (E) N 35°25'25" E 67.49'
 - (F) N 84°30'19" E 62.48'
 - (G) S 69°57'22" E 50.99'
 - (H) S 39°21'22" E 20.22'
 - (I) S 75°23'37" E 52.77'
 - (J) S 42°52'03" E 76.93'
 - (K) N 56°01'10" W 124.69'
 - (L) N 56°01'10" W 135.23'
 - (M) N 56°01'10" W 202.14'

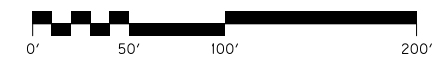

SCALE: 1"=50'


RIGHT OF WAY PLANS

PLAN SHEET
KY 146 RELOCATION
STA. 240+00 TO STA. 255+00

MATCHLINE STA. 255+00 - SEE SHEET NO. 25

MATCHLINE STA. 240+00 - SEE SHEET NO. 21

**RIGHT OF WAY
PLANS**

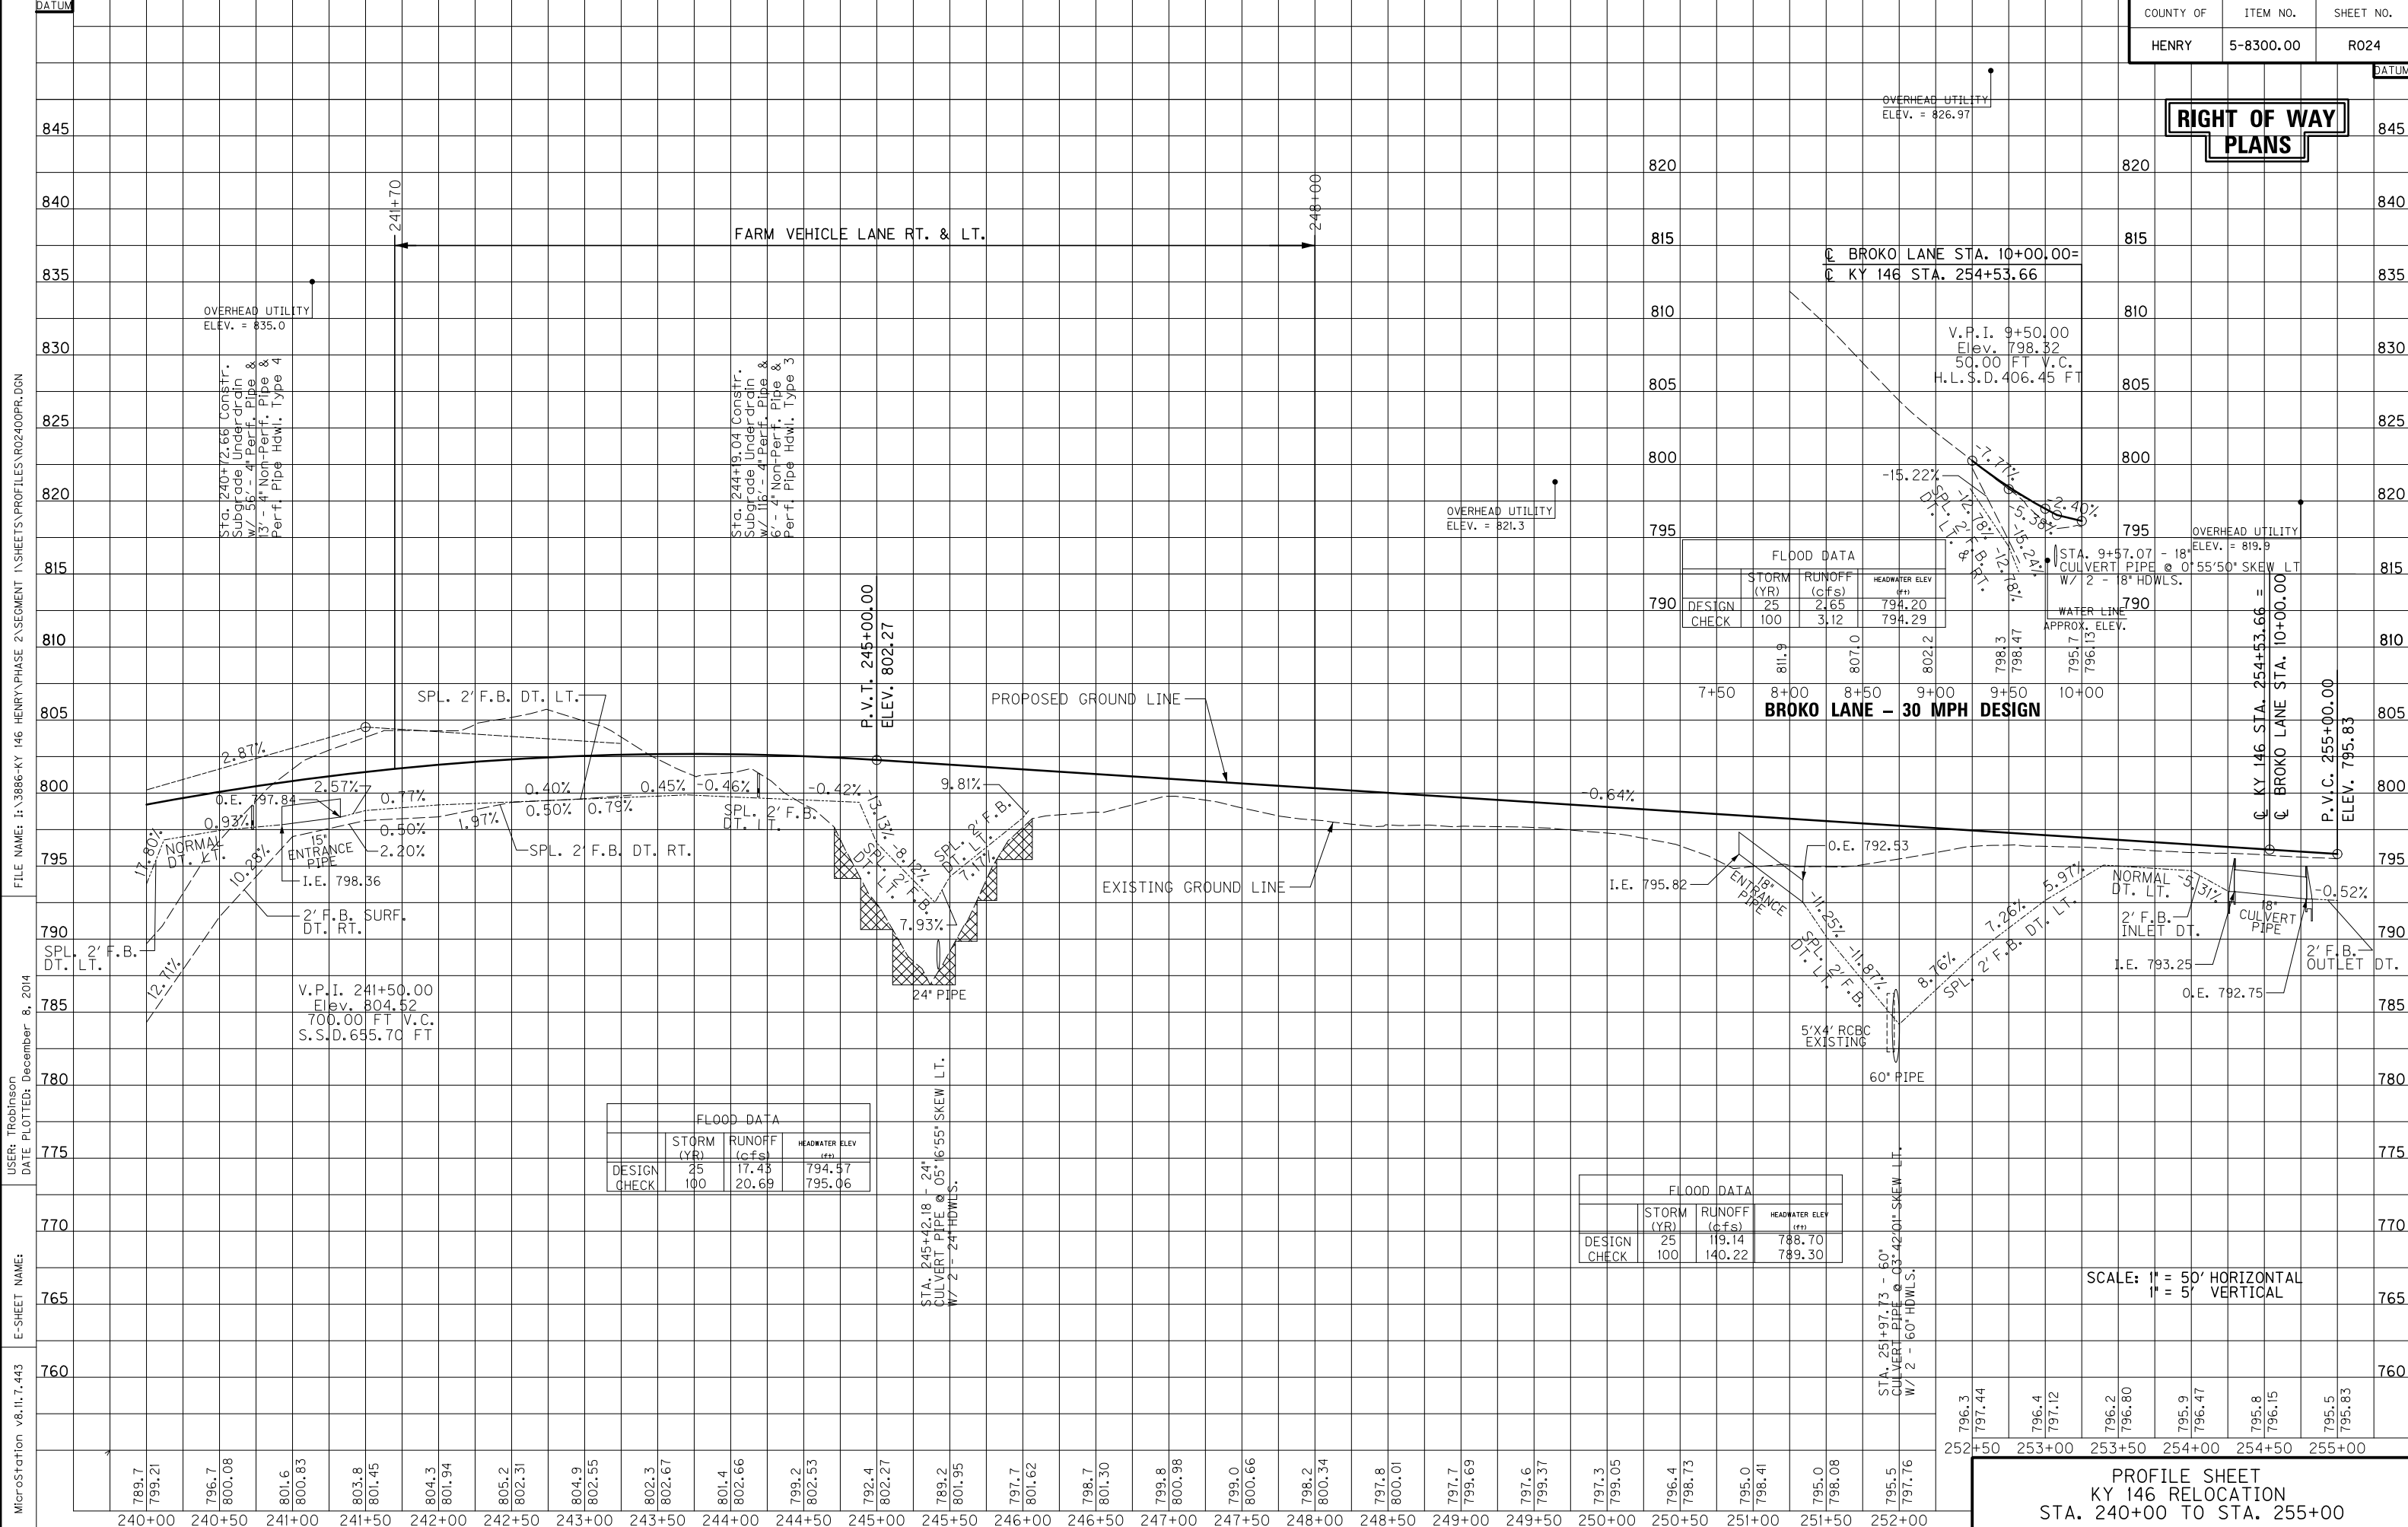

FLOOD DATA		
STORM (YR)	RUNOFF (cfs)	HEADWATER ELEV (ft)
DESIGN 25	2.65	794.20
CHECK 100	3.12	794.29

FLOOD DATA		
STORM (YR)	RUNOFF (cfs)	HEADWATER ELEV (ft)
DESIGN 25	17.45	794.57
CHECK 100	20.69	795.06

FLOOD DATA		
STORM (YR)	RUNOFF (cfs)	HEADWATER ELEV (ft)
DESIGN 25	119.14	788.70
CHECK 100	140.22	789.30

SCALE: 1" = 50' HORIZONTAL
1" = 5' VERTICAL

**PROFILE SHEET
KY 146 RELOCATION
STA. 240+00 TO STA. 255+00**

MicroStation v8.11.7.443 E-SHEET NAME: USER: TRobinson DATE PLOTTED: December 8, 2014 FILE NAME: I:\3886-KY 146 HENRY PHASE 2 SEGMENT 1\ SHEETS\PROFILES\RO2400PR.DGN

FILE NAME: I: 3886-KY 146 HENRY PHASE 2 SEGMENT 1 SENT 2014-12-12 ROW SET PLAN R02500PL.DGN
 USER: T Robinson
 DATE PLOTTED: December 8, 2014
 E-SHEET NAME: MicroStation v8.11.7.43

COUNTY OF	ITEM NO.	SHEET NO.
HENRY	5-8300.00	R025

DITCH CONSTRUCTION - LEFT			
STATION	SIZE-SHAPE TYPE	LINING	
		TYPE	QUANTITY
255+00 TO 257+40.55*	SPL. 2' F.B. DT.	TRM I	389 S.Y.
257+62.65 ENTR. LT.	SPL. 2' F.B. DT.	ECB	88 S.Y.
257+62.65 ENTR. RT.	SPL. 2' F.B. DT.	ECB	86 S.Y.
257+86.55 TO 258+19.14	SPL. 2' F.B. DT.	TRM I	39 S.Y.
258+19.14	2' F.B. INLET	TRM II	24 S.Y.
258+19.14 TO 259+00	SPL. 2' F.B. DT.	ECB	132 S.Y.
259+00 TO 261+23.07	NORMAL DT.	ECB	360 S.Y.
261+43.45 ENTR. LT.	SPL. 2' F.B. DT.	TRM I	15 S.Y.
261+43.45 ENTR. RT.	SPL. 2' F.B. DT.	TRM I	37 S.Y.
261+63.07 TO 262+50	SPL. 2' F.B. DT.	ECB	140 S.Y.
262+50 TO 262+84.46	SPL. 2' F.B. DT.	TRM I	36 S.Y.
263+25.29 TO 263+44.22	SPL. 2' F.B. DT.	TRM I	19 S.Y.
263+44.34*	2' F.B. INLET	TRM 4	32 S.Y.
263+44.22 TO 265+64.99	SPL. 2' F.B. DT.	ECB	283 S.Y.
266+84.60	2' F.B. OUTLET	CL. II	48 TONS


* - DEPTH TO PROTECT = 1.5'

ENTRANCE CONSTRUCTION - LEFT									
STATION	ENTRANCE TYPE	ENTR. WIDTH (FT)	AREA (SQ YD)	CEM. CONC. ENT. PVMT. 8" (SQ. YDS.)	ASPHALT SURFACE (TONS)	ASPHALT BASE (TONS)	CSB (TONS)	ENTR. PIPE (FT)	HDWL
257+63	RESIDENTIAL	14.6	146	--	10	26	35	46' of 24" PIPE	--
261+43	RESIDENTIAL	12	187	--	13	34	46	40' of 15" PIPE	--
263+03	RESIDENTIAL	12	60	60	--	--	16	41' of 18" PIPE	--
265+94	RESIDENTIAL	12	58	--	4	11	14	--	--

R/W MONUMENT - TYPE 1
 LT. STA. 255+00 TO STA. 270+00, CONST. 7

ISLAND HEADER CURB TY 2
 LT. STA. 266+94.27 TO STA. 267+11.35, CONST. 17.25 L.F.
 LT. STA. 268+08.80 TO STA. 268+33.80, CONST. 25.00 L.F.

REMOVE GUARDRAIL
 LT. STA. 266+10.10 TO STA. 267+09.73, REMOVE 105 L.F.
 LT. STA. 268+04.82 TO STA. 270+00, REMOVE 198 L.F.
 STEEL *W* BEAM GUARDRAIL
 LT. STA. 266+02.23 TO STA. 267+12.41, CONST. 125.00 L.F. W/1 GUARDRAIL BRIDGE CONNECTOR TYPE A AND 1 TERMINAL SECTION NO. 1
 LT. STA. 268+07.75 TO STA. 270+00, CONST. 194.72 L.F. W/1 GUARDRAIL BRIDGE CONNECTOR TYPE A

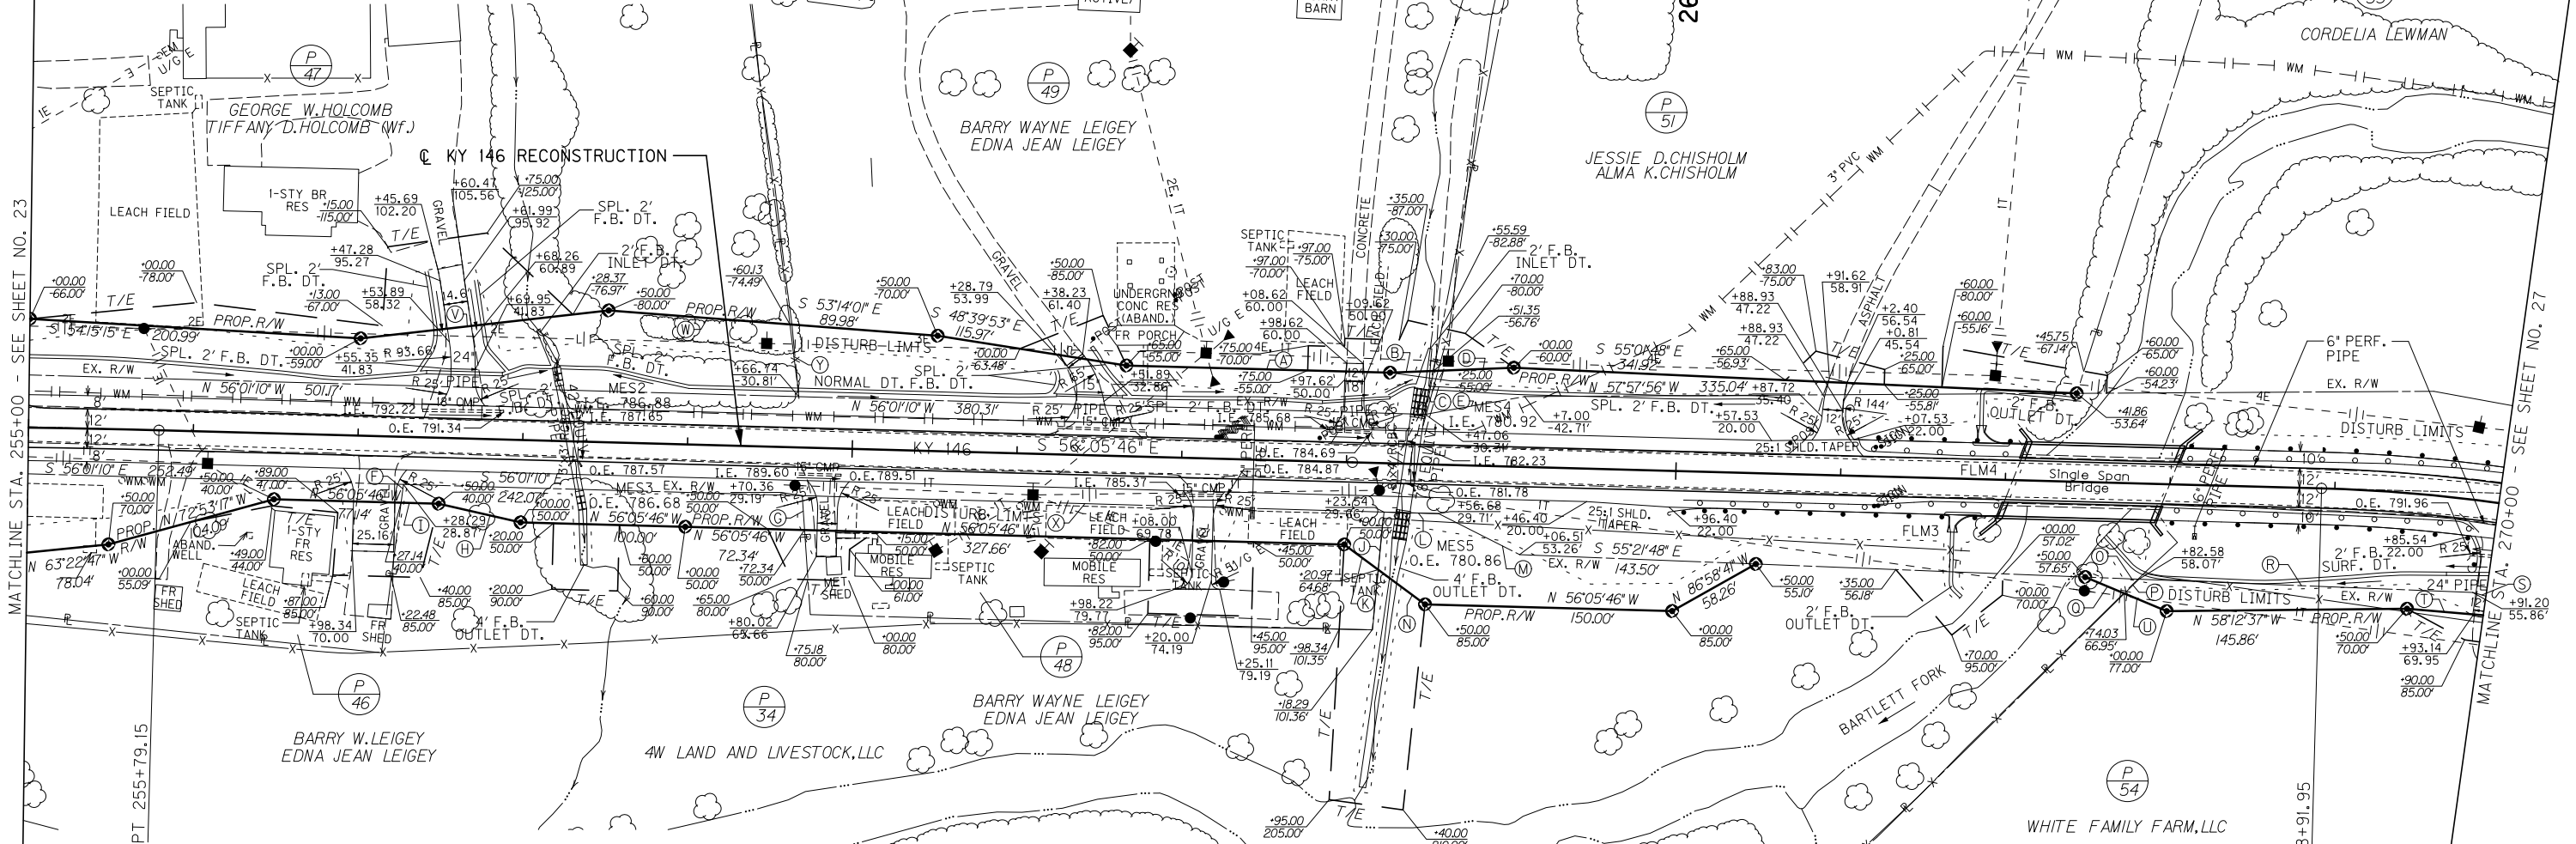

DITCH CONSTRUCTION - RIGHT			
STATION	SIZE-SHAPE TYPE	LINING	
		TYPE	QUANTITY
258+36.58*	4' F.B. OUTLET	CL. II	161 TONS
263+33.28**	4' F.B. OUTLET	CL. II	491 TONS
266+68.59	2' F.B. OUTLET	CL. II	25 TONS
267+61.48 TO 269+73.09	2' F.B. SURF. DT.	TRM I	199 S.Y.

* - DEPTH TO PROTECT = 2.5'
 ** - DEPTH TO PROTECT = 3.5'

ENTRANCE CONSTRUCTION - RIGHT									
STATION	ENTRANCE TYPE	ENTR. WIDTH (FT)	AREA (SQ YD)	CEM. CONC. ENT. PVMT. 8" (SQ. YDS.)	ASPHALT SURFACE (TONS)	ASPHALT BASE (TONS)	CSB (TONS)	ENTR. PIPE (FT)	HDWL
257+11	RESIDENTIAL	25.16	148	--	10	27	35	--	--
259+86	RESIDENTIAL	12	69	--	5	12	17	--	--
262+14	RESIDENTIAL	12	90	--	6	16	22	--	--

CONSTRUCT 4' SIDEWALK
 RT. STA. 259+92.02 TO STA. 260+03.20, CONST. 4 S.Y. ALL SIDEWALKS SHALL BE ADA COMPLIANT.

R/W MONUMENT - TYPE 1
 RT. STA. 255+00 TO STA. 270+00, CONST. 12

ISLAND HEADER CURB TY 2
 RT. STA. 266+78.26 TO STA. 266+95.34, CONST. 17.25 L.F.

STEEL *W* BEAM GUARDRAIL
 RT. STA. 264+96.40 TO STA. 266+96.40, CONST. 162.50 L.F. W/1 GUARDRAIL BRIDGE CONNECTOR TYPE A AND 1 END TREATMENT TYPE 4A

REMOVE GUARDRAIL
 RT. STA. 265+05.09 TO STA. 266+99.32, REMOVE 195 L.F.
 RT. STA. 267+94.52 TO STA. 269+86.83, REMOVE 192 L.F.

- RIGHT OF WAY CALLS
- (A) S 56°05'46" E 160.00'
 - (B) S 59°54'36" E 26.41'
 - (C) S 43°07'31" W 26.80'
 - (D) S 59°54'36" E 48.76'
 - (E) N 67°47'06" W 61.21'
 - (F) S 39°48'59" W 111.9'
 - (G) S 28°29'30" W 20.90'
 - (H) N 44°47'10" W 50.99'
 - (I) N 56°05'46" W 22.86'
 - (J) S 38°05'35" W 35.11'
 - (K) N 21°06'15" W 25.60'
 - (L) S 56°01'10" E 33.14'
 - (M) S 30°47'38" E 55.12'
 - (N) N 21°06'15" W 35.43'
 - (O) S 55°21'48" E 32.58'
 - (P) S 77°48'22" W 12.33'
 - (Q) N 34°56'41" W 25.77'
 - (R) S 55°21'48" E 202.73'
 - (S) S 42°03'40" E 246.25'
 - (T) N 52°45'19" W 93.10'
 - (U) N 34°56'41" W 27.85'
 - (V) S 64°03'56" E 151.46'
 - (W) S 53°14'01" E 110.27'
 - (X) S 56°01'10" E 353.18'
 - (Y) N 25°17'39" E 44.18'




PLAN SHEET
 KY 146 RELOCATION
 STA. 255+00 TO 270+00

RIGHT OF WAY PLANS

RIGHT OF WAY PLANS

Longitudinal Pavement Edge Drain Systems
 Lt. Sta. 268+04.35 to Lt. Sta. 268+61.06, Const. 57' - 6" Perf. Pipe, Tie to Transverse Drain at Sta. 268+24.74
 Rt. Sta. 267+95.15 to Rt. Sta. 273+24.31, Const. 500' - 6" Perf. Pipe, Tie to Transverse Drain at Sta. 268+24.74

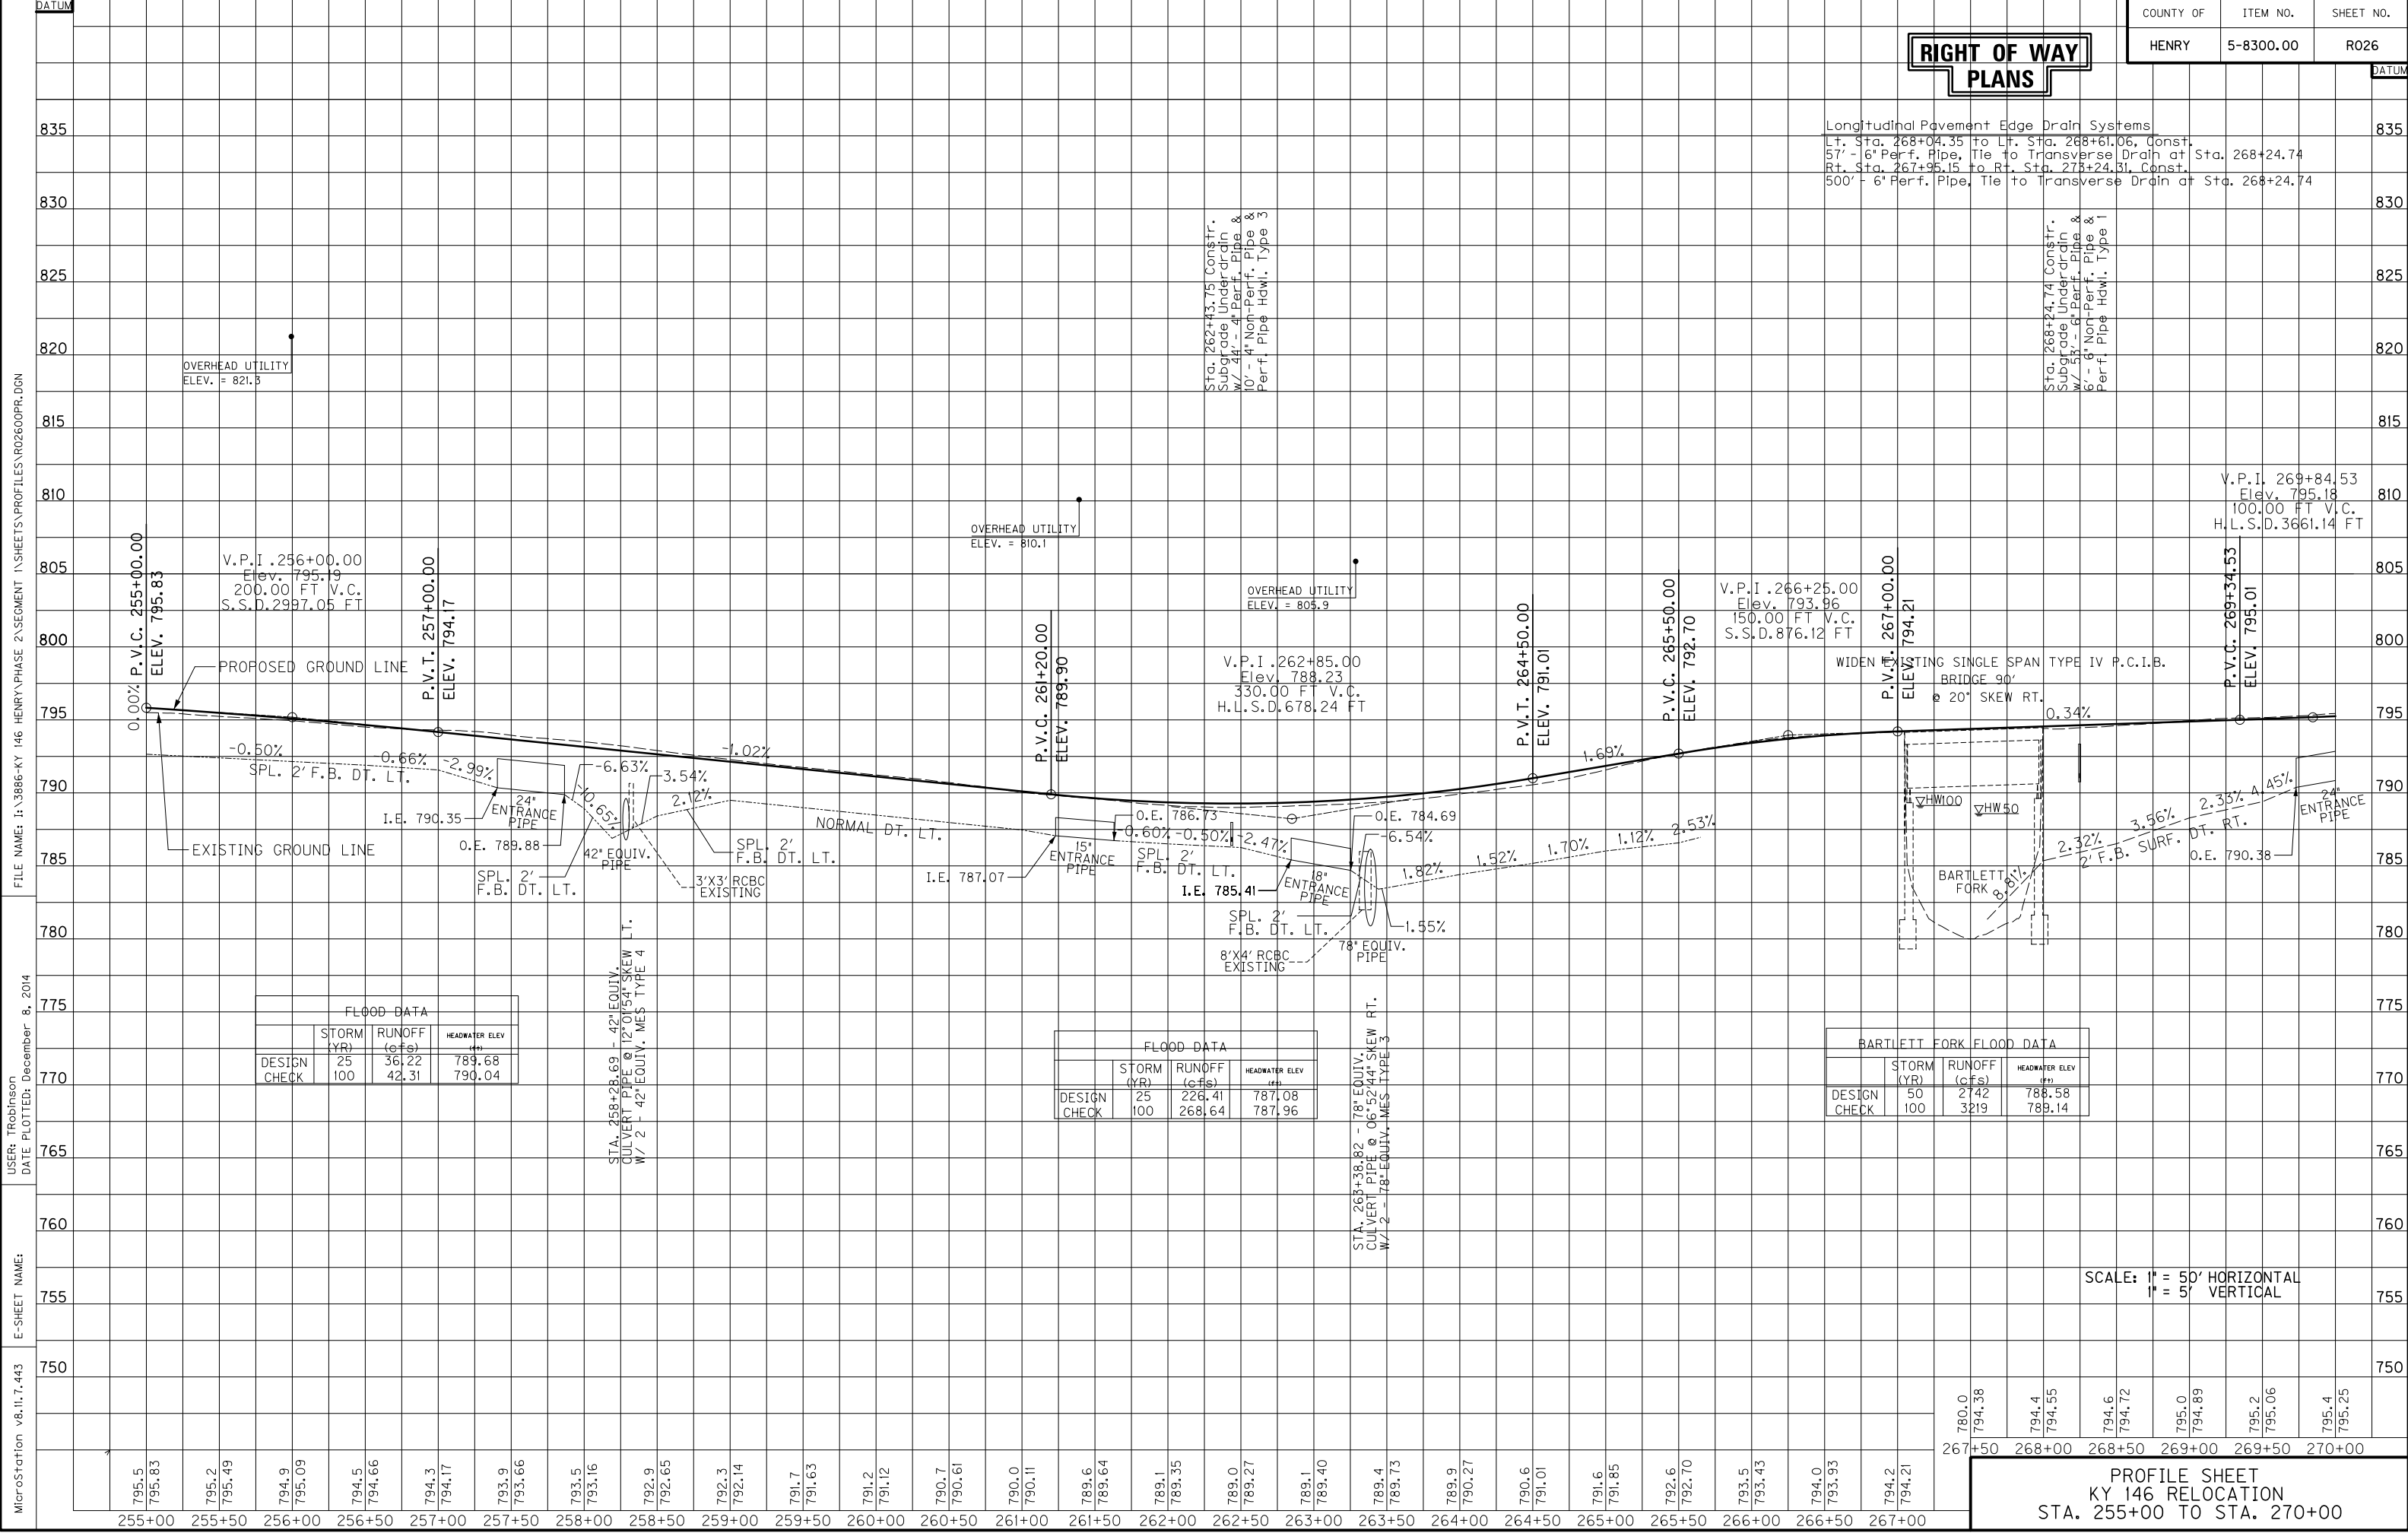

FLOOD DATA			
	STORM (YR)	RUNOFF (cfs)	HEADWATER ELEV (ft)
DESIGN CHECK	25	36.22	789.68
	100	42.31	790.04

FLOOD DATA			
	STORM (YR)	RUNOFF (cfs)	HEADWATER ELEV (ft)
DESIGN CHECK	25	226.41	787.08
	100	268.64	787.96

BARTLETT FORK FLOOD DATA			
	STORM (YR)	RUNOFF (cfs)	HEADWATER ELEV (ft)
DESIGN CHECK	50	2142	788.58
	100	3219	789.14

SCALE: 1" = 50' HORIZONTAL
 1" = 5' VERTICAL

MicroStation v8.11.7.443 E-SHEET NAME: DATE PLOTTED: December 8, 2014 USER: TRobinson FILE NAME: I:\3886-KY 146 HENRY PHASE 2\SEGMENT 1\SHEETS\PROFILES\R02600PR.DGN

RIGHT OF WAY PLANS

STEEL "W" BEAM GUARDRAIL
 LT. STA. 270+00 TO STA. 271+99.07,
 CONST. 217.78 L.F. W/I TERMINAL SECTION NO. 1

REMOVE GUARDRAIL
 LT. STA. 272+15.26 TO STA. 285+00,
 CONST. 1300.00 L.F. W/I TERMINAL SECTION NO. 1

LT. STA. 270+00 TO STA. 271+95.60,
 REMOVE 207 L.F.

LT. STA. 272+19.14 TO STA. 285+00,
 REMOVE 1290 L.F.

ENTRANCE CONSTRUCTION - LEFT									
STATION	ENTRANCE TYPE	ENTR. WIDTH (FT)	AREA (SQ YD)	CEM. CONC. ENT. PVMT. 8" (SQ. YDS.)	ASPHALT SURFACE (TONS)	ASPHALT BASE (TONS)	CSB (TONS)	ENTR. PIPE (FT)	HDWL
272+08	RESIDENTIAL	12.5	58	--	4	10	14	--	--


DITCH CONSTRUCTION - LEFT			
STATION	SIZE-SHAPE TYPE	LINING	
		TYPE	QUANTITY
278+06	4' F.B. OUTLET	CL. III	40 TONS

DITCH CONSTRUCTION - RIGHT			
STATION	SIZE-SHAPE TYPE	LINING	
		TYPE	QUANTITY
270+25 TO 270+50	2' F.B. SURF. DT.	ECB	32 S.Y.
270+50 TO 270+70	SPL. 2' F.B. DT.	ECB	26 S.Y.
270+70 TO 274+00	NORMAL DT.	ECB	510 S.Y.
275+50 TO 278+06	2' F.B. SURF. DT.	ECB	239 S.Y.
278+06	4' F.B. INLET	TRM I	63 S.Y.
278+06 TO 281+50	2' F.B. SURF. DT.	TRM I	515 S.Y.
281+50 TO 285+00	NORMAL DT.	ECB	496 S.Y.
284+70	2' INTERCEPTOR DT.	TRM I	23 S.Y.

P.I. STA. 273+63.35
 Delta = 52°04'15.70" RT.
 T = 471.40'
 L = 877.00'
 R = 965.00'
 E = 108.99'
 e = 8.0%
 RUNOFF = 204.26'
 RUNOUT = 51.06'

P.I. STA. 284+80.06
 Delta = 39°43'06.08" LT.
 T = 491.22'
 L = 942.77'
 R = 1360.00'
 E = 85.99'
 e = 7.3%
 RUNOFF = 186.38'
 RUNOUT = 51.06'

FILE NAME: I:\3886-KY 146 HENRY PHASE 2\SEGMENT 1\SENT\2014-12-12 ROW SET\PLAN\RO27OOP\PL-DGN
 USER: TRobinson
 DATE PLOTTED: December 8, 2014
 E-SHEET NAME:
 MicroStation v8.11.7.443

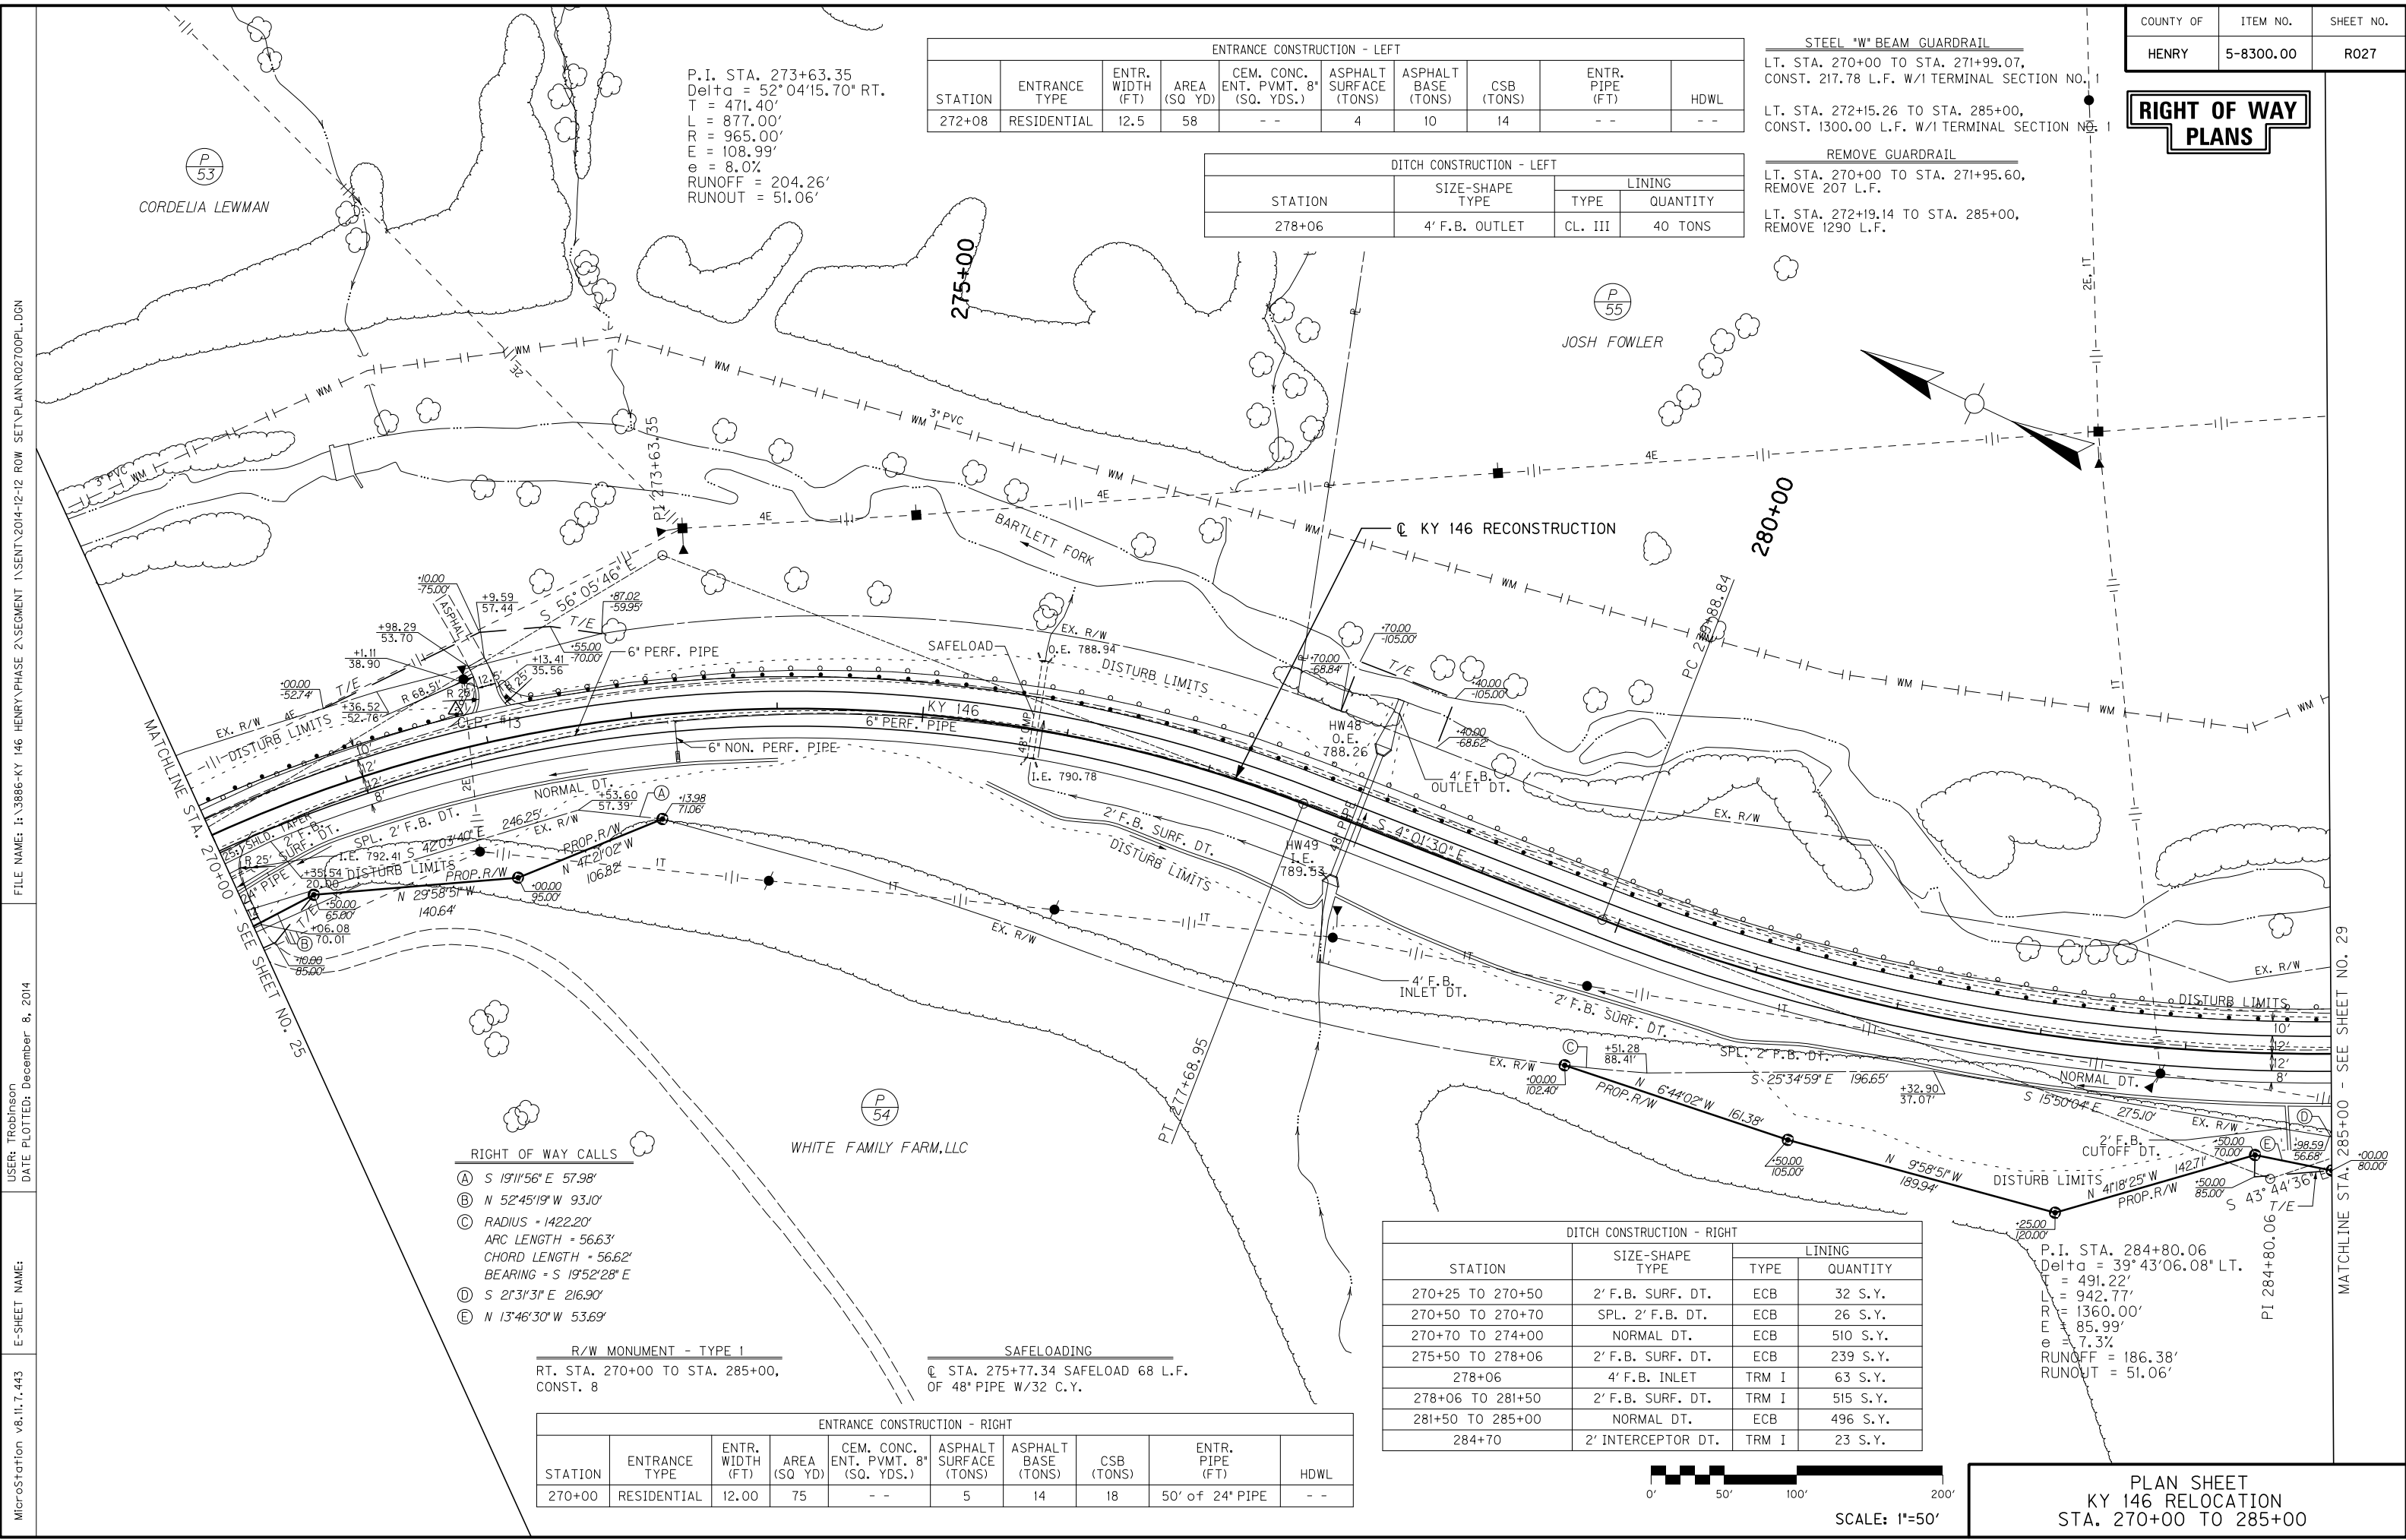

- RIGHT OF WAY CALLS**
- (A) S 19°11'56" E 57.98'
 - (B) N 52°45'19" W 93.10'
 - (C) RADIUS = 1422.20'
ARC LENGTH = 56.63'
CHORD LENGTH = 56.62'
BEARING = S 19°52'28" E
 - (D) S 27°31'3" E 216.90'
 - (E) N 13°46'30" W 53.69'

R/W MONUMENT - TYPE 1
 RT. STA. 270+00 TO STA. 285+00,
 CONST. 8

SAFELOADING
 @ STA. 275+77.34 SAFeload 68 L.F.
 OF 48" PIPE W/32 C.Y.

ENTRANCE CONSTRUCTION - RIGHT									
STATION	ENTRANCE TYPE	ENTR. WIDTH (FT)	AREA (SQ YD)	CEM. CONC. ENT. PVMT. 8" (SQ. YDS.)	ASPHALT SURFACE (TONS)	ASPHALT BASE (TONS)	CSB (TONS)	ENTR. PIPE (FT)	HDWL
270+00	RESIDENTIAL	12.00	75	--	5	14	18	50' of 24" PIPE	--




PLAN SHEET
 KY 146 RELOCATION
 STA. 270+00 TO 285+00

MATCHLINE STA. 285+00 - SEE SHEET NO. 29

MATCHLINE STA. 270+00 - SEE SHEET NO. 25

**RIGHT OF WAY
PLANS**

Longitudinal Pavement Edge Drain Systems
 Rt. Sta. 273+29.31 to Lt. Sta. 278+83.93, Const.
 554' - 6" Perf. Pipe &
 22' - 6" Non. Perf. Pipe &
 1 - Perf. Pipe Hdwl, Type 4

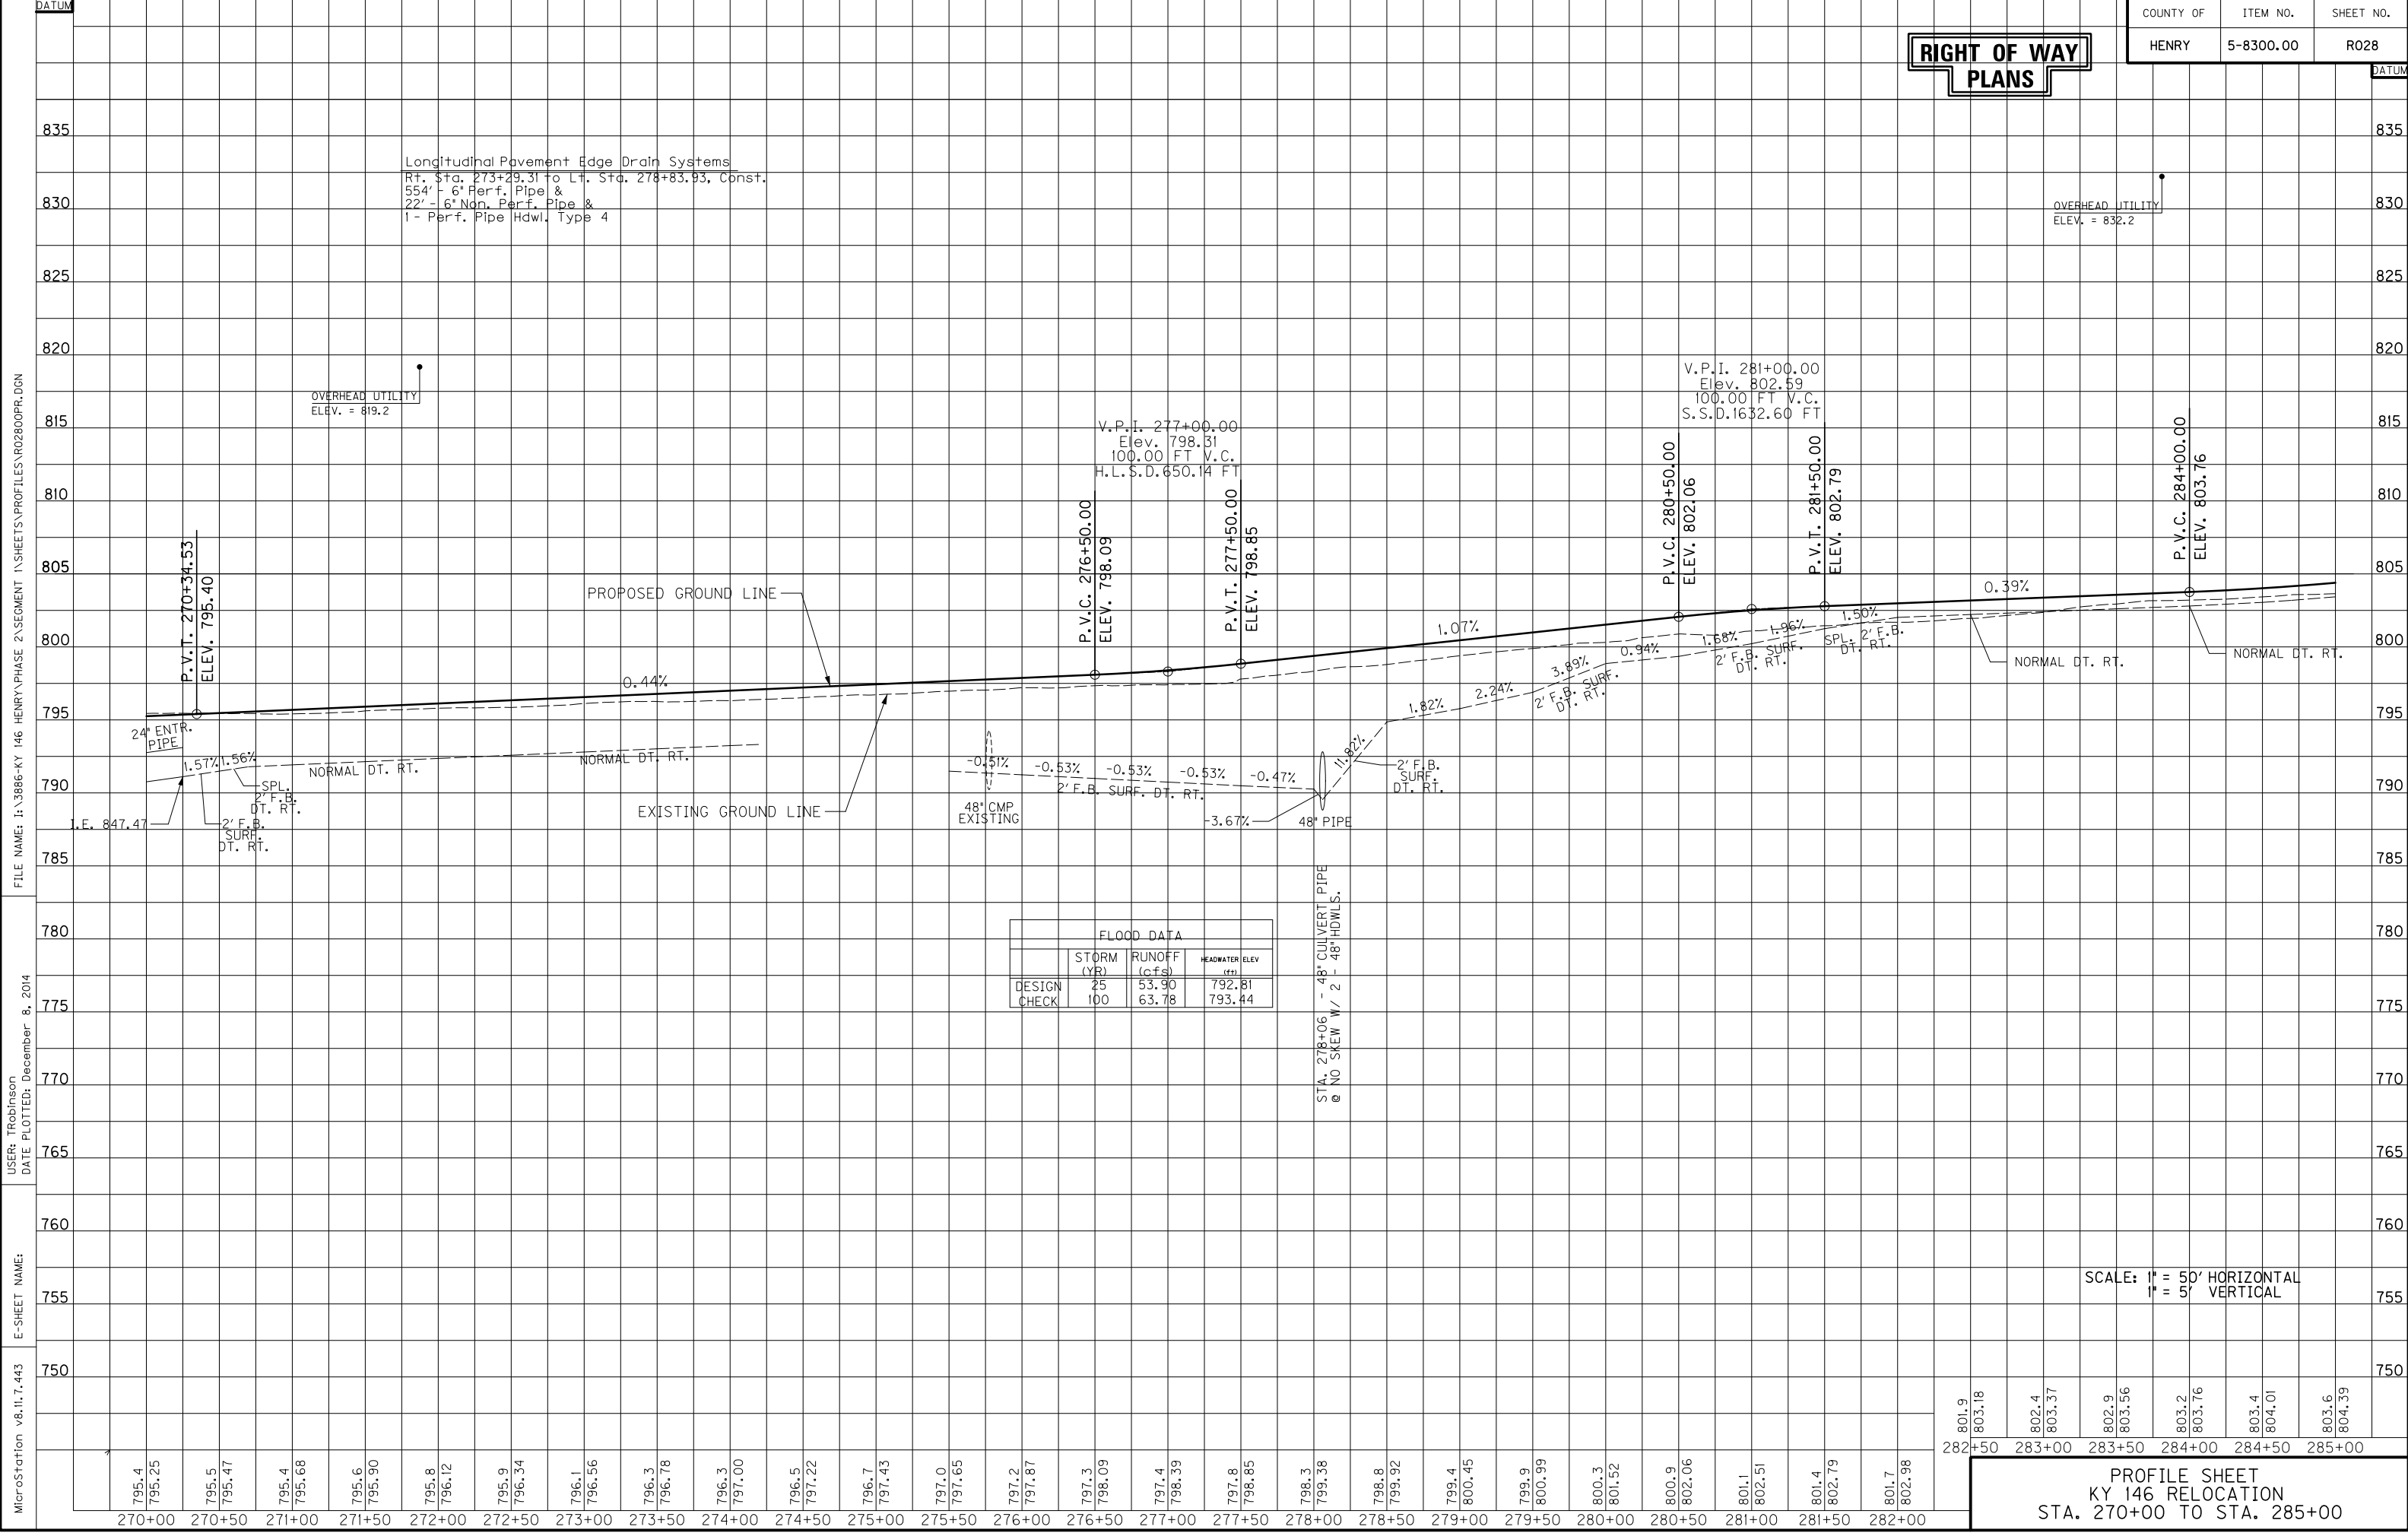

FLOOD DATA		
STORM (YR)	RUNOFF (cfs)	HEADWATER ELEV (ft)
DESIGN	25	53.90
CHECK	100	63.78
		792.81
		793.44

SCALE: 1" = 50' HORIZONTAL
 1" = 5' VERTICAL

PROFILE SHEET
 KY 146 RELOCATION
 STA. 270+00 TO STA. 285+00

MicroStation v8.11.7.443 E-SHEET NAME: DATE PLOTTED: December 8, 2014 USER: TRobinson FILE NAME: I:\3886-KY 146 HENRY\PHASE 2\SEGMENT 1\SHEETS\PROFILES\RO2800PR.DGN

795.4	795.25	795.5	795.47	795.4	795.68	795.6	795.90	795.8	796.12	795.9	796.34	796.1	796.56	796.3	796.78	796.3	797.00	796.5	797.22	796.7	797.43	797.0	797.65	797.2	797.87	797.3	798.09	797.4	798.39	797.8	798.85	798.3	799.38	798.8	799.92	799.4	800.45	799.9	800.99	800.3	801.52	800.9	802.06	801.1	802.51	801.4	802.79	801.7	802.98	801.9	803.18	802.4	803.37	802.9	803.56	803.2	803.76	803.4	804.01	803.6	804.39
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ENTRANCE CONSTRUCTION - LEFT									
STATION	ENTRANCE TYPE	ENTR. WIDTH (FT)	AREA (SQ YD)	CEM. CONC. ENT. PVMT. 8" (SQ. YDS.)	ASPHALT SURFACE (TONS)	ASPHALT BASE (TONS)	CSB (TONS)	ENTR. PIPE (FT)	HDWL
288+31	RESIDENTIAL	13.7	110	--	8	20	27	--	--


DITCH CONSTRUCTION - LEFT			
STATION	SIZE-SHAPE TYPE	LINING	
		TYPE	QUANTITY
290+48.01*	4' F.B. OUTLET	CL. II	50 TONS
292+86.62	2' F.B. OUTLET	CL. III	27 TONS

STEEL "W" BEAM GUARDRAIL
 LT. STA. 285+00 TO STA. 285+38.19,
 CONST. 1 END TREATMENT TYPE 4A

REMOVE GUARDRAIL
 LT. STA. 285+00 TO STA. 285+25.31,
 REMOVE 25 L.F.

DEPTH TO PROTECT = 3.5'

FILE NAME: I:\3886-KY 146 HENRY PHASE 2\SEGMENT 1\SENT\2014-12-12 ROW SET\PLAN\RO2900PL.DGN
 USER: TRobinson
 DATE PLOTTED: December 8, 2014
 E-SHEET NAME:
 MicroStation v8.11.7.443

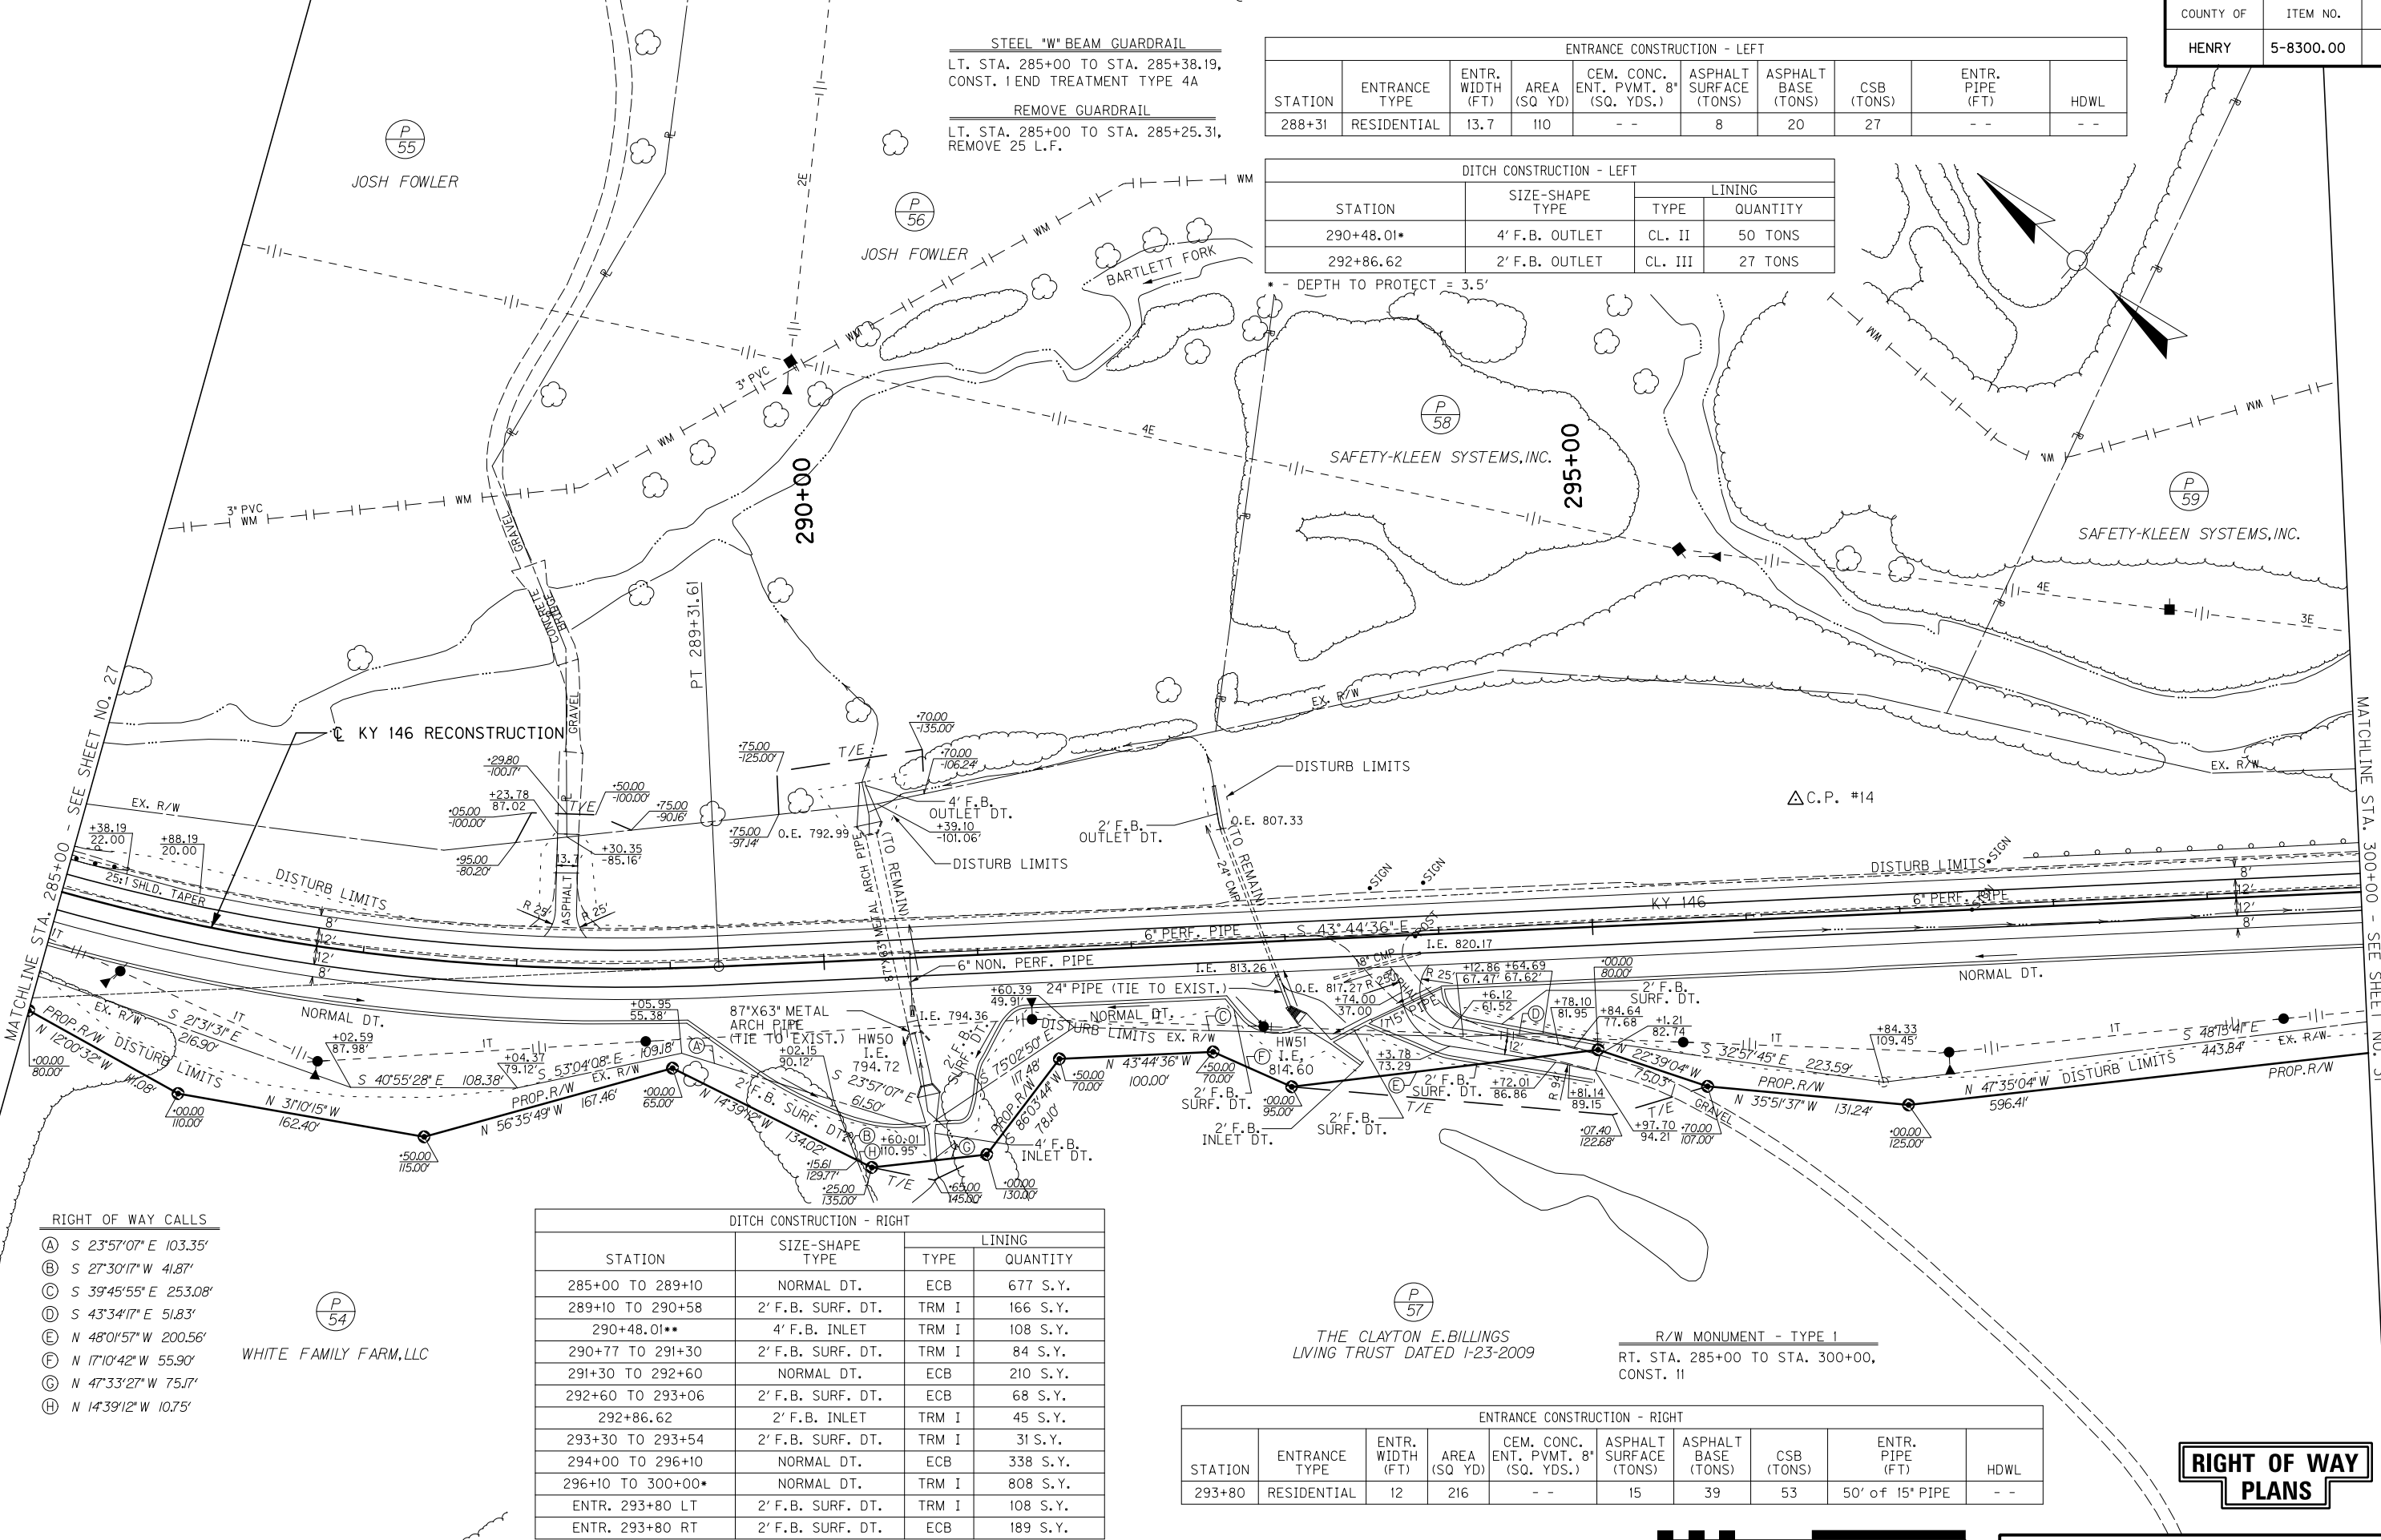

- RIGHT OF WAY CALLS**
- (A) S 23°57'07" E 103.35'
 - (B) S 27°30'17" W 41.87'
 - (C) S 39°45'55" E 253.08'
 - (D) S 43°34'17" E 51.83'
 - (E) N 48°01'57" W 200.56'
 - (F) N 17°10'42" W 55.90'
 - (G) N 47°33'27" W 75.17'
 - (H) N 14°39'12" W 10.75'

WHITE FAMILY FARM, LLC

DITCH CONSTRUCTION - RIGHT			
STATION	SIZE-SHAPE TYPE	LINING	
		TYPE	QUANTITY
285+00 TO 289+10	NORMAL DT.	ECB	677 S.Y.
289+10 TO 290+58	2' F.B. SURF. DT.	TRM I	166 S.Y.
290+48.01**	4' F.B. INLET	TRM I	108 S.Y.
290+77 TO 291+30	2' F.B. SURF. DT.	TRM I	84 S.Y.
291+30 TO 292+60	NORMAL DT.	ECB	210 S.Y.
292+60 TO 293+06	2' F.B. SURF. DT.	ECB	68 S.Y.
292+86.62	2' F.B. INLET	TRM I	45 S.Y.
293+30 TO 293+54	2' F.B. SURF. DT.	TRM I	31 S.Y.
294+00 TO 296+10	NORMAL DT.	ECB	338 S.Y.
296+10 TO 300+00*	NORMAL DT.	TRM I	808 S.Y.
ENTR. 293+80 LT	2' F.B. SURF. DT.	TRM I	108 S.Y.
ENTR. 293+80 RT	2' F.B. SURF. DT.	ECB	189 S.Y.

* - DEPTH TO PROTECT = 2.0'
 ** - DEPTH TO PROTECT = 3.0'

ENTRANCE CONSTRUCTION - RIGHT									
STATION	ENTRANCE TYPE	ENTR. WIDTH (FT)	AREA (SQ YD)	CEM. CONC. ENT. PVMT. 8" (SQ. YDS.)	ASPHALT SURFACE (TONS)	ASPHALT BASE (TONS)	CSB (TONS)	ENTR. PIPE (FT)	HDWL
293+80	RESIDENTIAL	12	216	--	15	39	53	50' of 15" PIPE	--



SCALE: 1"=50'


RIGHT OF WAY PLANS

PLAN SHEET
 KY 146 RELOCATION
 STA. 285+00 TO STA. 300+00

MicroStation v8.11.7.443 E-SHEET NAME: DATE PLOTTED: December 8, 2014 USER: TRobinson FILE NAME: I:\3886-KY 146 HENRY PHASE 2\SEGMENT 1\SHEETS\PROFILES\R03000PR.DGN

COUNTY OF	ITEM NO.	SHEET NO.
HENRY	5-8300.00	R030

**RIGHT OF WAY
PLANS**

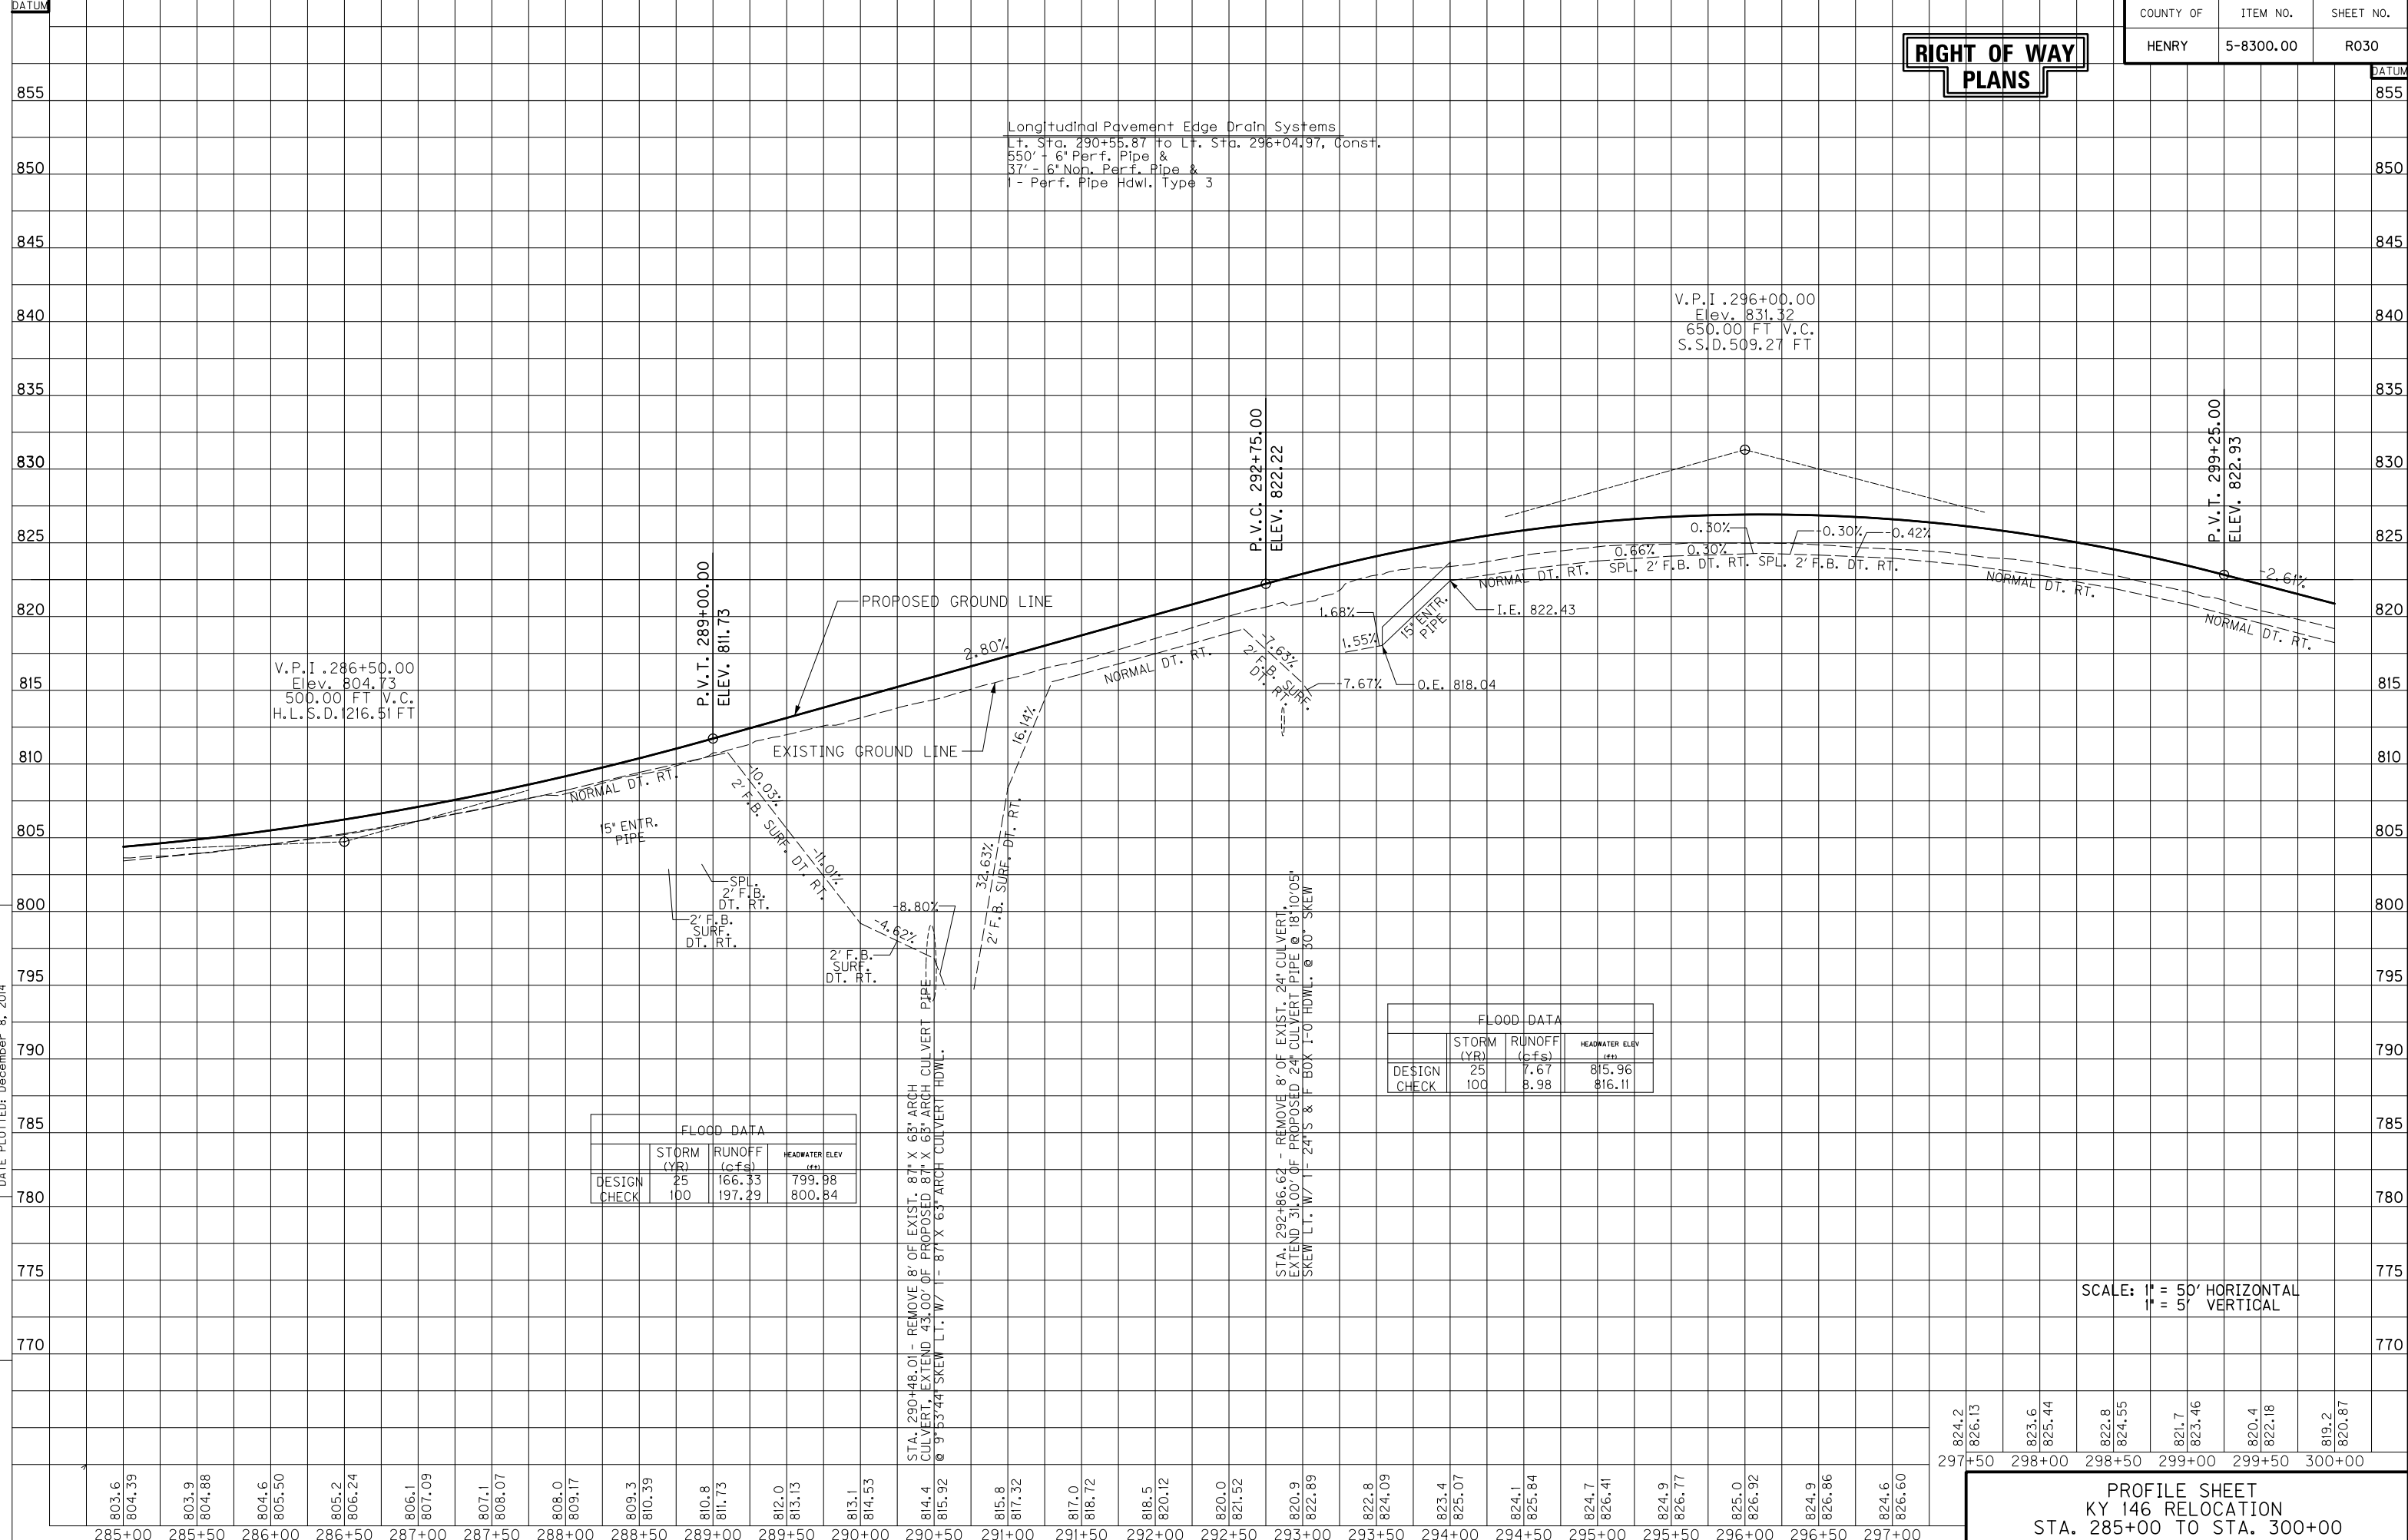

FLOOD DATA			
DESIGN	STORM (YR)	RUNOFF (cfs)	HEADWATER ELEV (ft)
DESIGN	25	166.33	799.98
CHECK	100	197.29	800.84

FLOOD DATA			
DESIGN	STORM (YR)	RUNOFF (cfs)	HEADWATER ELEV (ft)
DESIGN	25	7.67	815.96
CHECK	100	8.98	816.11

SCALE: 1" = 50' HORIZONTAL
1" = 5' VERTICAL

**PROFILE SHEET
KY 146 RELOCATION
STA. 285+00 TO STA. 300+00**

803.6	804.39	803.9	804.88	804.6	805.50	805.2	806.24	806.1	807.09	807.1	808.07	808.0	809.17	809.3	810.39	810.8	811.73	812.0	813.13	813.1	814.53	814.4	815.32	815.8	817.32	817.0	818.72	818.5	820.12	820.0	821.52	820.9	822.89	822.8	824.09	823.4	825.07	824.1	825.84	824.7	826.41	824.9	826.77	825.0	826.92	824.9	826.86	824.6	826.60	824.2	826.13	823.6	825.44	822.8	824.55	821.7	823.46	820.4	822.18	819.2	820.87
285+00	285+50	286+00	286+50	287+00	287+50	288+00	288+50	289+00	289+50	290+00	290+50	291+00	291+50	292+00	292+50	293+00	293+50	294+00	294+50	295+00	295+50	296+00	296+50	297+00	297+50	298+00	298+50	299+00	299+50	300+00																															

RIGHT OF WAY PLANS


P.I. STA. 303+35.48
 Delta = 8°19'47.46" RT.
 T = 207.54'
 L = 414.34'
 R = 2850.00'
 E = 7.55'
 e = 4.475%
 RUNOFF = 114.26'
 RUNOUT = 51.06'

ENTRANCE CONSTRUCTION - LEFT									
STATION	ENTRANCE TYPE	ENTR. WIDTH (FT)	AREA (SQ. YD)	CEM. CONC. ENT. PYMT. 8" (SQ. YDS.)	ASPHALT SURFACE (TONS)	ASPHALT BASE (TONS)	CSB (TONS)	ENTR. PIPE (FT)	HDWL
309+21	COMMERCIAL	39.65	233	233	--	--	55	--	--
309+81	COMMERCIAL	41.19	239	239	--	--	57	--	--

DITCH CONSTRUCTION - LEFT			
STATION	SIZE-SHAPE TYPE	LINING	
		TYPE	QUANTITY
306+06.30*	4' F.B. OUTLET	CL. III	93 TONS

REMOVE PAVEMENT
 LT. STA. 314+86.35 TO LT. STA 315+00
 REMOVE 4 SQ. YD. OF EXISTING PAVEMENT

* - DEPTH TO PROTECT = 1.5'

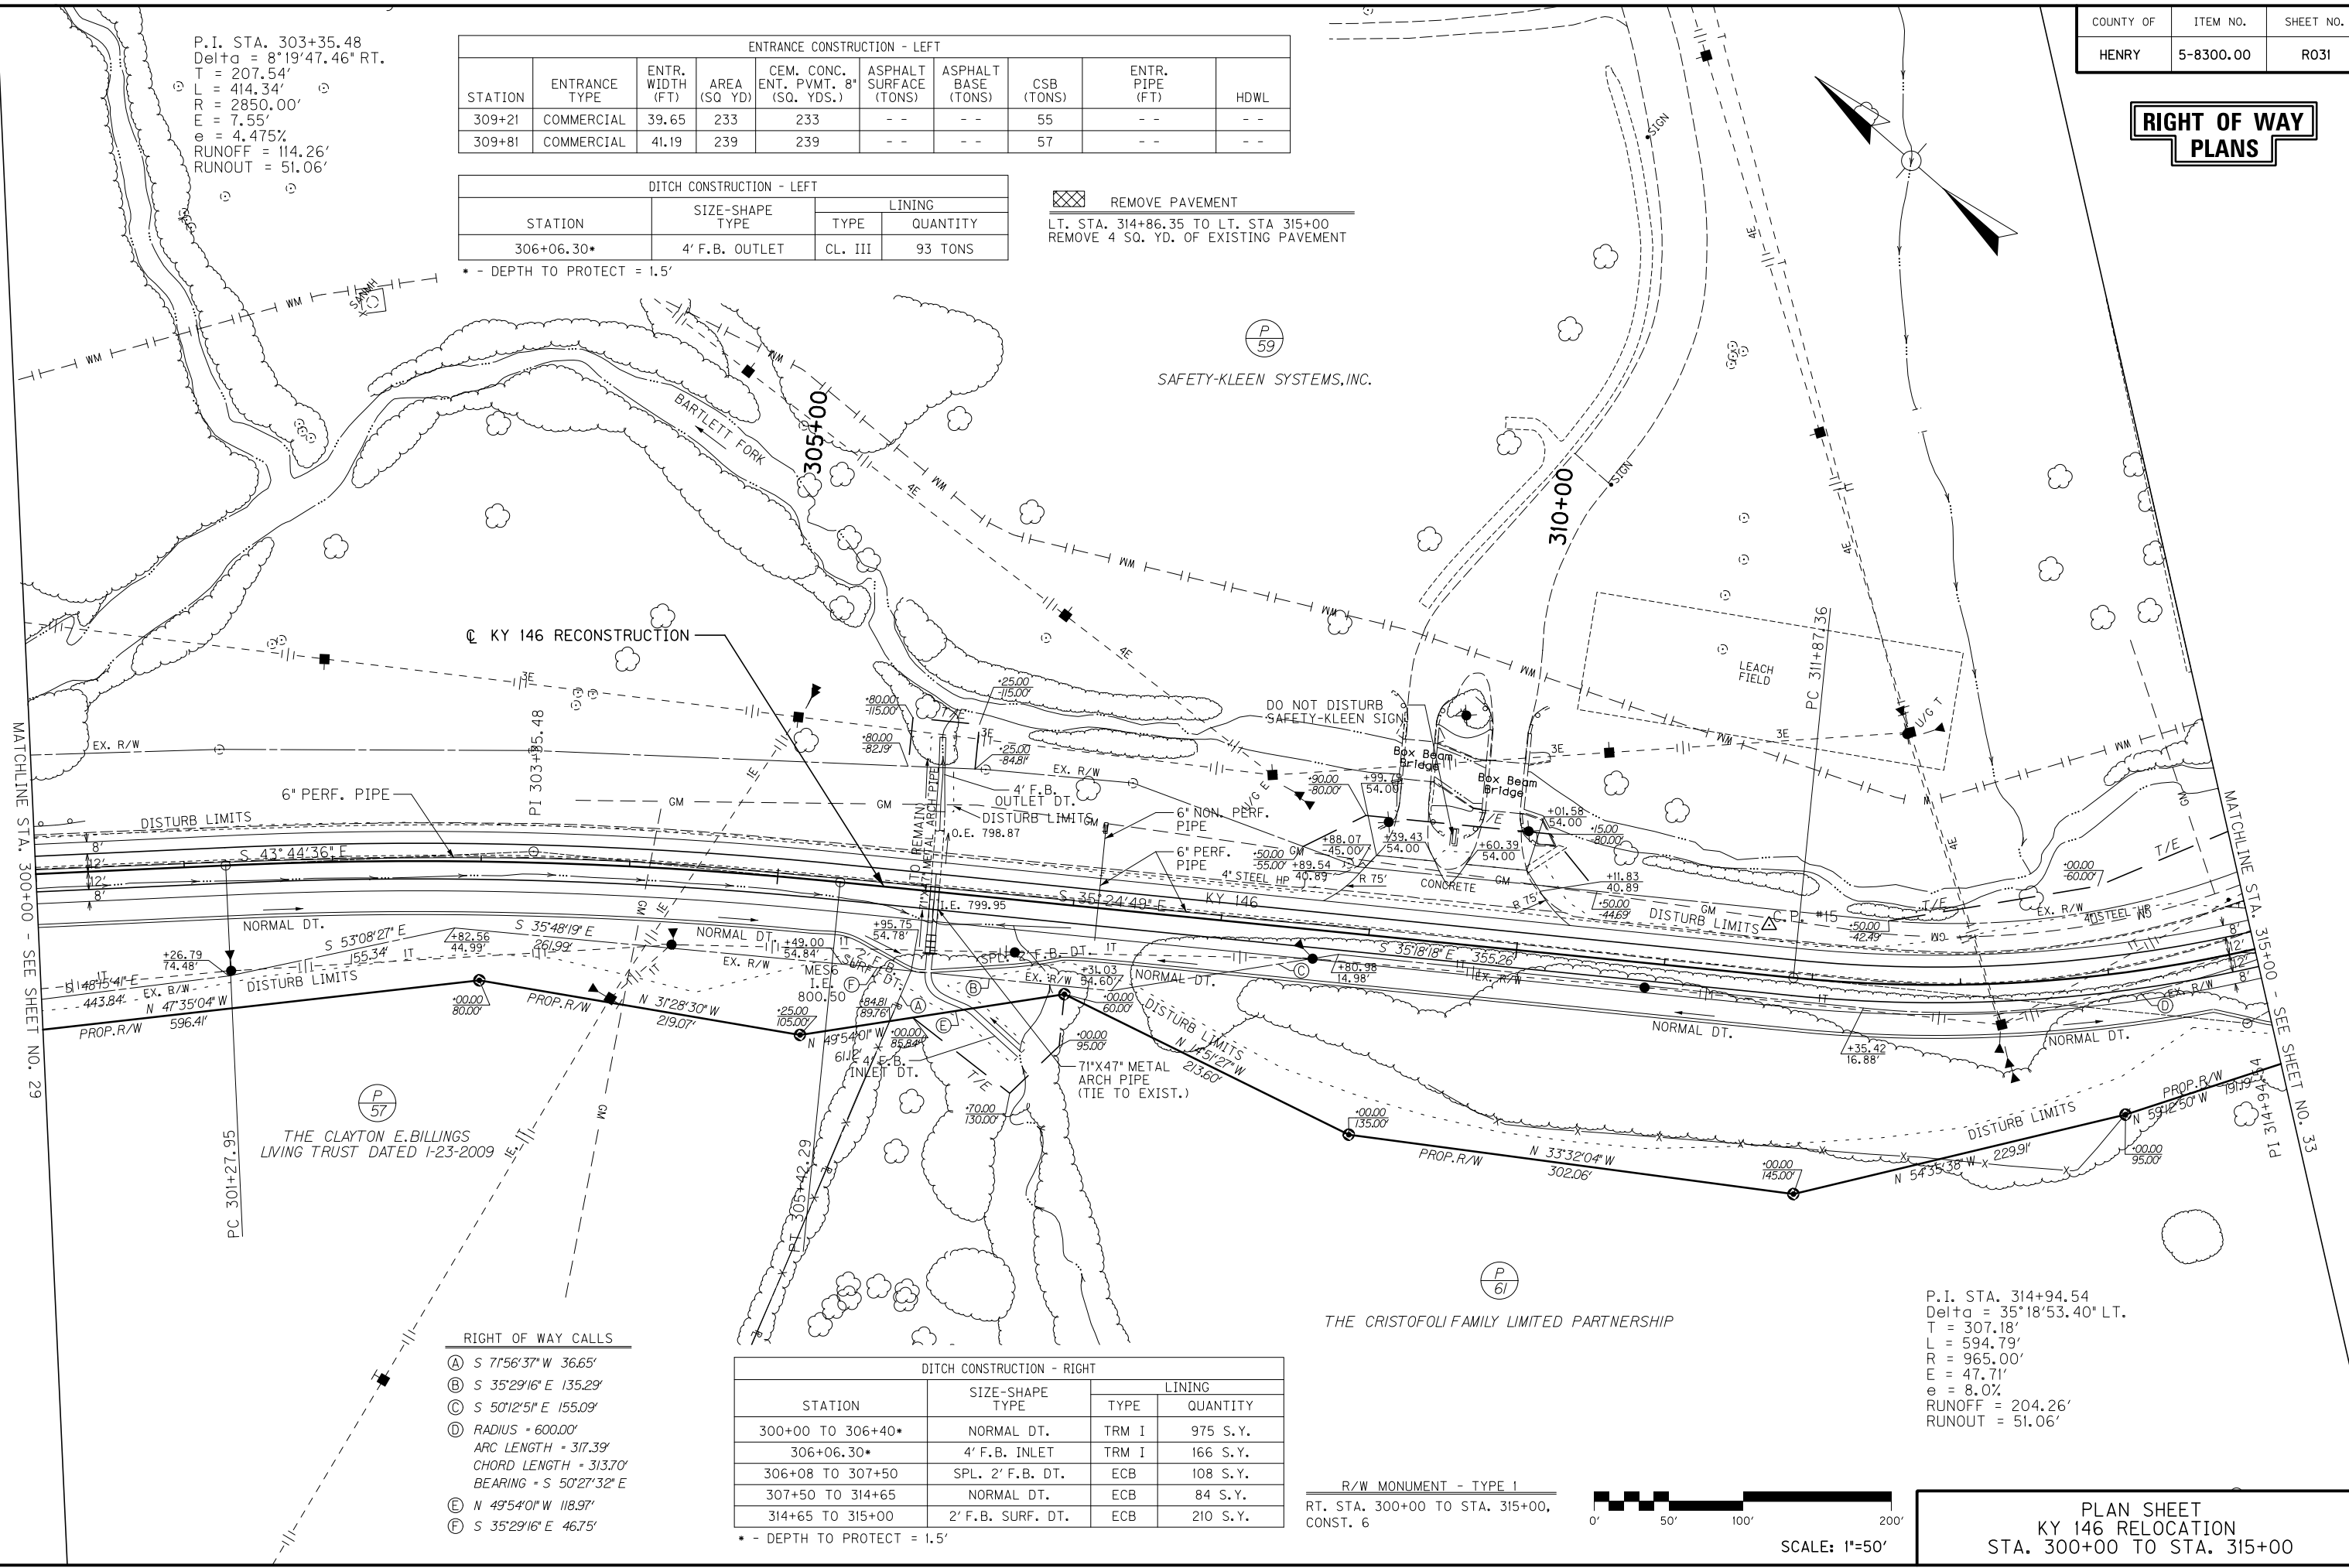

FILE NAME: I:\3886-KY 146 HENRY PHASE 2\SEGMENT 1\SENT\2014-12-12 ROW SET\PLAN\R03100PL.DGN
 USER: TRobinson
 DATE PLOTTED: December 8, 2014
 E-SHEET NAME:
 MicroStation v8.11.7.443

- RIGHT OF WAY CALLS**
- (A) S 71°56'37" W 36.65'
 - (B) S 35°29'16" E 135.29'
 - (C) S 50°12'51" E 155.09'
 - (D) RADIUS = 600.00'
 ARC LENGTH = 317.39'
 CHORD LENGTH = 313.70'
 BEARING = S 50°27'32" E
 - (E) N 49°54'01" W 118.97'
 - (F) S 35°29'16" E 46.75'

DITCH CONSTRUCTION - RIGHT			
STATION	SIZE-SHAPE TYPE	LINING	
		TYPE	QUANTITY
300+00 TO 306+40*	NORMAL DT.	TRM I	975 S.Y.
306+06.30*	4' F.B. INLET	TRM I	166 S.Y.
306+08 TO 307+50	SPL. 2' F.B. DT.	ECB	108 S.Y.
307+50 TO 314+65	NORMAL DT.	ECB	84 S.Y.
314+65 TO 315+00	2' F.B. SURF. DT.	ECB	210 S.Y.

R/W MONUMENT - TYPE 1
 RT. STA. 300+00 TO STA. 315+00,
 CONST. 6




P.I. STA. 314+94.54
 Delta = 35°18'53.40" LT.
 T = 307.18'
 L = 594.79'
 R = 965.00'
 E = 47.71'
 e = 8.0%
 RUNOFF = 204.26'
 RUNOUT = 51.06'

PLAN SHEET
 KY 146 RELOCATION
 STA. 300+00 TO STA. 315+00

**RIGHT OF WAY
PLANS**

MicroStation v8.11.7.443 E-SHEET NAME: USER: TRobinson DATE PLOTTED: December 8, 2014 FILE NAME: I:\3886-KY 146 HENRY\PHASE 2\SEGMENT 1\SHEETS\PROFILES\R03200PR.DGN

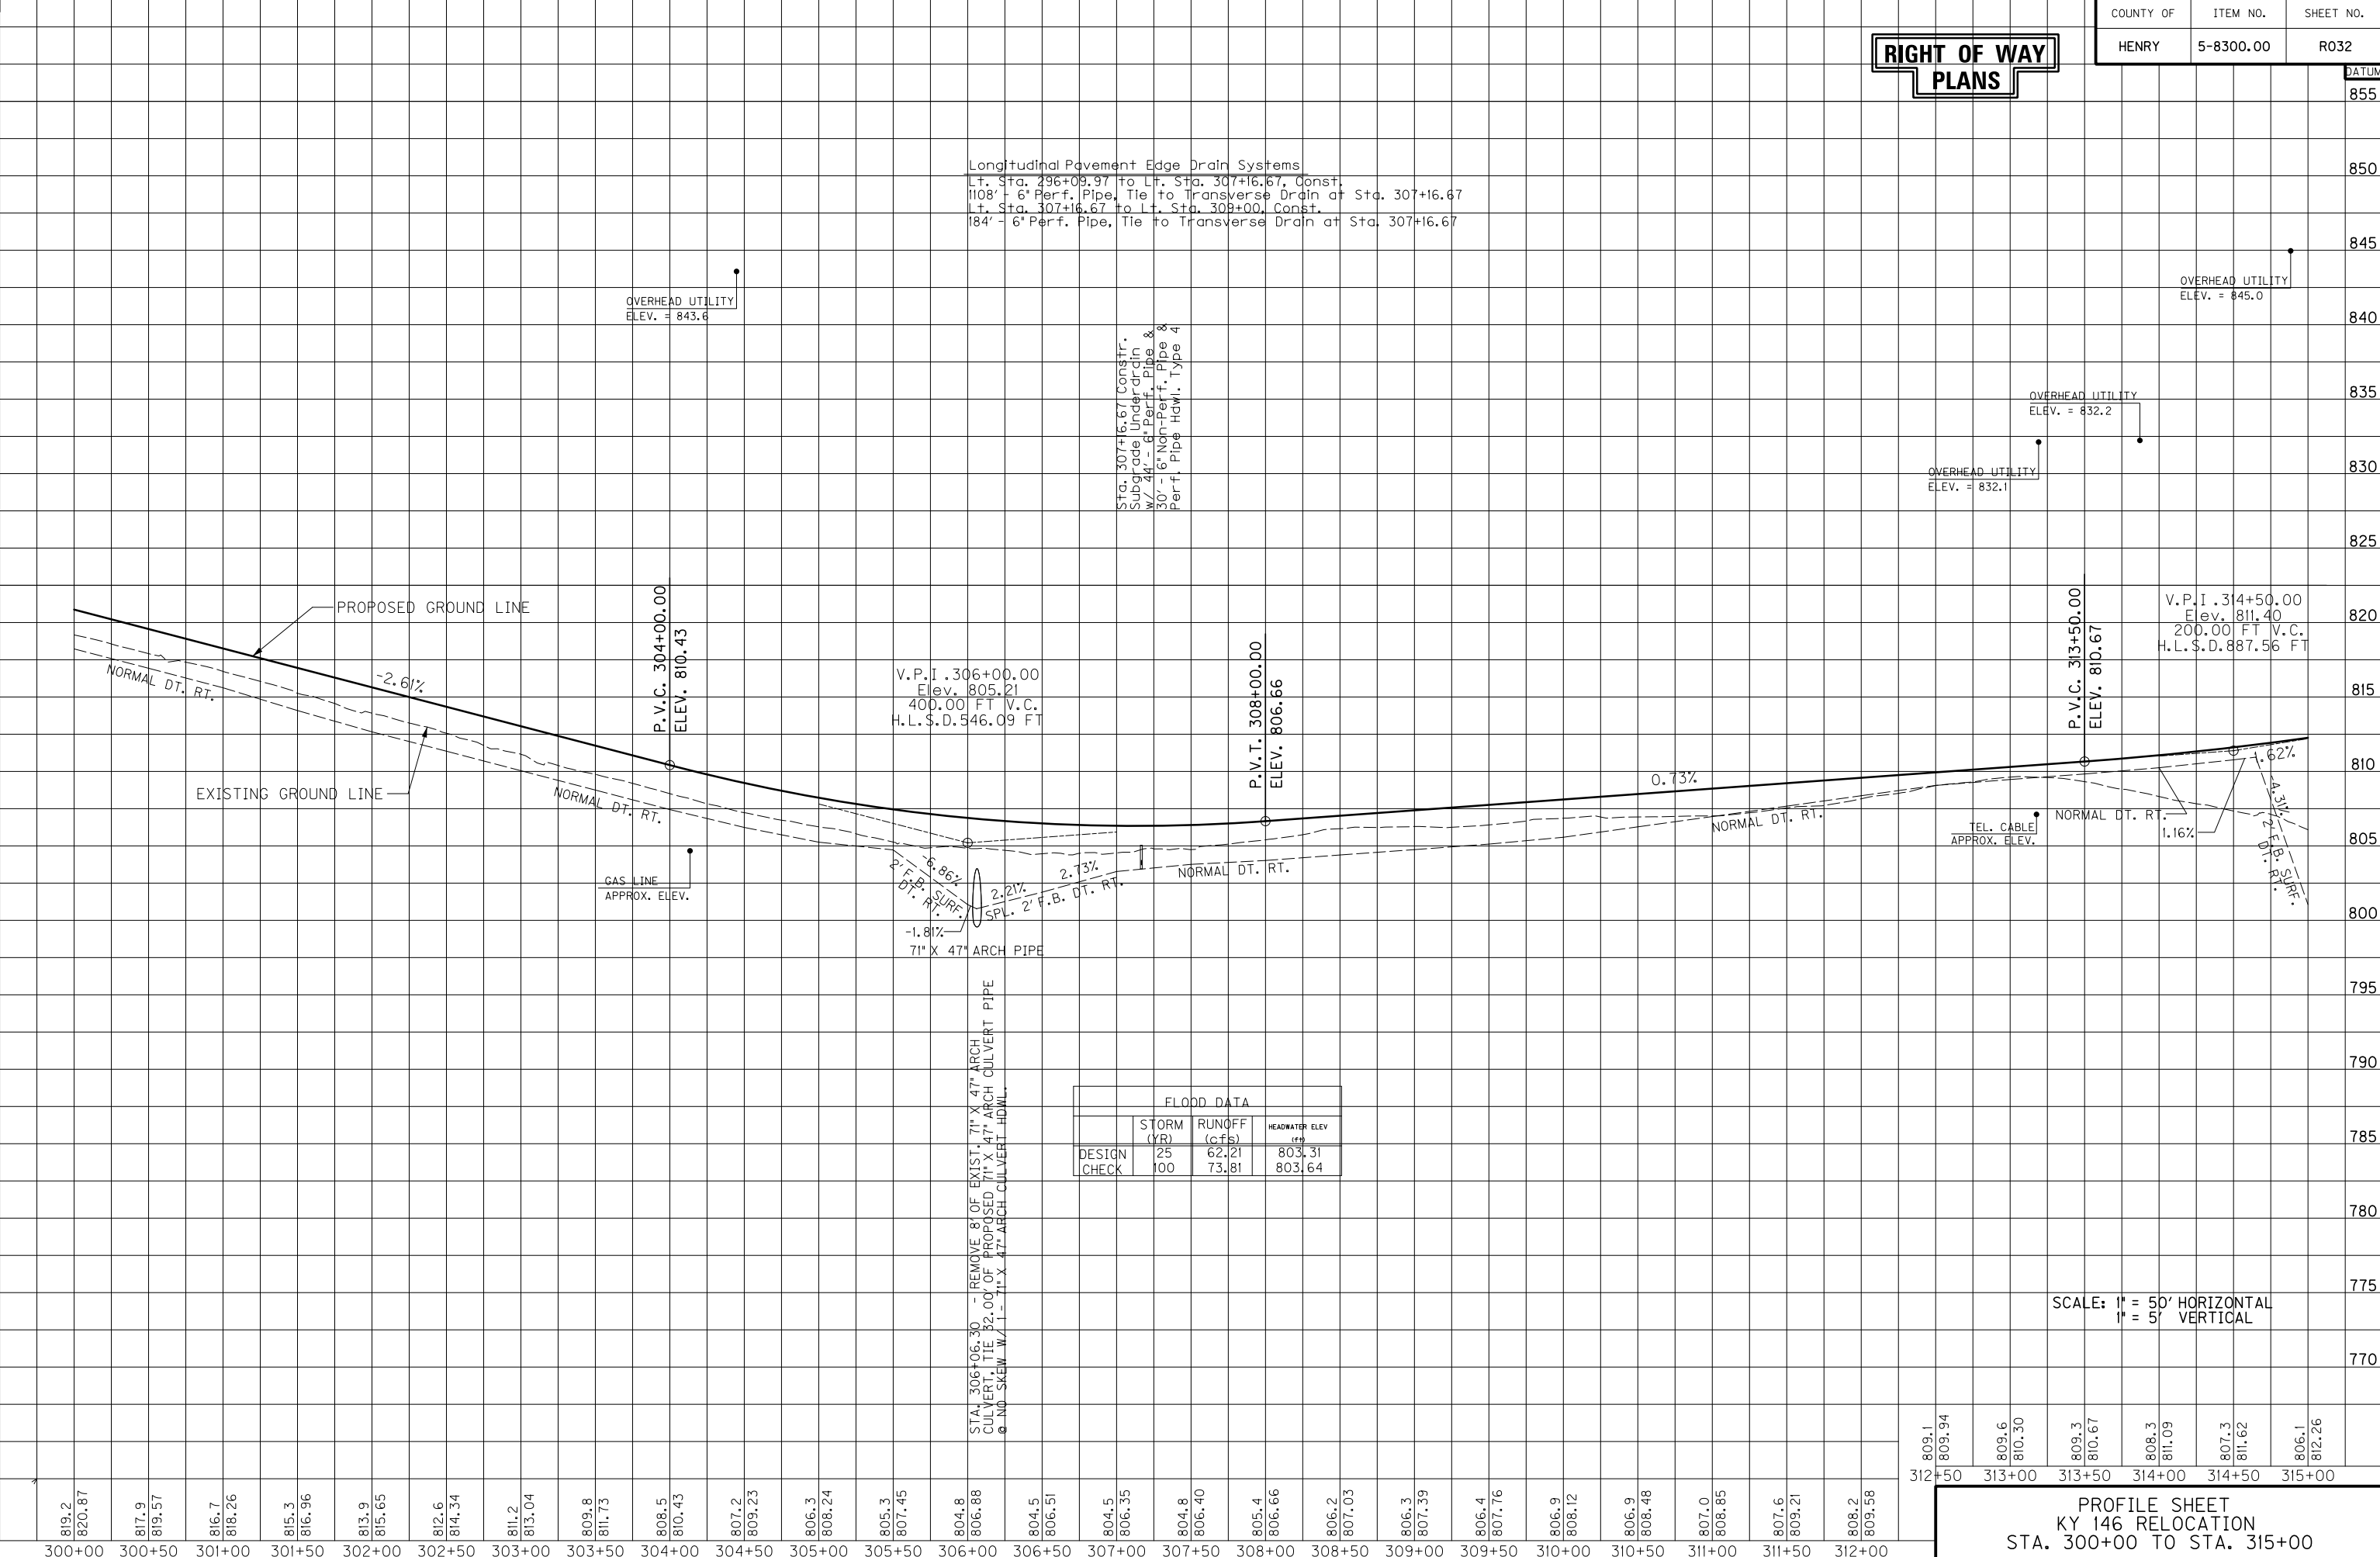

FLOOD DATA			
	STORM (YR)	RUNOFF (CFS)	HEADWATER ELEV (FT)
DESIGN	25	62.21	803.31
CHECK	100	73.81	803.64

STA. 306+06.30 - REMOVE 81' OF EXIST. 71' X 47' ARCH CULVERT, TIE 32.00' OF PROPOSED 71' X 47' ARCH CULVERT PIPE @ 1.00 SKEW W/ 1 - 71' X 47' ARCH CULVERT HDWL.

809.1 809.94
 809.6 810.30
 809.3 810.67
 808.3 811.09
 807.3 811.62
 806.1 812.26
 312+50 313+00 313+50 314+00 314+50 315+00

SCALE: 1" = 50' HORIZONTAL
 1" = 5' VERTICAL

**PROFILE SHEET
 KY 146 RELOCATION
 STA. 300+00 TO STA. 315+00**

**RIGHT OF WAY
PLANS**

DITCH CONSTRUCTION - LEFT

STATION	SIZE-SHAPE TYPE	LINING	
		TYPE	QUANTITY
315+11.68*	3' F.B. OUTLET	CL. III	27 TONS
321+80.65	2' F.B. OUTLET	CL. III	24 TONS
324+20 TO 325+00	2' F.B. SURF. DT.	CL. III	83 TONS
325+00	2' F.B. OUTLET	CL. III	40 TONS
325+00 TO 327+50	2' F.B. SURF. DT.	ECB	317 S.Y.
327+50 TO 330+00	SPL. 2' F.B. DT.	ECB	397 S.Y.

* - DEPTH TO PROTECT = 1.5'

REMOVE GUARDRAIL
 LT. STA. 316+64.01 TO STA. 323+61.84,
 REMOVE 693 L.F.
 LT. STA. 325+03.42 TO STA. 327+22.71,
 REMOVE 218 L.F.
 REMOVE PAVEMENT
 LT. STA. 315+00 TO LT. STA 315+09.36
 REMOVE 6 SQ. YD. OF EXISTING PAVEMENT
 LT. STA. 315+18.20 TO LT. STA 319+29.31
 REMOVE 578 SQ. YD. OF EXISTING PAVEMENT

STEEL "W" BEAM GUARDRAIL
 LT. STA. 320+66.46 TO STA. 323+54.67,
 CONST. 250.00 L.F. W/1 GUARDRAIL
 BRIDGE CONNECTOR TYPE A AND
 1 END TREATMENT TYPE 4A
 LT. STA. 324+96.73 TO STA. 327+75.00,
 CONST. 237.50 L.F. W/1 GUARDRAIL
 BRIDGE CONNECTOR TYPE A AND
 1 END TREATMENT TYPE 4A


R/W MONUMENT - TYPE 1
 LT. STA. 315+00 TO STA. 330+00,
 CONST. 2

ISLAND HEADER CURB TY 2
 LT. STA. 324+96.73 TO STA. 325+13.70,
 CONST. 17.00 L.F.

- RIGHT OF WAY CALLS**
- (A) RADIUS = 600.00'
 ARC LENGTH = 317.39'
 CHORD LENGTH = 313.70'
 BEARING = S 50°27'32" E
 - (B) S 65°36'47" E 135.51'
 - (C) S 35°41'56" E 99.34'
 - (D) N 59°12'50" W 191.9'
 - (E) N 34°32'00" W 29.73'

P.I. STA. 327+59.25
 Delta = 27°27'18.97" LT.
 T = 466.55'
 L = 915.18'
 R = 1909.86'
 E = 56.16'
 e = 6.02%
 RUNOFF = 137.87'
 RUNOUT = 51.06'
 SUPERELEVATION AT 5.3% FROM STA. 323+25.54 TO 325+40

FILE NAME: I:\3886-KY 146 HENRY PHASE 2\SEGMENT 1\SENT\2014-12-12 ROW SET\PLAN\R033O0PL.DGN
 USER: TROBINSON
 DATE PLOTTED: December 8, 2014
 E-SHEET NAME: MicroStation v8.11.7.443

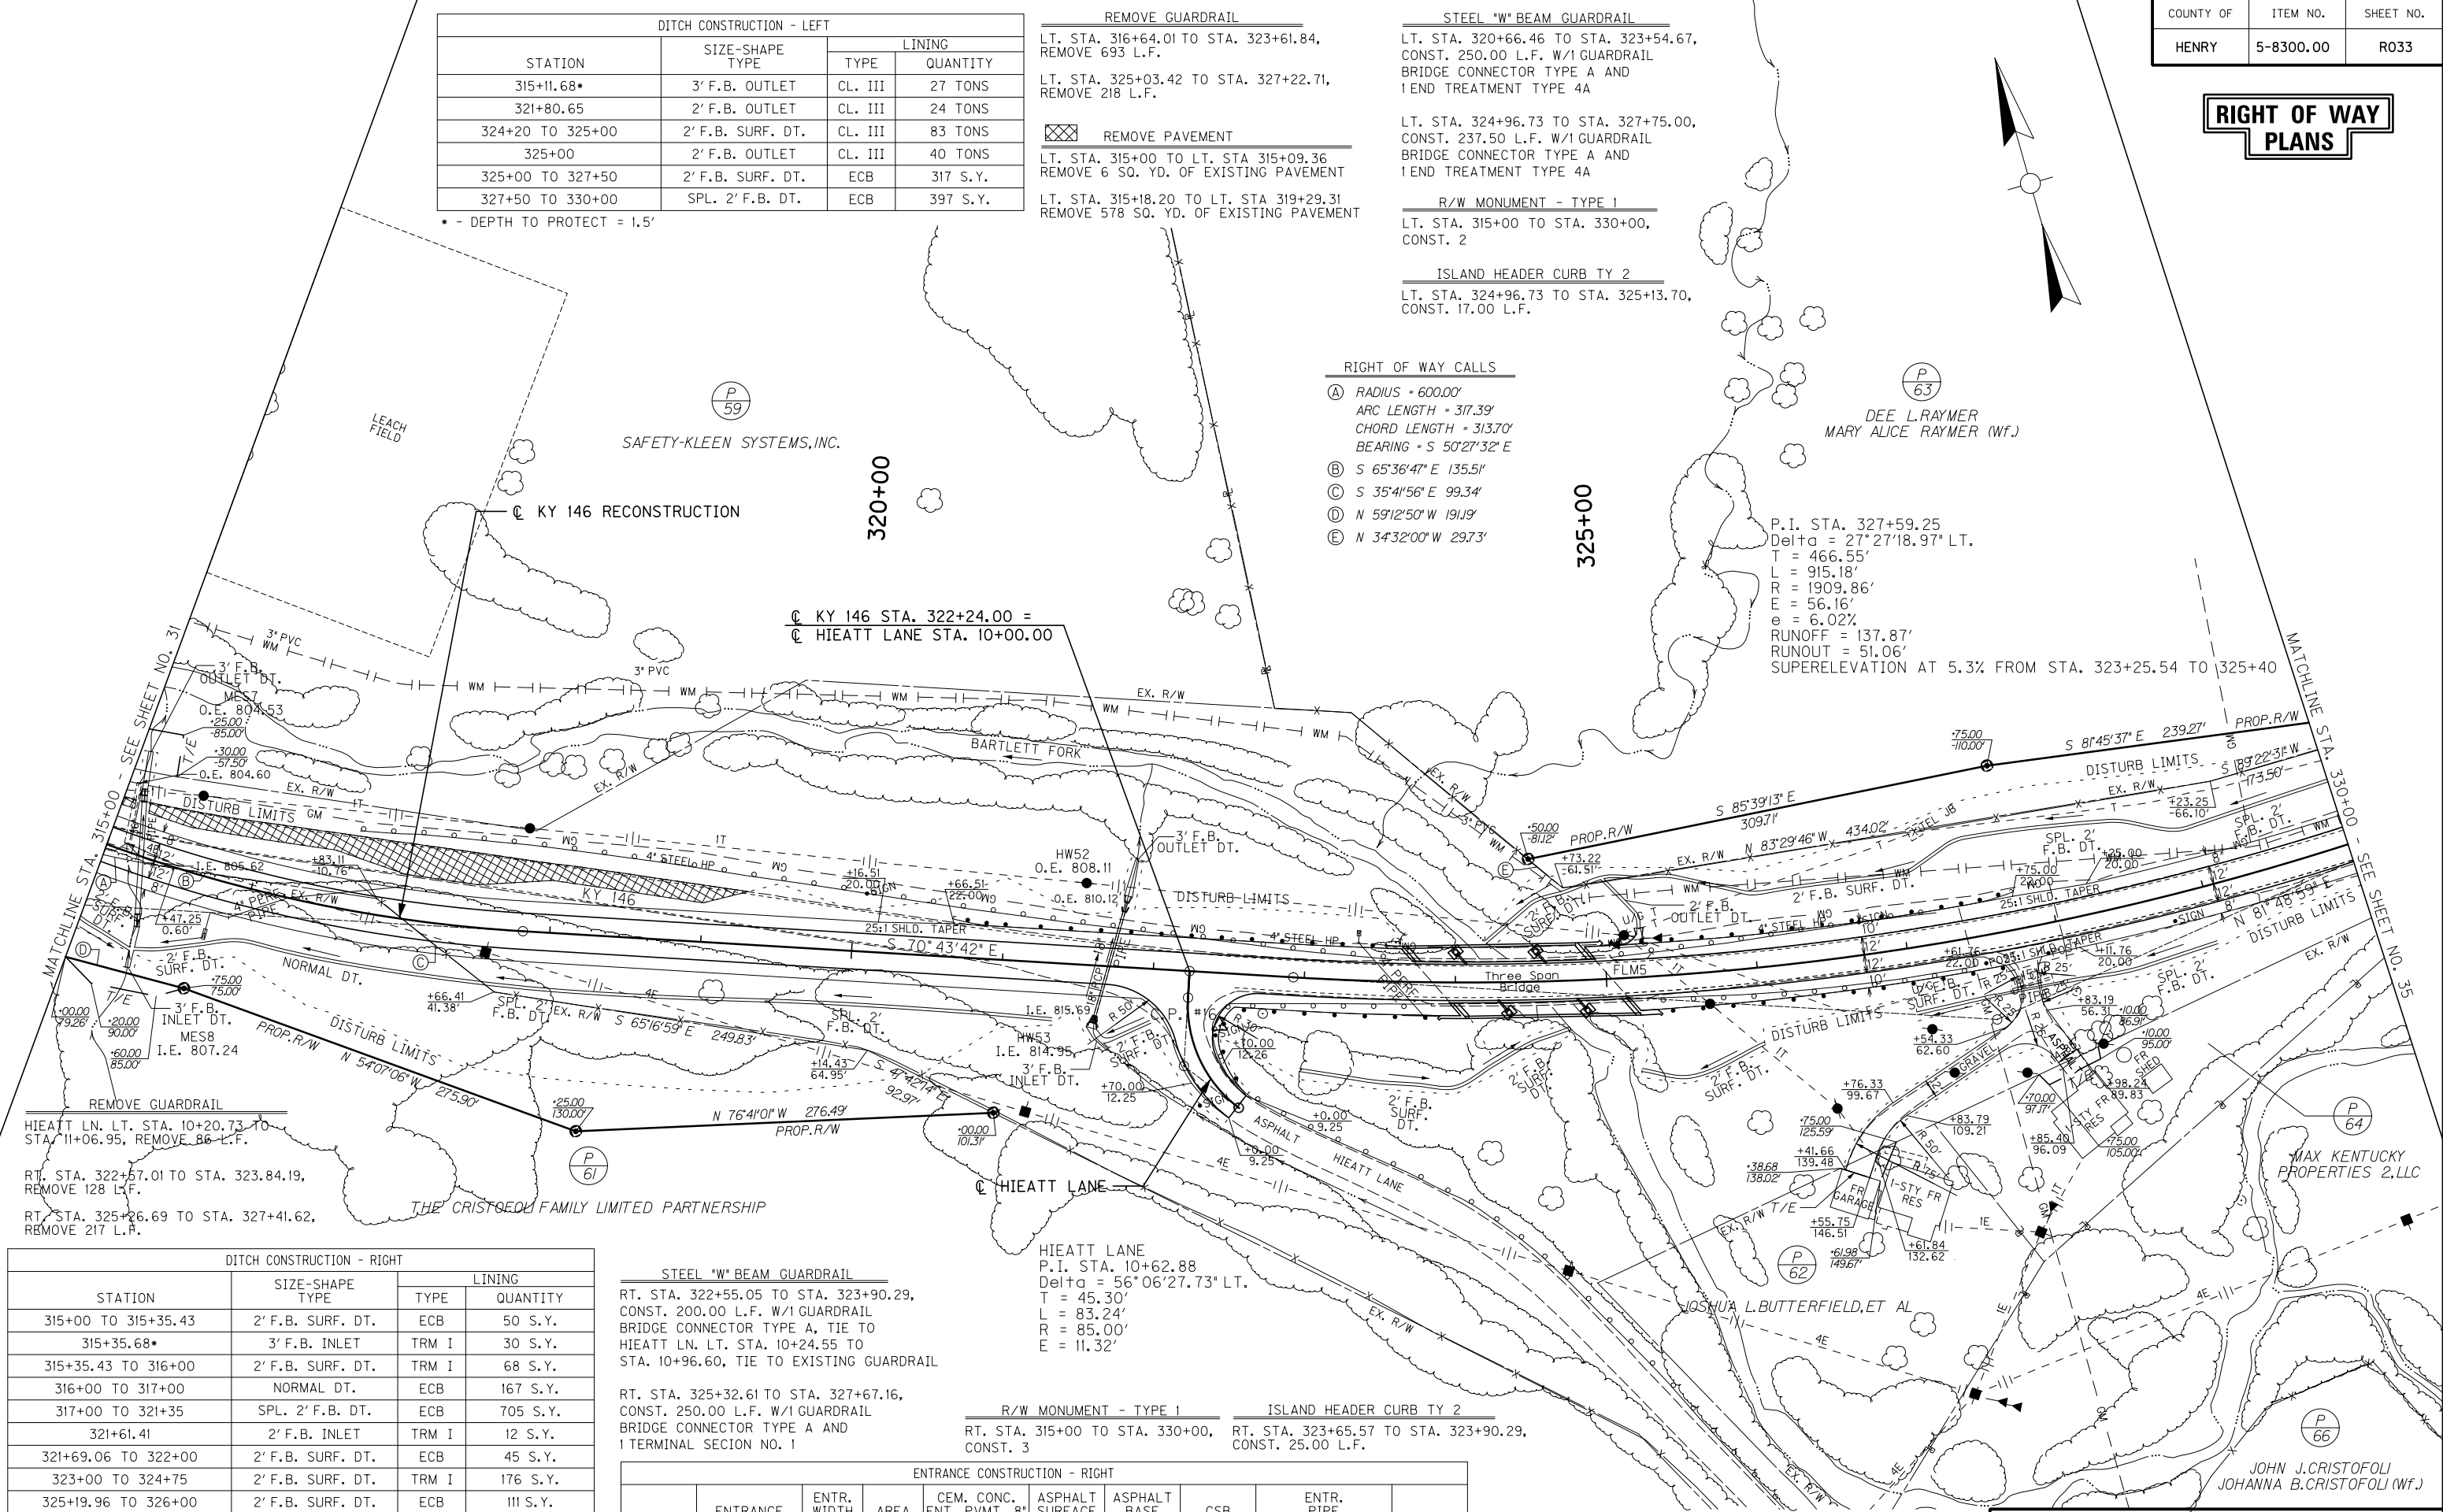

DITCH CONSTRUCTION - RIGHT

STATION	SIZE-SHAPE TYPE	TYPE	QUANTITY
315+00 TO 315+35.43	2' F.B. SURF. DT.	ECB	50 S.Y.
315+35.68*	3' F.B. INLET	TRM I	30 S.Y.
315+35.43 TO 316+00	2' F.B. SURF. DT.	TRM I	68 S.Y.
316+00 TO 317+00	NORMAL DT.	ECB	167 S.Y.
317+00 TO 321+35	SPL. 2' F.B. DT.	ECB	705 S.Y.
321+61.41	2' F.B. INLET	TRM I	12 S.Y.
321+69.06 TO 322+00	2' F.B. SURF. DT.	ECB	45 S.Y.
323+00 TO 324+75	2' F.B. SURF. DT.	TRM I	176 S.Y.
325+19.96 TO 326+00	2' F.B. SURF. DT.	ECB	111 S.Y.
327+00 TO 327+51.92	2' F.B. SURF. DT.	ECB	68 S.Y.
327+96.96 TO 329+00	SPL. 2' F.B. DT.	ECB	170 S.Y.

* - DEPTH TO PROTECT = 1.5'

STEEL "W" BEAM GUARDRAIL
 RT. STA. 322+55.05 TO STA. 323+90.29,
 CONST. 200.00 L.F. W/1 GUARDRAIL
 BRIDGE CONNECTOR TYPE A, TIE TO
 HIEATT LN. LT. STA. 10+24.55 TO
 STA. 10+96.60, TIE TO EXISTING GUARDRAIL

RT. STA. 325+32.61 TO STA. 327+67.16,
 CONST. 250.00 L.F. W/1 GUARDRAIL
 BRIDGE CONNECTOR TYPE A AND
 1 TERMINAL SECTION NO. 1


R/W MONUMENT - TYPE 1
 RT. STA. 315+00 TO STA. 330+00,
 CONST. 3

ISLAND HEADER CURB TY 2
 RT. STA. 323+65.57 TO STA. 323+90.29,
 CONST. 25.00 L.F.

ENTRANCE CONSTRUCTION - RIGHT

STATION	ENTRANCE TYPE	ENTR. WIDTH (FT)	AREA (SQ YD)	CEM. CONC. ENT. PVMT. 8" (SQ. YDS.)	ASPHALT SURFACE (TONS)	ASPHALT BASE (TONS)	CSB (TONS)	ENTR. PIPE (FT)	HDWL
327+75	RESIDENTIAL	12	364	--	25	66	88	46' of 15" PIPE	--


**RIGHT OF WAY
PLANS**

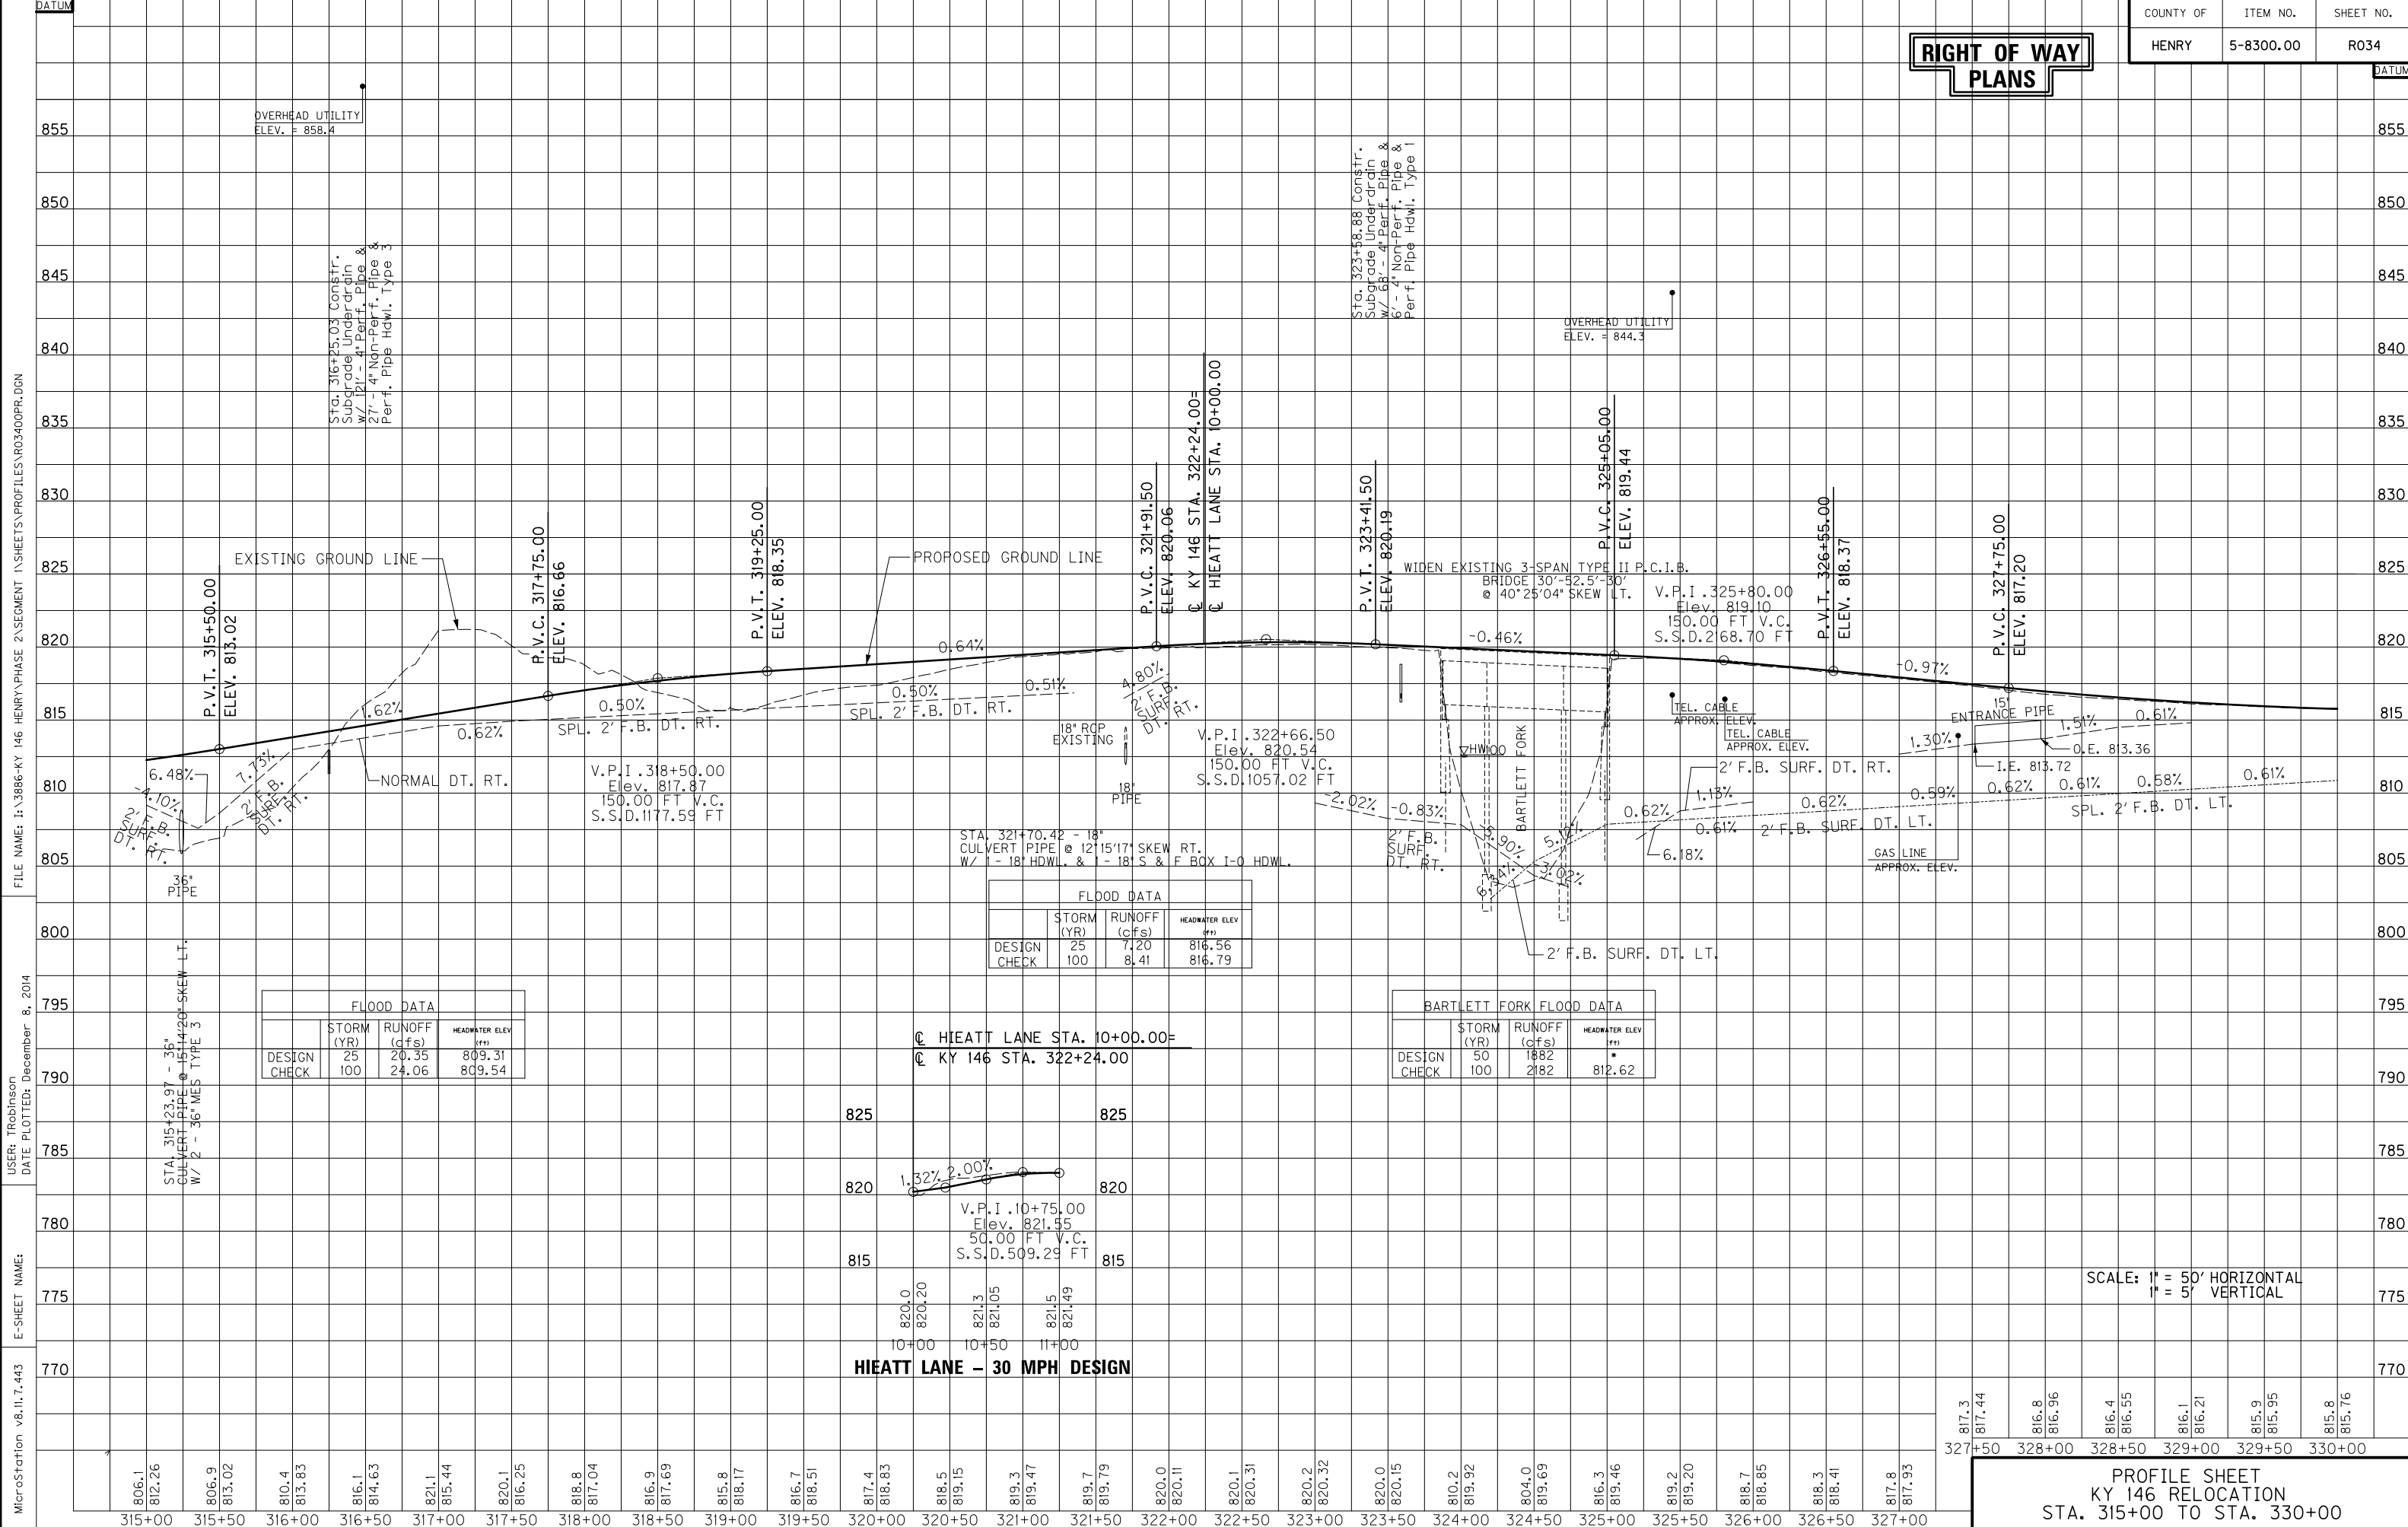

FLOOD DATA			
DESIGN CHECK	STORM (YR)	RUNOFF (cfs)	HEADWATER ELEV (ft)
	25	20.35	809.31
	100	24.06	809.54

FLOOD DATA			
DESIGN CHECK	STORM (YR)	RUNOFF (cfs)	HEADWATER ELEV (ft)
	25	7.20	816.56
	100	8.41	816.79

BARTLETT FORK FLOOD DATA			
DESIGN CHECK	STORM (YR)	RUNOFF (cfs)	HEADWATER ELEV (ft)
	50	1882	812.62
	100	2182	812.62

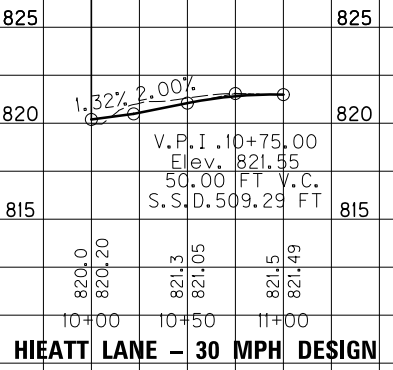

SCALE: 1" = 50' HORIZONTAL
1" = 5' VERTICAL

**PROFILE SHEET
KY 146 RELOCATION
STA. 315+00 TO STA. 330+00**

MicroStation v8.11.7.443 E-SHEET NAME: USER: TRobinson DATE PLOTTED: December 8, 2014 FILE NAME: I:\3886-KY 146 HENRY PHASE 2\SEGMENT 1\SHEETS\PROFILES\R03400PR.DGN

FILE NAME: I:\3886-KY 146 HENRY PHASE 2 SEGMENT 1\SENT\2014-12-12 ROW SET\PLAN\RO35OPL.DGN
 USER: TRobinson
 DATE PLOTTED: December 8, 2014
 E-SHEET NAME:
 MicroStation v8.11.7.443

COUNTY OF	ITEM NO.	SHEET NO.
HENRY	5-8300.00	RO35

RIGHT OF WAY PLANS

- RIGHT OF WAY CALLS**
- Ⓐ S 81°45'37" E 239.27'
 - Ⓑ N 88°45'26" E 193.49'
 - Ⓒ RADIUS = 5437.35'
ARC LENGTH = 338.83'
CHORD LENGTH = 338.77'
BEARING = N 83°05'10" W
 - Ⓓ RADIUS = 1537.15'
ARC LENGTH = 342.37'
CHORD LENGTH = 341.66'
BEARING = S 87°40'12" W
 - Ⓔ S 90°00'00" W 236.10'
 - Ⓕ N 80°35'53" E 32.25'
 - Ⓖ S 64°04'56" W 14.97'
 - Ⓗ N 86°01'31" W 18.39'
 - Ⓜ RADIUS = 1477.15'
ARC LENGTH = 265.91'
CHORD LENGTH = 265.55'
BEARING = N 85°10'20" E
 - Ⓝ S 18°16'19" E 11.82'
 - Ⓚ N 86°01'31" W 80.45'

R/W MONUMENT - TYPE 1
 LT. STA. 330+00 TO STA. 345+00,
 CONST. 5

ENTRANCE CONSTRUCTION - LEFT

STATION	ENTRANCE TYPE	ENTR. WIDTH (FT)	AREA (SQ YD)	CEM. CONC. ENT. PVMT. 8" (SQ. YDS.)	ASPHALT SURFACE (TONS)	ASPHALT BASE (TONS)	CSB (TONS)	ENTR. PIPE (FT)	HDWL
331+75	RESIDENTIAL	12	94	--	6	17	23	46' of 15" PIPE	--

DITCH CONSTRUCTION - LEFT

STATION	SIZE-SHAPE TYPE	LINING	
		TYPE	QUANTITY
330+00 TO 331+48.05	SPL. 2' F.B. DT.	ECB	234 S.Y.
331+95.07 TO 332+50	SPL. 2' F.B. DT.	ECB	90 S.Y.
332+50 TO 333+00	NORMAL DT.	ECB	81 S.Y.
333+00 TO 333+50	SPL. 2' F.B. DT.	ECB	162 S.Y.
331+75 ENTR. LT.	SPL. 2' F.B. DT.	TRM I	56 S.Y.
331+75 ENTR. RT.	SPL. 2' F.B. DT.	TRM I	54 S.Y.


P.I. STA. 337+36.71
 Delta = 15°59'14.19" RT.
 T = 207.83'
 L = 412.97'
 R = 1480.00'
 E = 14.52'
 e = 7.0%
 RUNOFF = 178.72'
 RUNOUT = 51.06'

335+00

340+00

END CONSTRUCTION STA. 333+50.00
 SEGMENT NO. 1

END RIGHT OF WAY STA. 341+15.41
 SEGMENT NO. 1

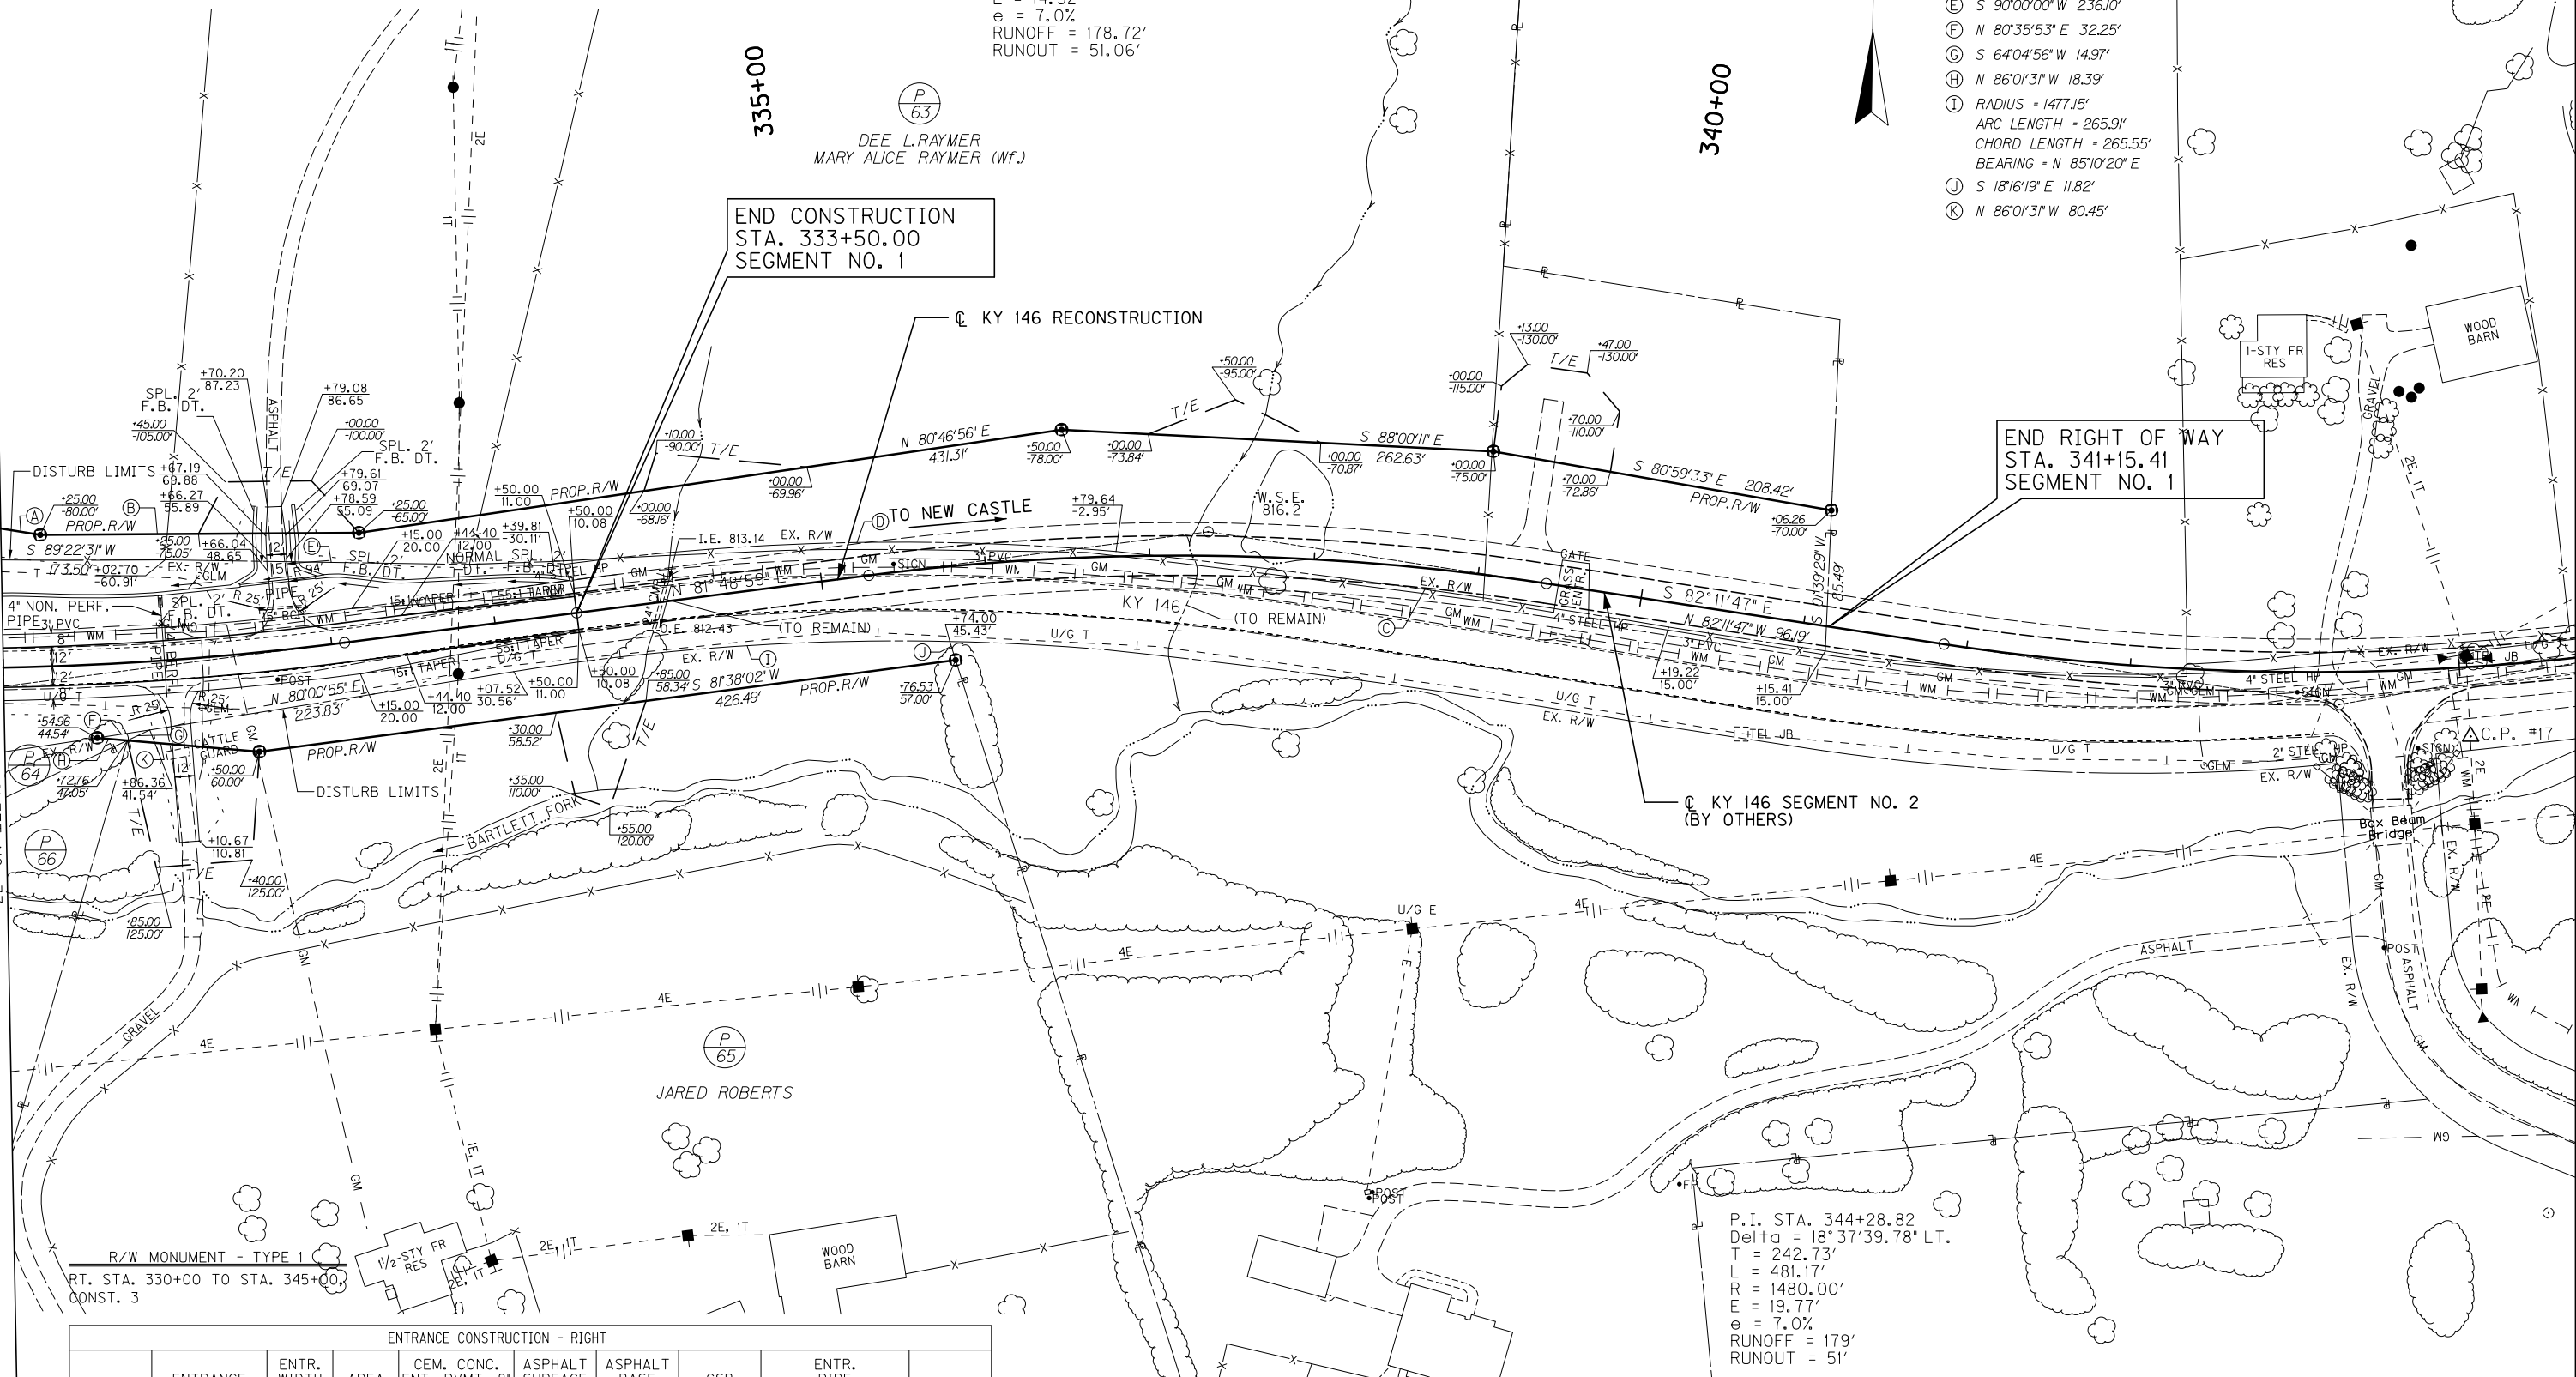

P.I. STA. 344+28.82
 Delta = 18°37'39.78" LT.
 T = 242.73'
 L = 481.17'
 R = 1480.00'
 E = 19.77'
 e = 7.0%
 RUNOFF = 179'
 RUNOUT = 51'



ENTRANCE CONSTRUCTION - RIGHT


STATION	ENTRANCE TYPE	ENTR. WIDTH (FT)	AREA (SQ YD)	CEM. CONC. ENT. PVMT. 8" (SQ. YDS.)	ASPHALT SURFACE (TONS)	ASPHALT BASE (TONS)	CSB (TONS)	ENTR. PIPE (FT)	HDWL
331+05	RESIDENTIAL	12	129	--	9	23	31	--	--

PLAN SHEET
 KY 146 RELOCATION
 STA. 330+00 TO STA. 333+50
 SCALE: 1"=50'

MicroStation v8.1i.7.443 E-SHEET NAME: USER: TRobinson DATE PLOTTED: December 8, 2014 FILE NAME: I:\3886-KY 146 HENRY-PHASE 2 SEGMENT 1\ SHEETS\PROFILES\PROF03600PR.DGN

COUNTY OF	ITEM NO.	SHEET NO.
HENRY	5-8300.00	R036

**RIGHT OF WAY
PLANS**

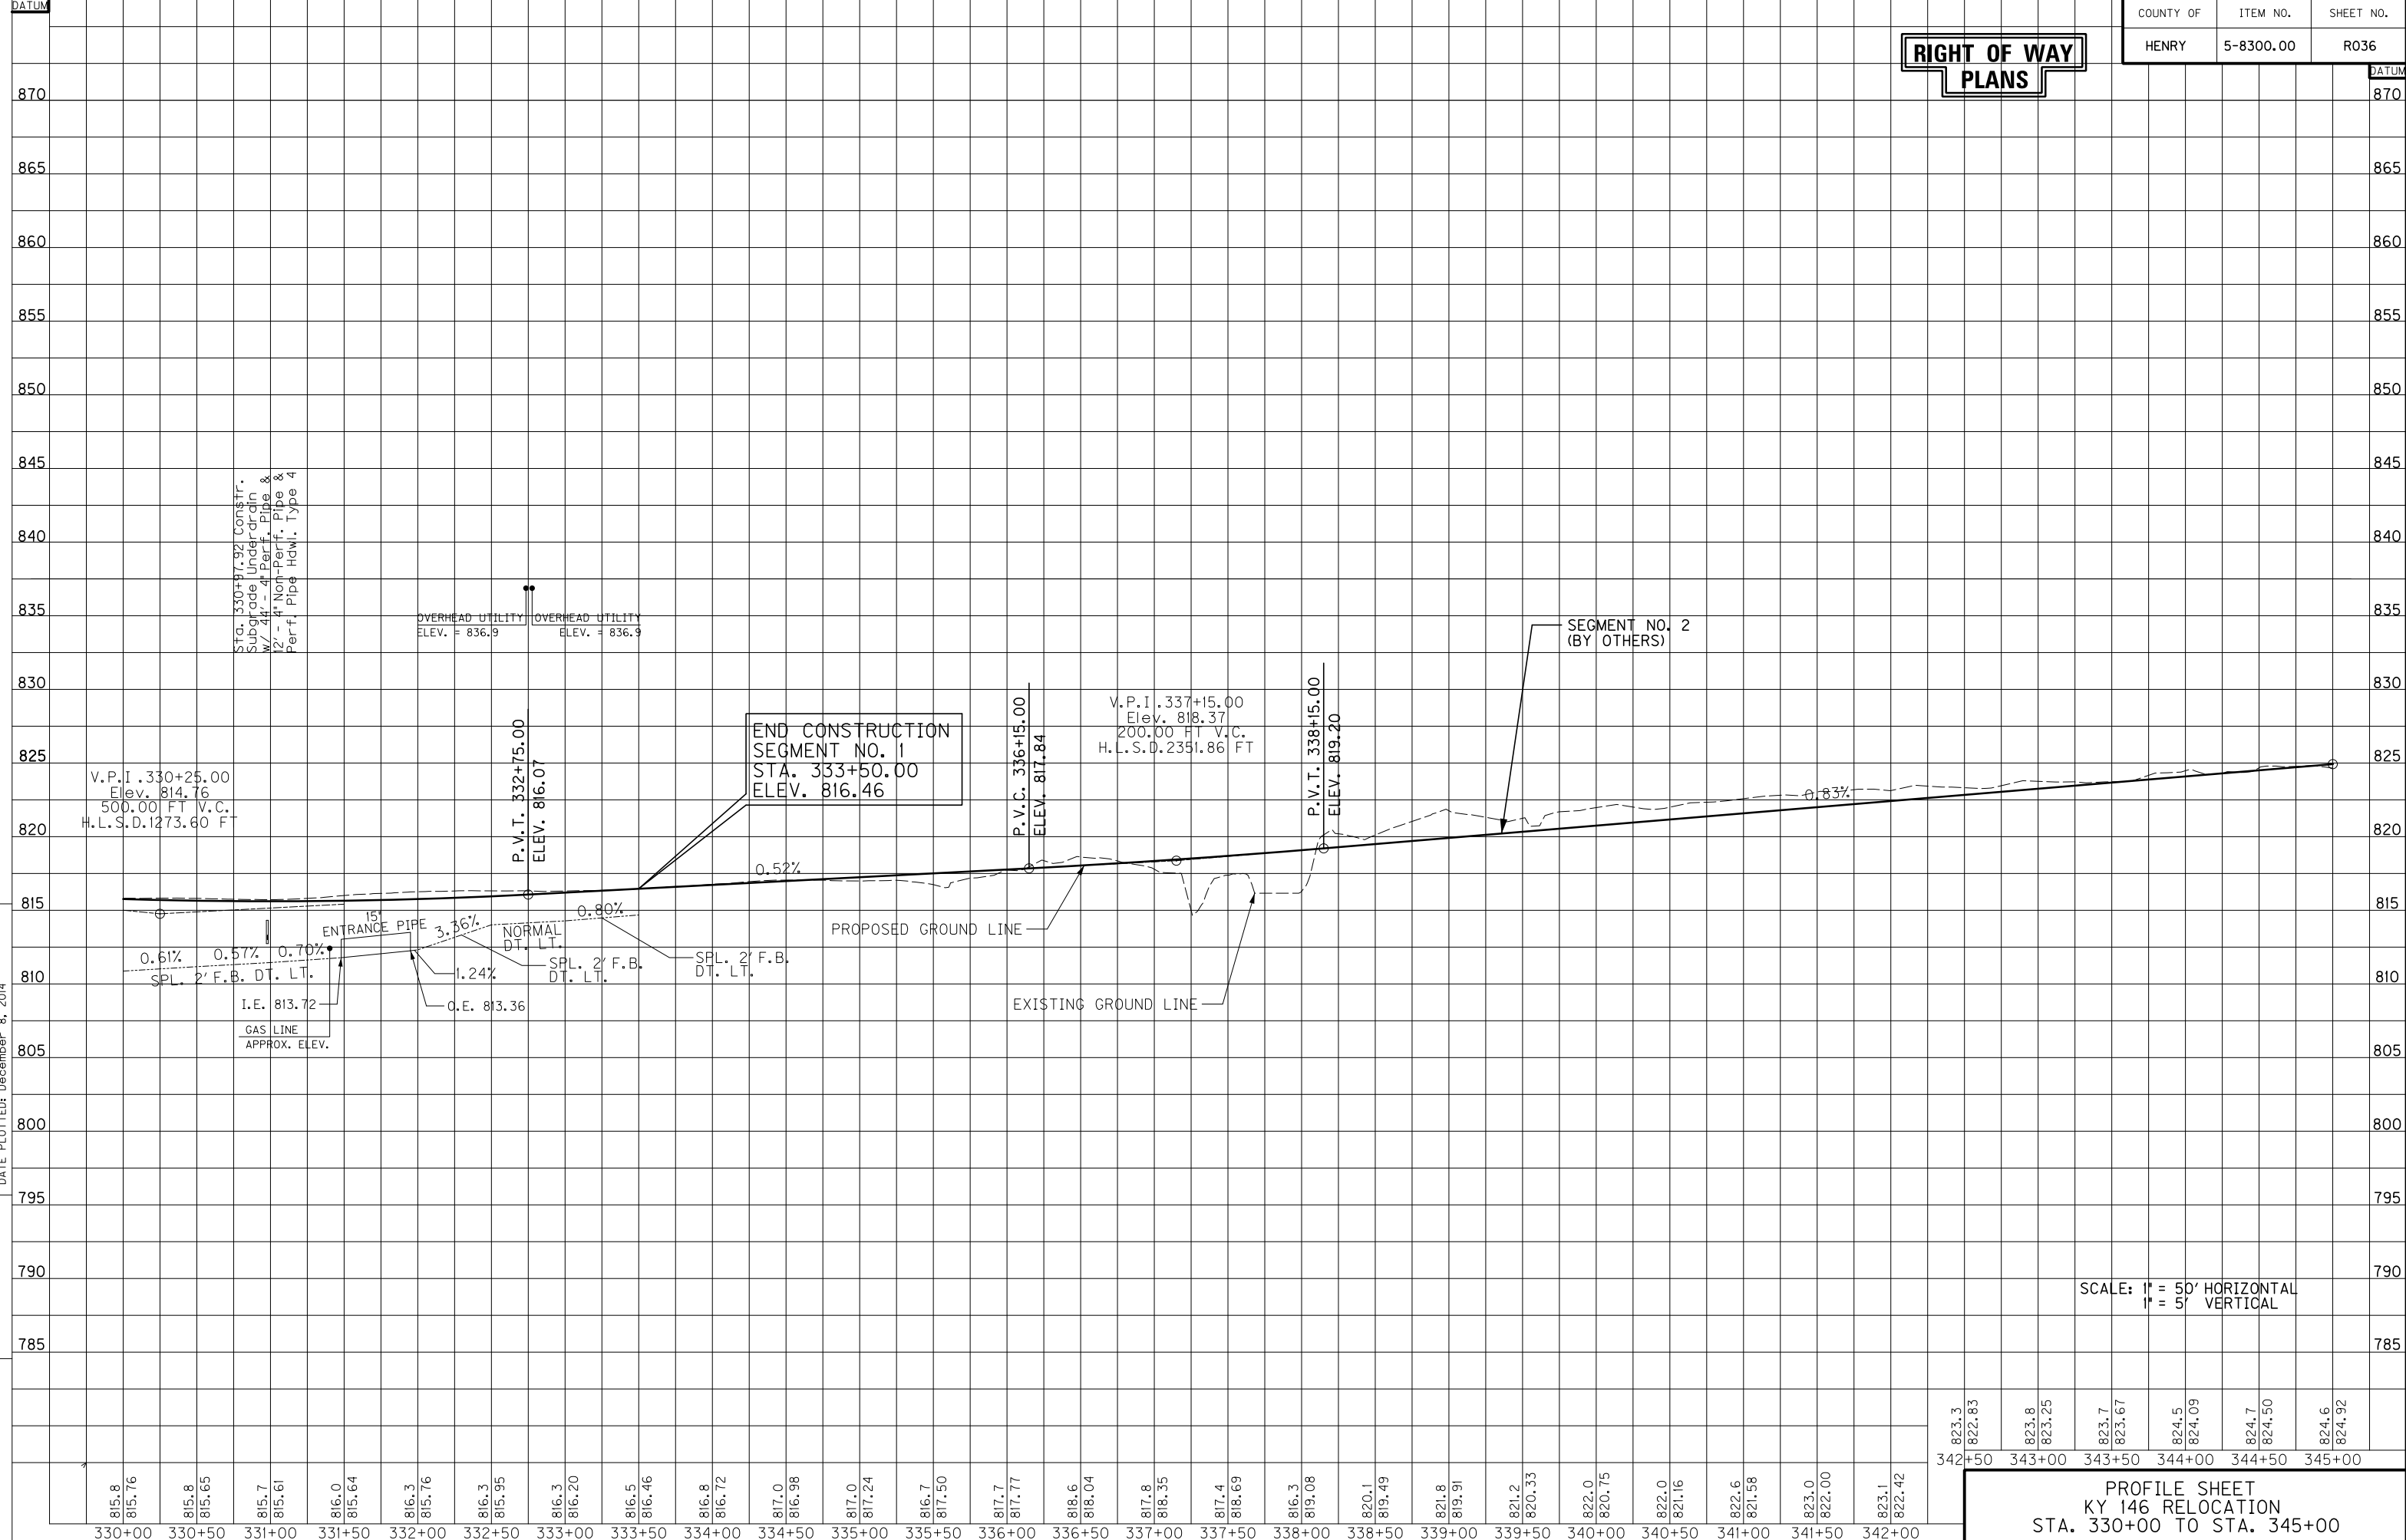

SCALE: 1" = 50' HORIZONTAL
1" = 5' VERTICAL

PROFILE SHEET
KY 146 RELOCATION
STA. 330+00 TO STA. 345+00

815.8	815.76	815.8	815.65	815.7	815.61	816.0	815.64	816.3	815.76	816.3	815.95	816.3	816.20	816.5	816.46	816.8	816.72	817.0	816.98	817.0	817.24	816.7	817.50	817.7	817.77	818.6	818.04	817.8	818.35	817.4	818.69	816.3	819.08	820.1	819.49	821.8	819.91	821.2	820.33	822.0	820.75	822.0	821.16	822.6	821.58	823.0	822.00	823.1	822.42	823.3	822.83	823.8	823.25	823.7	823.67	824.5	824.09	824.7	824.50	824.6	824.92
330+00	330+50	331+00	331+50	332+00	332+50	333+00	333+50	334+00	334+50	335+00	335+50	336+00	336+50	337+00	337+50	338+00	338+50	339+00	339+50	340+00	340+50	341+00	341+50	342+00	342+50	343+00	343+50	344+00	344+50	345+00																															

**RIGHT OF WAY
PLANS**

RIGHT OF WAY SUMMARY

PARCEL NO.	OWNER(S)	TOTAL AREA OF TRACT		PERMANENT R/W ACQUIRED		EASEMENTS		AREA SEVERED				EXCESS PURCHASED		PORTION REMAINING		SEWER SYSTEM TYPE	SEWER SYSTEM AFFECTED BY PROJECT		BUILDINGS ACQUIRED NUMBER					SOURCE OF TITLE	REMARKS*
		ACRES	SQ. FT.	ACRES	SQ. FT.	PERMANENT SQ. FT.	TEMPORARY SQ. FT.	LEFT		RIGHT		ACRES	SQ. FT.	ACRES	SQ. FT.		YES	NO	C	R	F	S			
								ACRES	SQ. FT.	ACRES	SQ. FT.														
1	SBH PROPERTIES, LLC			NOT USED											1	X						DB. 244 PG. 409			
2	UNITED CITIZENS BANK	1.02		NOT USED										1.02	1	X									
3	KENCON, INC	3.10		NOT USED										3.10	4	X							DB. 235 PG. 391		
4	KENCON, INC	3.99		NOT USED										3.99	1	X							DB. 235 PG. 388		
5	SBH PROPERTIES, LLC	9.62		NOT USED										9.62	1	X							DB. 257 PG. 106		
6	CECIL WHITAKER VICKI WHITAKER		36,113	NOT USED											1	X							DB. 265 PG. 513		
7	PILOT TRAVEL CENTERS, LLC			NOT USED											1	X									
8	COLEMAN ENTERPRISE, LLC	205.53			6,945		1,944	205.37						205.37	1	X							DB. 131 PG. 049 DB. 218 PG. 286	DB. 222 PG. 479	
9	KEVIN L. ELDRIDGE, TRUSTEE	4.23			1,313	4,252	15,696	4.20						4.20	1	X							DB. 185 PG. 648		
10	DOROTHY R. TAYLOR	3.59			27,854					2.95				2.95	1	X							DB. 273 PG. 873		
11	ROGER TAYLOR JR. CANDY TAYLOR (Wf.)	1.95		NOT USED										1.95	1	X							DB. 229 PG. 551		
12	ROGER G. TAYLOR, JR. CANDACE R. TAYLOR (Wf.)	112.56		NOT USED										112.56	1	X							DB. 273 PG. 885		
13	ROGER G. TAYLOR, JR. ET UX	123.50		8.63			1,888	3.61		111.25				114.86	1	X							DB. 273 PG. 878		
14	COLEMAN ENTERPRISE, LLC		14,440				1,251	14,440						14,440	4	X							DB. 177 PG. 047		
15	NATIONWIDE FENCE COMPANY, INC.	25.05		NOT USED										25.05	1	X							DB. 283 PG. 134		
16	JOHN A. CLARK DENISE COOMBS	1.14			884		4,336	1.12						1.12	1	X							DB. 158 PG. 492 DB. 177 PG. 050		
17	NATIONWIDE FENCE COMPANY, INC.	4.02			5,050		4,809	3.80						3.80	1	X							DB. 232 PG. 590		
18	WESLEY ALAN MERTZ, SR.	9.57			444			9.56						9.56	1	X							DB. 186 PG. 387		
19	JIMMY B. ADAMS VONDA R. ADAMS (Wf.)	6.66			15,036		2,679	6.32						6.32	1	X							DB. 155 PG. 747		
21	ROGER G. TAYLOR, JR. ET UX	15.13		1.61			4,965			13.52				13.52	4	X							DB. 273 PG. 878		
22	JEFFREY NICHOLS	4.86			2,549		4,074	4.80						4.80	1	X							DB. 250 PG. 917		
23	DANNY SHAIN SUSAN SHAIN	4.25			33,882		3,466			3.47				3.47	1	X							DB. 265 PG. 383		
24	JERRY G. WHITAKER BRANDI A. WHITAKER	25.02			3,736		2,578	24.94						24.94	1	X							DB. 279 PG. 142		
25	DANNY SHAIN SUSAN SHAIN	2.78			11,601		3,756			2.51				2.51	1	X							DB. 161 PG. 712		
26	DANNY SHAIN SUSAN SHAIN	1.72			13,086					1.42				1.42	4	X							DB. 186 PG. 710		
27	LITTLE KY RIVER WATERSHED	17.30		NOT USED										17.30	4	X									
28	PAUL DOUGLAS BAXTER	275.06		NOT USED										275.06	1	X							PG. 147 PG. 084 DB. 147 PG. 089		
29	OLDHAM FARMS DEVELOPMENT, LLC	116.61			2,868		9,895			116.55				116.55	4	X							DB. 243 PG. 563		
30	THOMAS THOMPSON	45.82		7.95			2,833	37.87						37.87	4	X							DB. 278 PG. 008 DB. 278 PG. 412	DB. 281 PG. 257	
31	CATHY DALENE McCANN	100.05		5.82				94.22						94.22	4	X							DB. 276 PG. 124		

NOTE: PERMANENT R/W ACQUIRED + AREA SEVERED = TOTAL AREA OF TRACT.
PARCEL NO. 20 NOT USED

TYPE SEWER SYSTEM
1. PRIVATE - INDIVIDUAL
2. PRIVATE - MULTI PARTY
3. PUBLIC
4. NONE
5. NOT APPLICABLE

BUILDINGS ACQUIRED CODE
C - COMMERCIAL
R - RESIDENTIAL
F - FARM
S - STORAGE

*INCLUDES HAZARDOUS WASTE
(UST - UNDERGROUND STORAGE TANKS)

MicroStation v8.11.7.443 E-SHEET NAME: DATE PLOTTED: December 9, 2014 USER: seilts FILE NAME: I:\3886-KY 146 HENRY-PHASE 2\SEGMENT 1\SHEETS\RW STRIPS AND SUMMARIES\R03700RW.DGN

**RIGHT OF WAY
PLANS**

RIGHT OF WAY SUMMARY

PARCEL NO.	OWNER(S)	TOTAL AREA OF TRACT		PERMANENT R/W ACQUIRED		EASEMENTS		AREA SEVERED				EXCESS PURCHASED		PORTION REMAINING		SEWER SYSTEM TYPE	SEWER SYSTEM AFFECTED BY PROJECT		BUILDINGS ACQUIRED NUMBER					SOURCE OF TITLE	REMARKS*
		ACRES	SQ. FT.	ACRES	SQ. FT.	PERMANENT SQ. FT.	TEMPORARY SQ. FT.	LEFT		RIGHT		ACRES	SQ. FT.	ACRES	SQ. FT.		YES	NO	C	R	F	S			
								ACRES	SQ. FT.	ACRES	SQ. FT.														
32	ROBERT ALLEN HUNTER, TRUSTEE	96.96		2.96			7,016	94.00					94.00		4		X						DB. 282 PG. 854		
33	FLOYD HARTLAGE FAMILY LIMITED PARTNERSHIP	332.54		5.10			16,932	327.44					327.44		1		X						DB. 228 PG. 452 DB. 229 PG. 700	DB. 252 PG. 087	
34	4W LAND AND LIVESTOCK, LLC	532.12		5.48			24,787				526.77		526.77		4		X						DB. 277 PG. 571		
35	STEPHEN L. RICHARDSON MARCELLA A. RICHARDSON (Wf.)	13.11		1.42			5,118	11.69					11.69		1		X						DB. 270 PG. 304		
36	TELIA B. FULLER		35,276		1,287	2,333	2,836							33,990		1		X					DB. 162 PG. 207		
37	ANNA MAY BAXTER	1.78			15,471		1,056				1.42			1.42		1		X					DB. 147 PG. 074		
38	SHERRY B. HAMILTON	6.11			25,984		23,597	5.51					5.51		1		X						DB. 172 PG. 325 DB. 176 PG. 512		
39	LAWRENCE E. DEAN, JR.	9.59			525		2,754	9.58					9.58		1		X						DB. 133 PG. 728		
40	MARK C. PITTENGER SUSAN G. PITTENGER (Wf.)	73.98		1.55			4,475	72.43					72.43		1		X						DB. 269 PG. 464		
41	RONALD M. PAIT CAROL ANN PAIT (Wf.)	17.53					3,122	17.53					17.53		1		X						DB. 250 PG. 265		
42	MICHAEL E. WALMER ET AL	4.96					3,242	4.96					4.96		1		X						DB. 259 PG. 457		
43	J & D INVESTMENTS LLC	26.63			444		14,703	26.67					26.67		4		X						DB. 254 PG. 371		
44	NANCY S. PILE MICHAEL J. LANEY	85.92			5,918		9,863	85.79					85.79		1		X						DB. 214 PG. 234		
45	ROBERTO GONZALES FLORINDA MARIBLE GONZALES	2.71			6,499			2.57					2.57		1		X						DB. 201 PG. 001		
46	BARRY W. LEIGEY EDNA JEAN LEIGEY		23,289		7,015		1,960					16,273		16,273	1	1/2							DB. 173 PG. 734	PERMITTED TRAILER PARK (1)	
47	GEORGE W. HOLCOMB TIFFANY D. HOLCOMB (Wf.)	4.55			18,897		6,972	4.12					4.12		1		X						DB. 267 PG. 144		
48	BARRY WAYNE LEIGEY EDNA JEAN LEIGEY		24,945		7,392		4,621					17,552		17,552	1	3/3							DB. 131 PG. 233	PERMITTED TRAILER PARK (3)	
49	BARRY WAYNE LEIGEY EDNA JEAN LEIGEY	16.80			11,795		2,562	16.52					16.52		1		X						DB. 131 PG. 233		
50	TINA STAMBAUGH	1.25					2,062	1.25					1.25		1		X						DB. 262 PG. 389		
51	JESSIE D. CHISHOLM ALMA K. CHISHOLM	107.78			4,131		3,094	107.68					107.68		4		X						DB. 097 PG. 001		
53	CORDELIA LEWMAN	99.94					2,468	99.94					99.94		4		X						DB. 209 PG. 896		
54	WHITE FAMILY FARM, LLC	221.17		1.05			1,305				220.12		220.12		4		X						DB. 266 PG. 297		
55	JOSH FOWLER	22.90					3,015	22.90					22.90		1		X						DB. 283 PG. 075 DB. 283 PG. 080		
56	JOSH FOWLER	87.82					3,196	87.82					87.82		4		X						DB. 283 PG. 075 DB. 283 PG. 080		
57	THE CLAYTON E. BILLINGS LIVING TRUST DATED 1-23-2009	73.46			39,759		6,192				72.55		72.55		1		X						DB. 274 PG. 899		
58	SAFETY-KLEEN SYSTEMS, INC.	44.07		NOT USED									44.07		4		X						DB. 206 PG. 798		
59	SAFETY-KLEEN SYSTEMS, INC.	56.63					11,688	56.63					56.63		1		X						DB. 206 PG. 798		
61	THE CRISTOFOLI FAMILY LIMITED PARTNERSHIP	103.10		2.82			4,331				100.28		100.28		4		X						DB. 192 PG. 659		
62	JOSHUA L. BUTTERFIELD ET AL		42,099				383				42,099			42,099	1		X						DB. 241 PG. 541		
63	DEE L. RAYMER MARY ALICE RAYMER (Wf.)	90.65		1.73			8,445	88.92					88.92		1		X						DB. 113 PG. 257		

NOTE: PERMANENT R/W ACQUIRED + AREA SEVERED = TOTAL AREA OF TRACT.
PARCEL NO. 52 AND 60 NOT USED

TYPE SEWER SYSTEM
1. PRIVATE - INDIVIDUAL
2. PRIVATE - MULTI PARTY
3. PUBLIC
4. NONE
5. NOT APPLICABLE

BUILDINGS ACQUIRED CODE
C - COMMERCIAL
R - RESIDENTIAL
F - FARM
S - STORAGE

*INCLUDES HAZARDOUS WASTE
(UST - UNDERGROUND STORAGE TANKS)

FILE NAME: I:\3886-KY 146 HENRY-PHASE 2\SEGMENT 1\SHEETS\RW STRIPS AND SUMMARIES\R03800RW.DGN
USER: sgr/ice
DATE PLOTTED: January 5, 2015
E-SHEET NAME:
MicroStation v8.11.7.443

COUNTY OF	ITEM NO.	SHEET NO.
HENRY	5-8300.00	R040

**RIGHT OF WAY
PLANS**



FILE NAME: I:\3886-KY 146 HENRY\PHASE 2\SEGMENT 1\SHEETS\RW STRIPS AND SUMMARIES\R04000RW.DGN
 USER: TRobinson
 DATE PLOTTED: December 8, 2014
 E-SHEET NAME:
 MicroStation v8.11.7.443




RIGHT OF WAY STRIP MAP
 KY 146 RELOCATION
 STA. 100+19.28 TO STA. 120+00

COUNTY OF	ITEM NO.	SHEET NO.
HENRY	5-8300.00	R041

**RIGHT OF WAY
PLANS**



MicroStation v8.11.7.443 E-SHEET NAME: USER: TROBINSON DATE PLOTTED: December 8, 2014 FILE NAME: I:\3886-KY 146 HENRY\PHASE 2\SEGMENT 1\SHEETS\RW STRIPS AND SUMMARIES\R04100RW.DGN

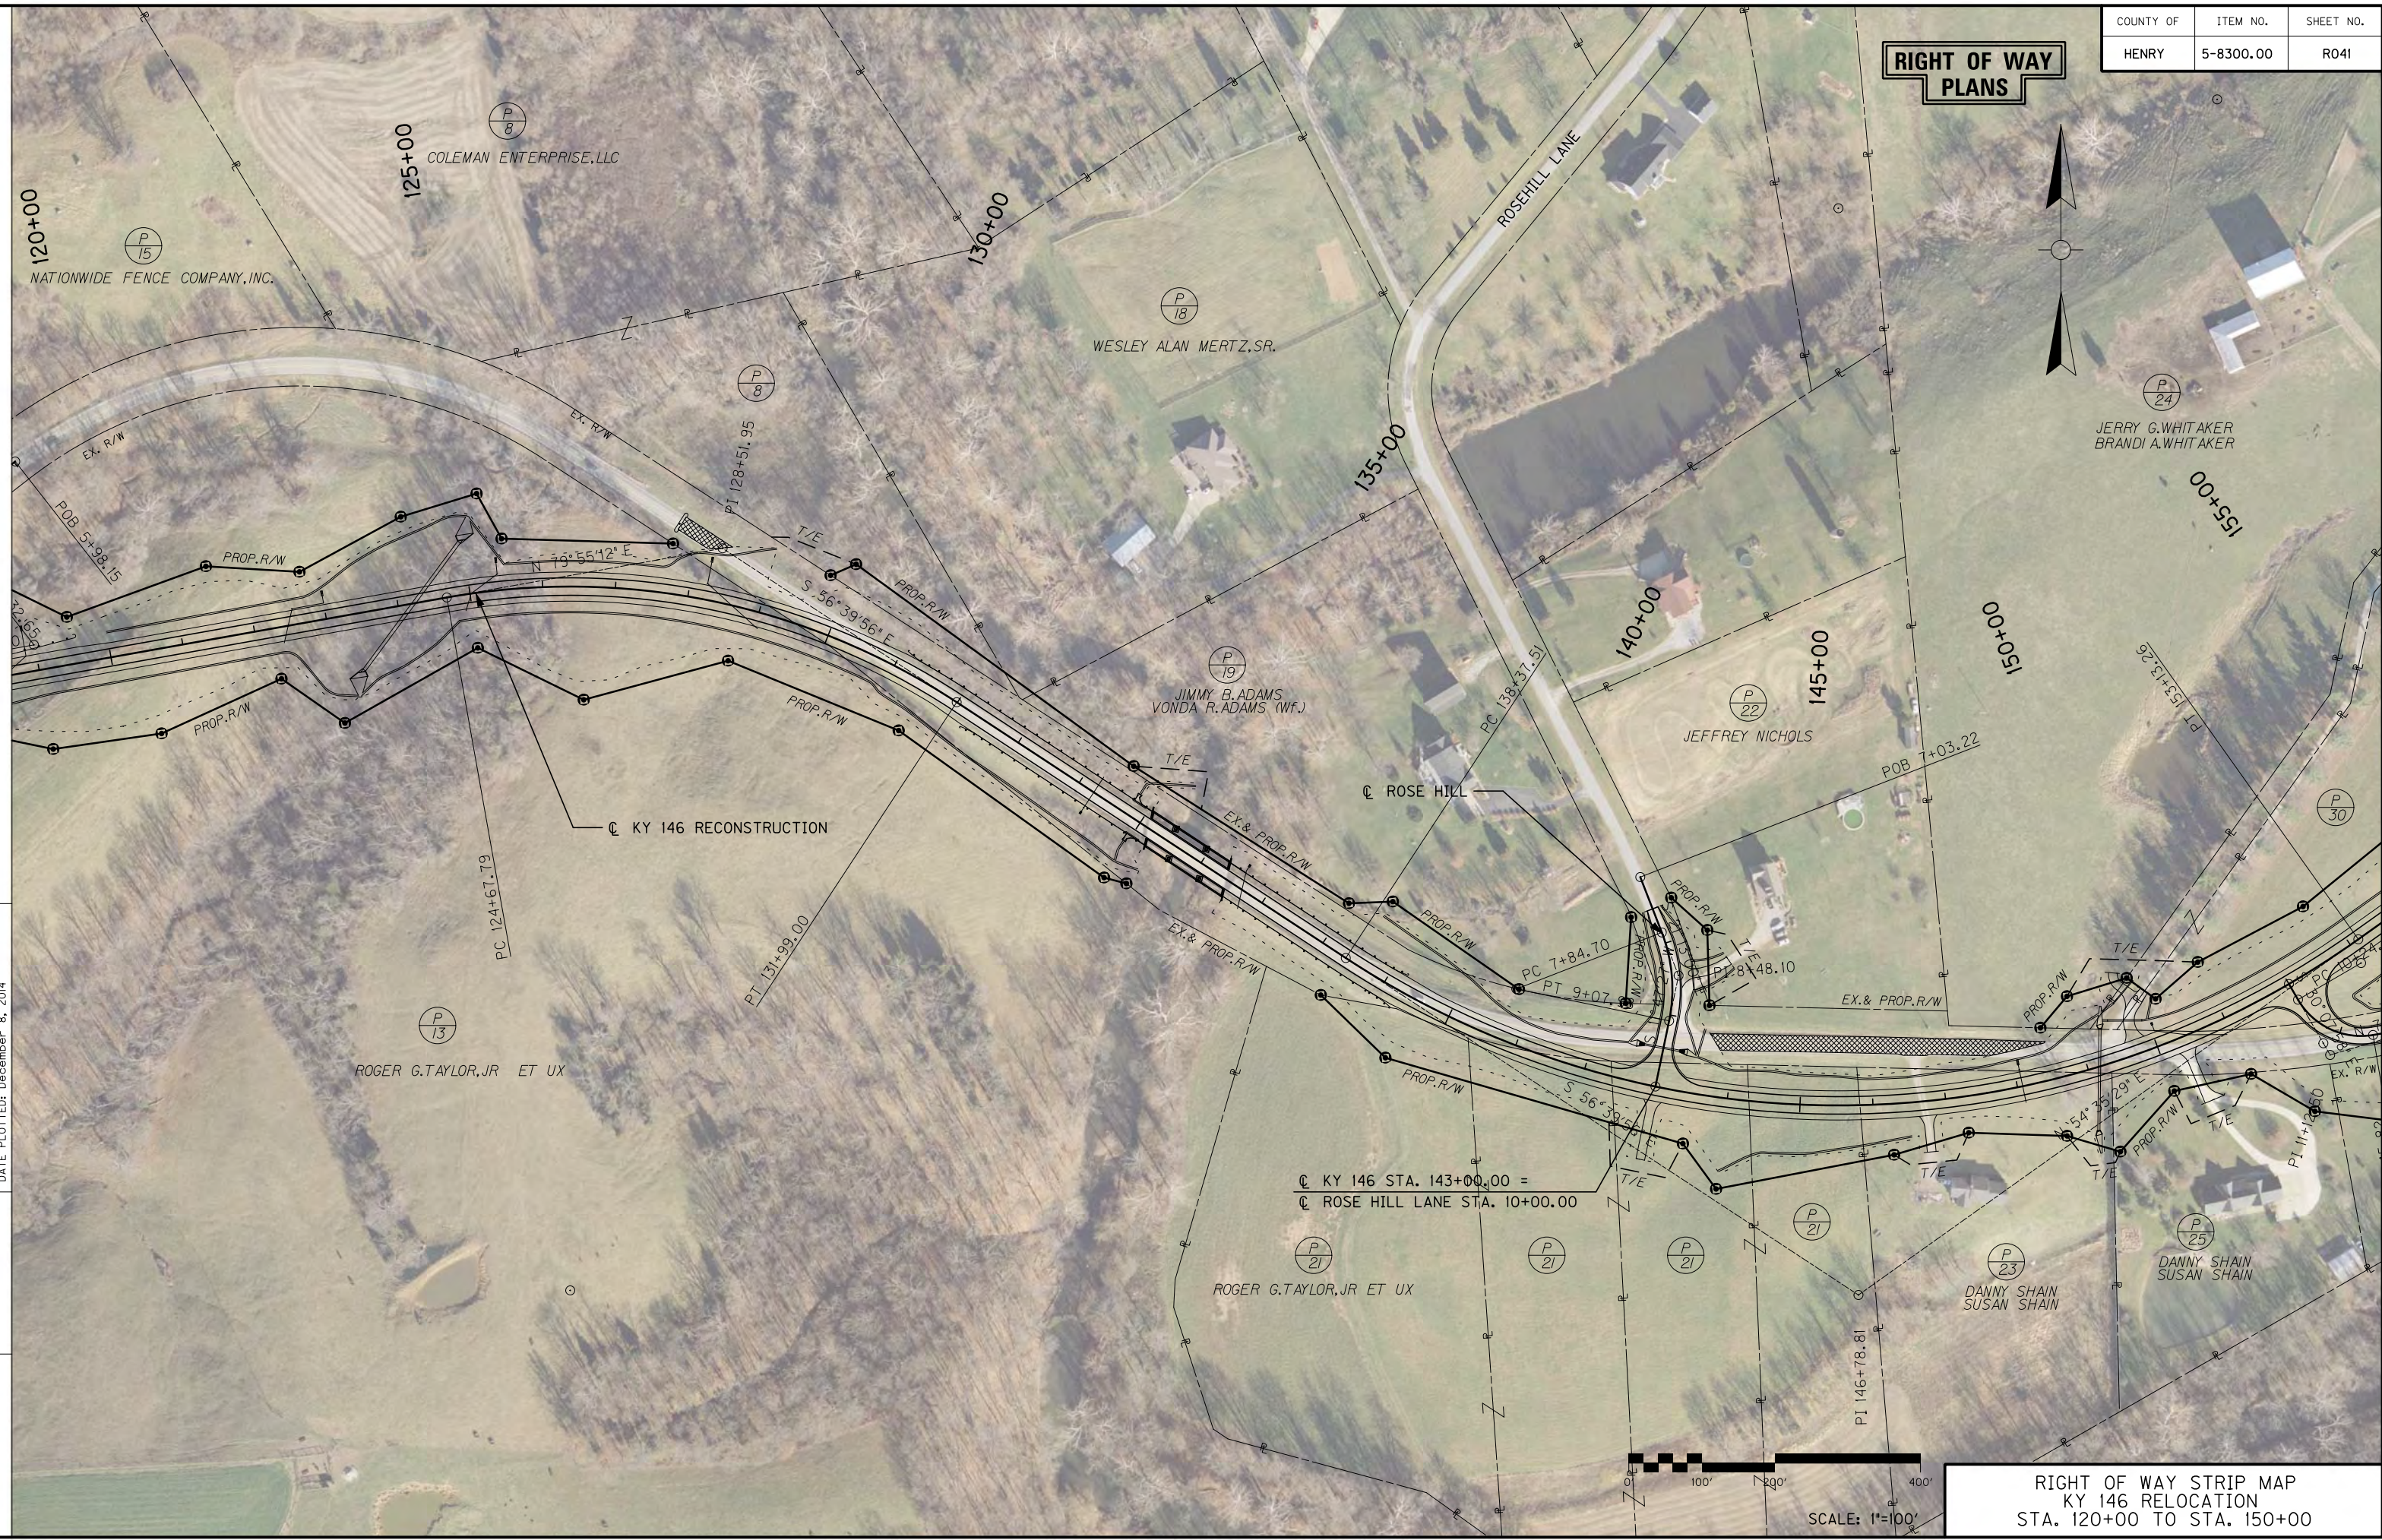

C KY 146 STA. 143+00.00 =
 C ROSE HILL LANE STA. 10+00.00


RIGHT OF WAY STRIP MAP
 KY 146 RELOCATION
 STA. 120+00 TO STA. 150+00

SCALE: 1"=100'

COUNTY OF	ITEM NO.	SHEET NO.
HENRY	5-8300.00	R042

RIGHT OF WAY PLANS

FILE NAME: I:\3886-KY 146 HENRY\PHASE 2\SEGMENT 1\SHEETS\RW STRIPS AND SUMMARIES\R04200RW.DGN
 USER: TRobinson
 DATE PLOTTED: December 8, 2014
 E-SHEET NAME:
 MicroStation v8.11.7.443

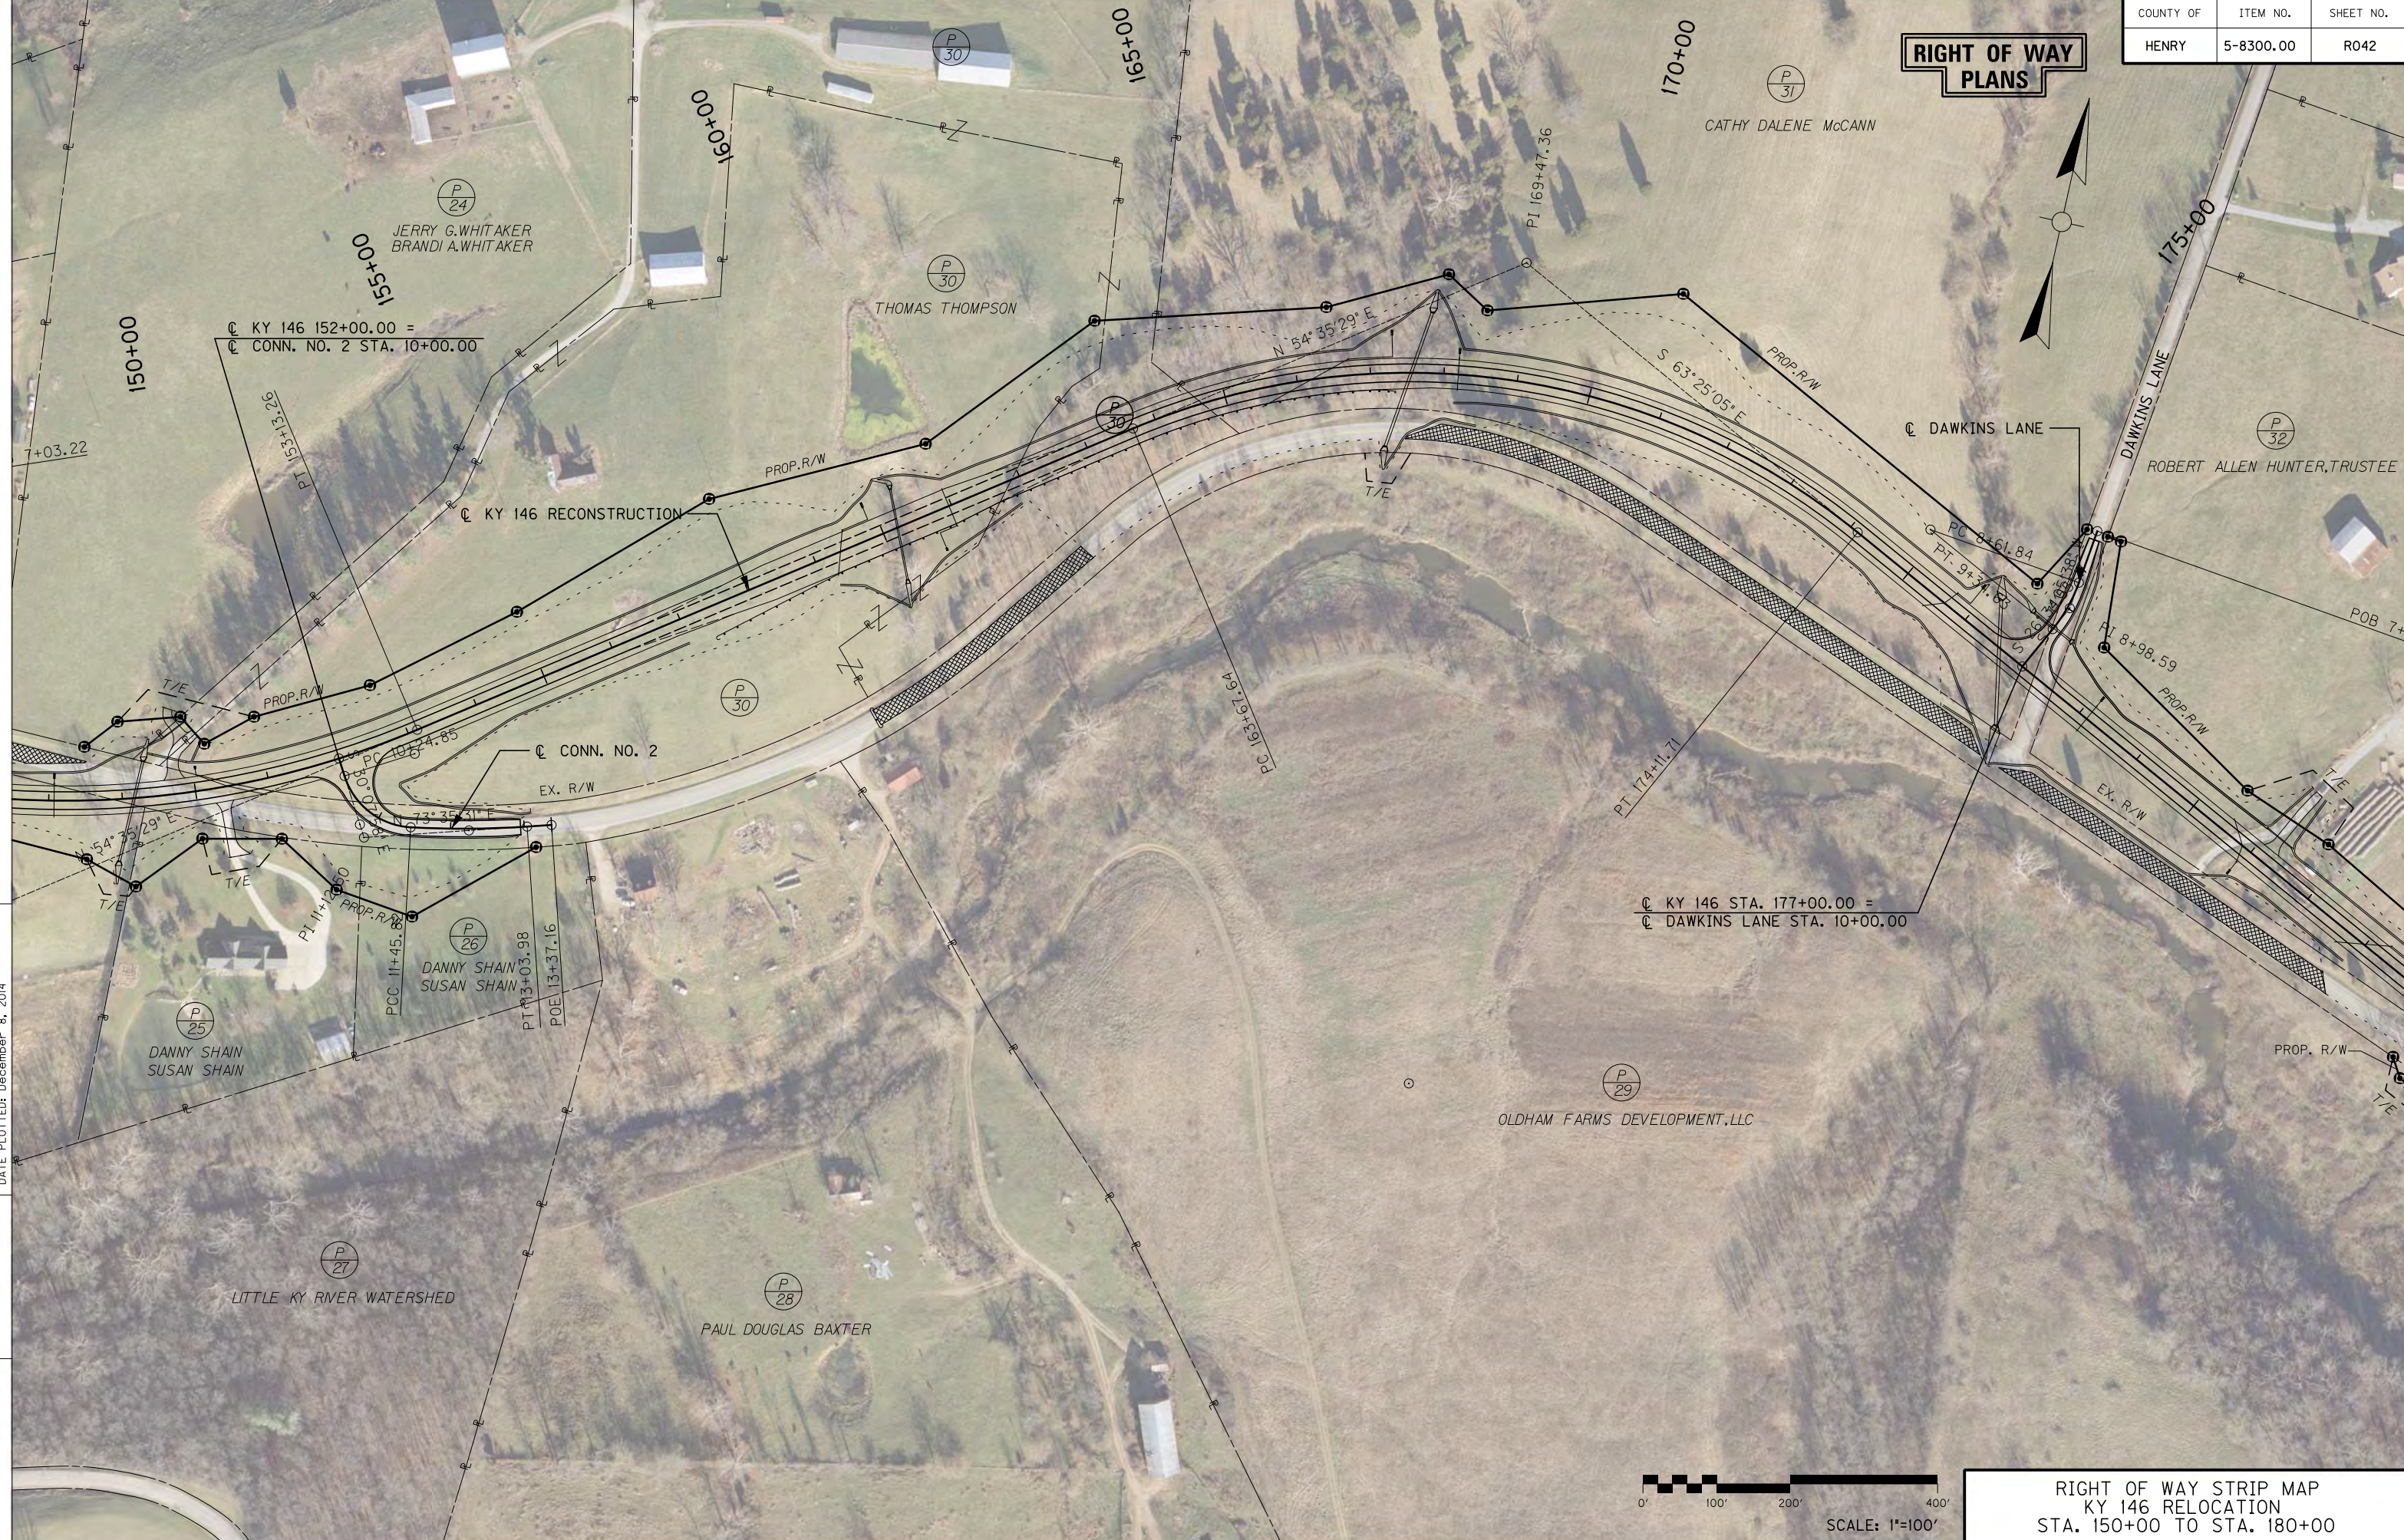


RIGHT OF WAY STRIP MAP
 KY 146 RELOCATION
 STA. 150+00 TO STA. 180+00

COUNTY OF	ITEM NO.	SHEET NO.
HENRY	5-8300.00	R043

RIGHT OF WAY PLANS

FILE NAME: I:\3886-KY 146 HENRY PHASE 2\SEGMENT 1\SHEETS\RW STRIPS AND SUMMARIES\R04300RW.DGN
 USER: TRobinson
 DATE PLOTTED: December 8, 2014
 E-SHEET NAME:
 MicroStation v8.1i.7.443

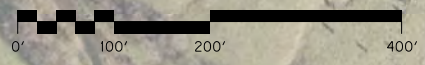

SCALE: 1"=100'


RIGHT OF WAY STRIP MAP
 KY 146 RELOCATION
 STA. 180+00 TO STA. 210+00

COUNTY OF	ITEM NO.	SHEET NO.
HENRY	5-8300.00	R044

RIGHT OF WAY PLANS



FILE NAME: I:\3886-KY 146 HENRY\PHASE 2\SEGMENT 1\SHEETS\RW STRIPS AND SUMMARIES\R04400RW.DGN
 USER: TRobinson
 DATE PLOTTED: December 8, 2014
 E-SHEET NAME:
 MicroStation v8.11.7.443

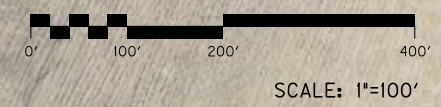


RIGHT OF WAY STRIP MAP
 KY 146 RELOCATION
 STA. 210+00 TO STA. 240+00

COUNTY OF	ITEM NO.	SHEET NO.
HENRY	5-8300.00	R045


**RIGHT OF WAY
PLANS**

FILE NAME: I:\3886-KY 146 HENRY\PHASE 2\SEGMENT 1\SHEETS\RW STRIPS AND SUMMARIES\R04500RW.DGN
 USER: TRobinson
 DATE PLOTTED: December 8, 2014
 E-SHEET NAME:
 MicroStation v8.11.7.443

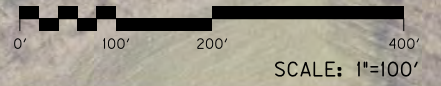

COUNTY OF	ITEM NO.	SHEET NO.
HENRY	5-8300.00	R046

RIGHT OF WAY PLANS

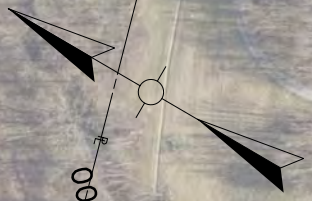

FILE NAME: I:\3886-KY 146 HENRY\PHASE 2\SEGMENT 1\SHEETS\RW STRIPS AND SUMMARIES\R04600RW.DGN
 USER: TRobinson
 DATE PLOTTED: December 8, 2014
 E-SHEET NAME:
 MicroStation v8.11.7.443



RIGHT OF WAY STRIP MAP
 KY 146 RELOCATION
 STA. 270+00 TO STA. 300+00

COUNTY OF	ITEM NO.	SHEET NO.
HENRY	5-8300.00	R047

RIGHT OF WAY PLANS


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 USER: TRobinson
 DATE PLOTTED: December 8, 2014
 E-SHEET NAME:
 MicroStation v8.11.7.443



RIGHT OF WAY STRIP MAP
 KY 146 RELOCATION
 STA. 300+00 TO STA. 330+00

COUNTY OF	ITEM NO.	SHEET NO.
HENRY	5-8300.00	R048

**RIGHT OF WAY
PLANS**

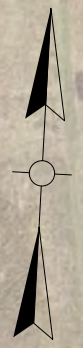

FILE NAME: I:\3886-KY 146 HENRY\PHASE 2\SEGMENT 1\SHEETS\RW STRIPS AND SUMMARIES\R04800RW.DGN
 USER: TRobinson
 DATE PLOTTED: December 8, 2014
 E-SHEET NAME:
 MicroStation v8.11.7.443




END CONSTRUCTION
SEGMENT NO. 1
STA. 333+50.00

END RIGHT OF WAY
STA. 341+15.41
SEGMENT NO. 1

© KY 146 RECONSTRUCTION
SEGMENT NO. 2 BY OTHERS

LOST CREEK ROAD

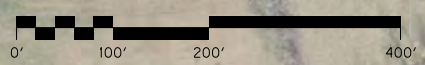

SCALE: 1"=100'

RIGHT OF WAY STRIP MAP
KY 146 RELOCATION
STA. 330+00 TO STA. 360+00

(P 66)
JOHN J. CRISTOFOLI
JOHANNA B. CRISTOFOLI (Wf.)



(P 65)
JARED ROBERTS

(P 67)
BARRY D. GREEN
CHERYL M. GREEN (Wf.)

(P 63)
DEE L. RAYMER
MARY ALICE RAYMER (Wf.)

COUNTY OF	ITEM NO.	SHEET NO.
HENRY	5-8300.00	R126


MicroStation v8.11.7.443
 E-SHEET NAME:
 DATE PLOTTED: December 5, 2014
 USER: spruce
 FILE NAME: I:\3886-KY 146 HENRY PHASE 2 SEGMENT 1\ SHEETS\COORDINATE CONTROL\R12600CC.DGN

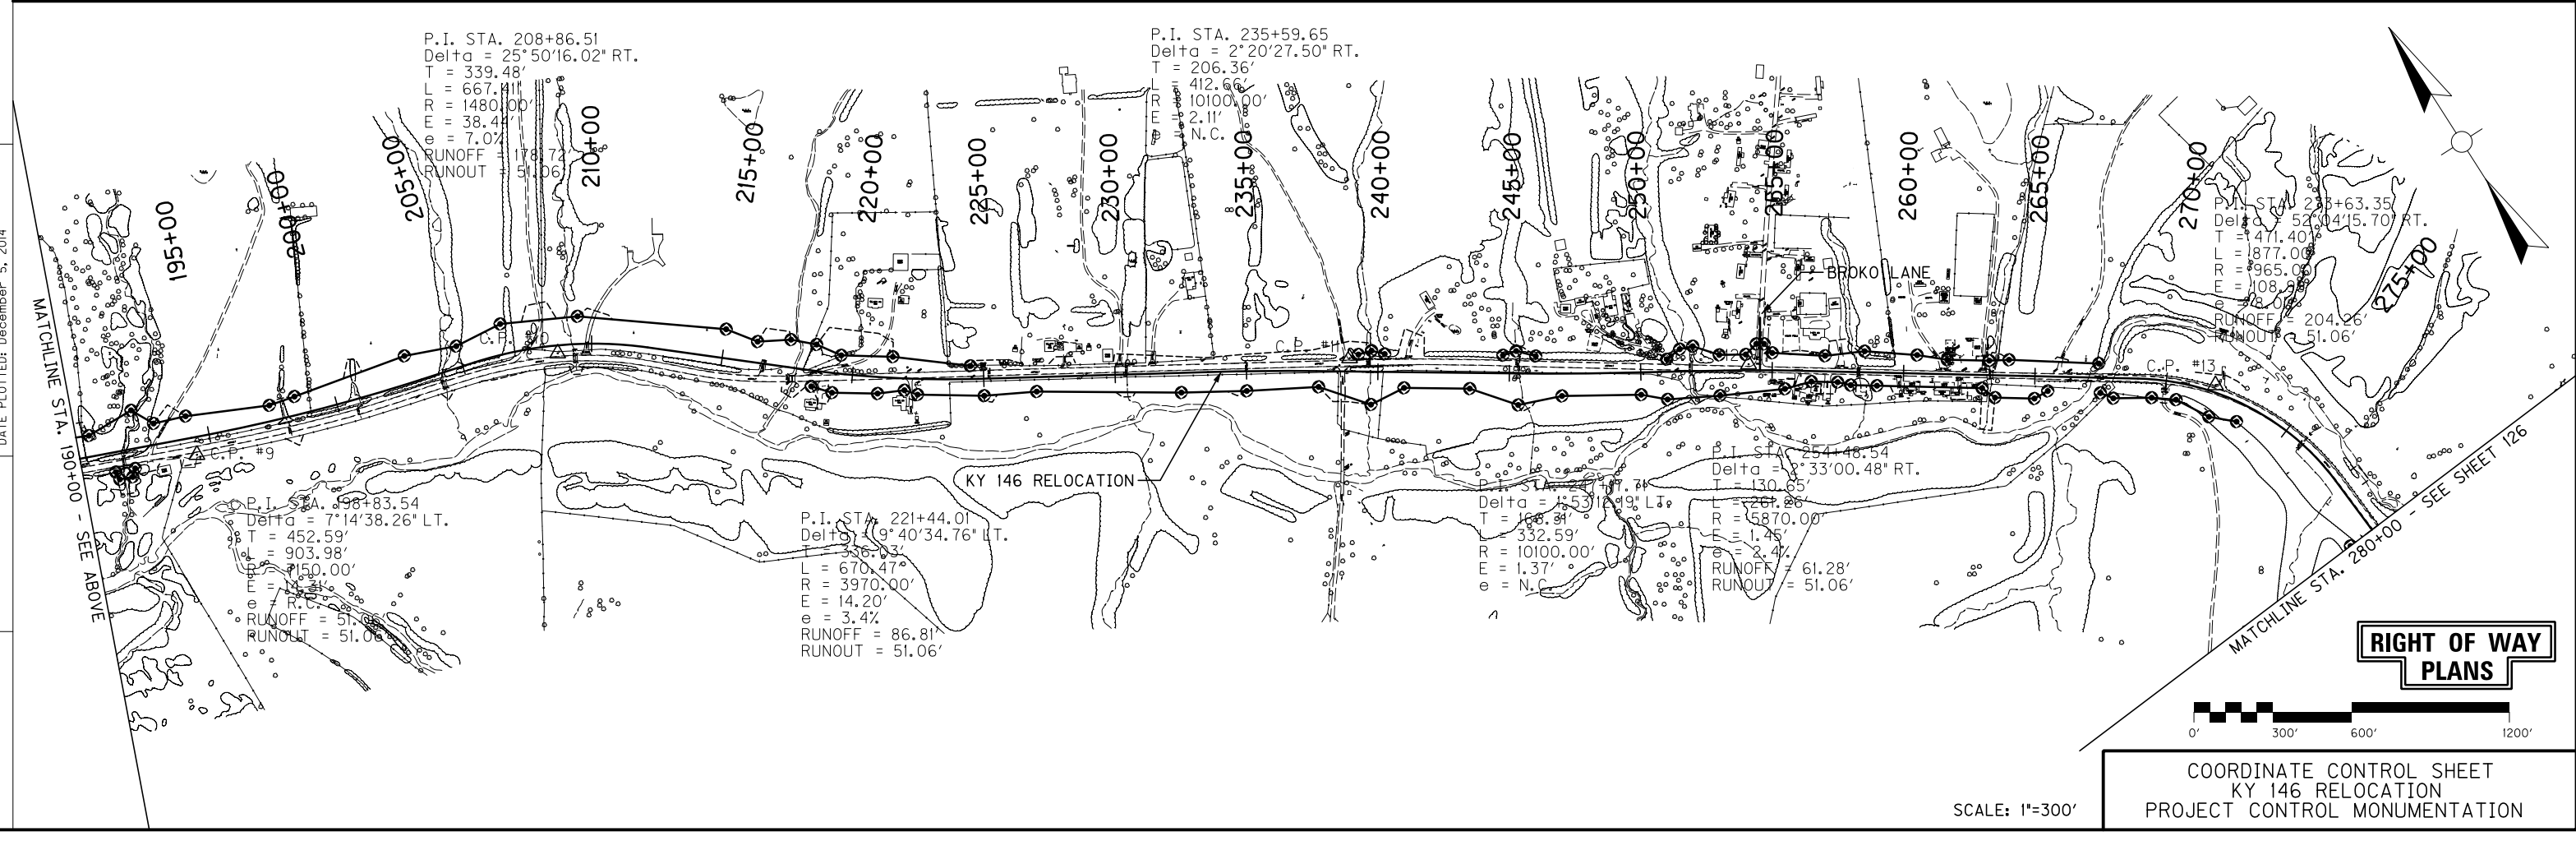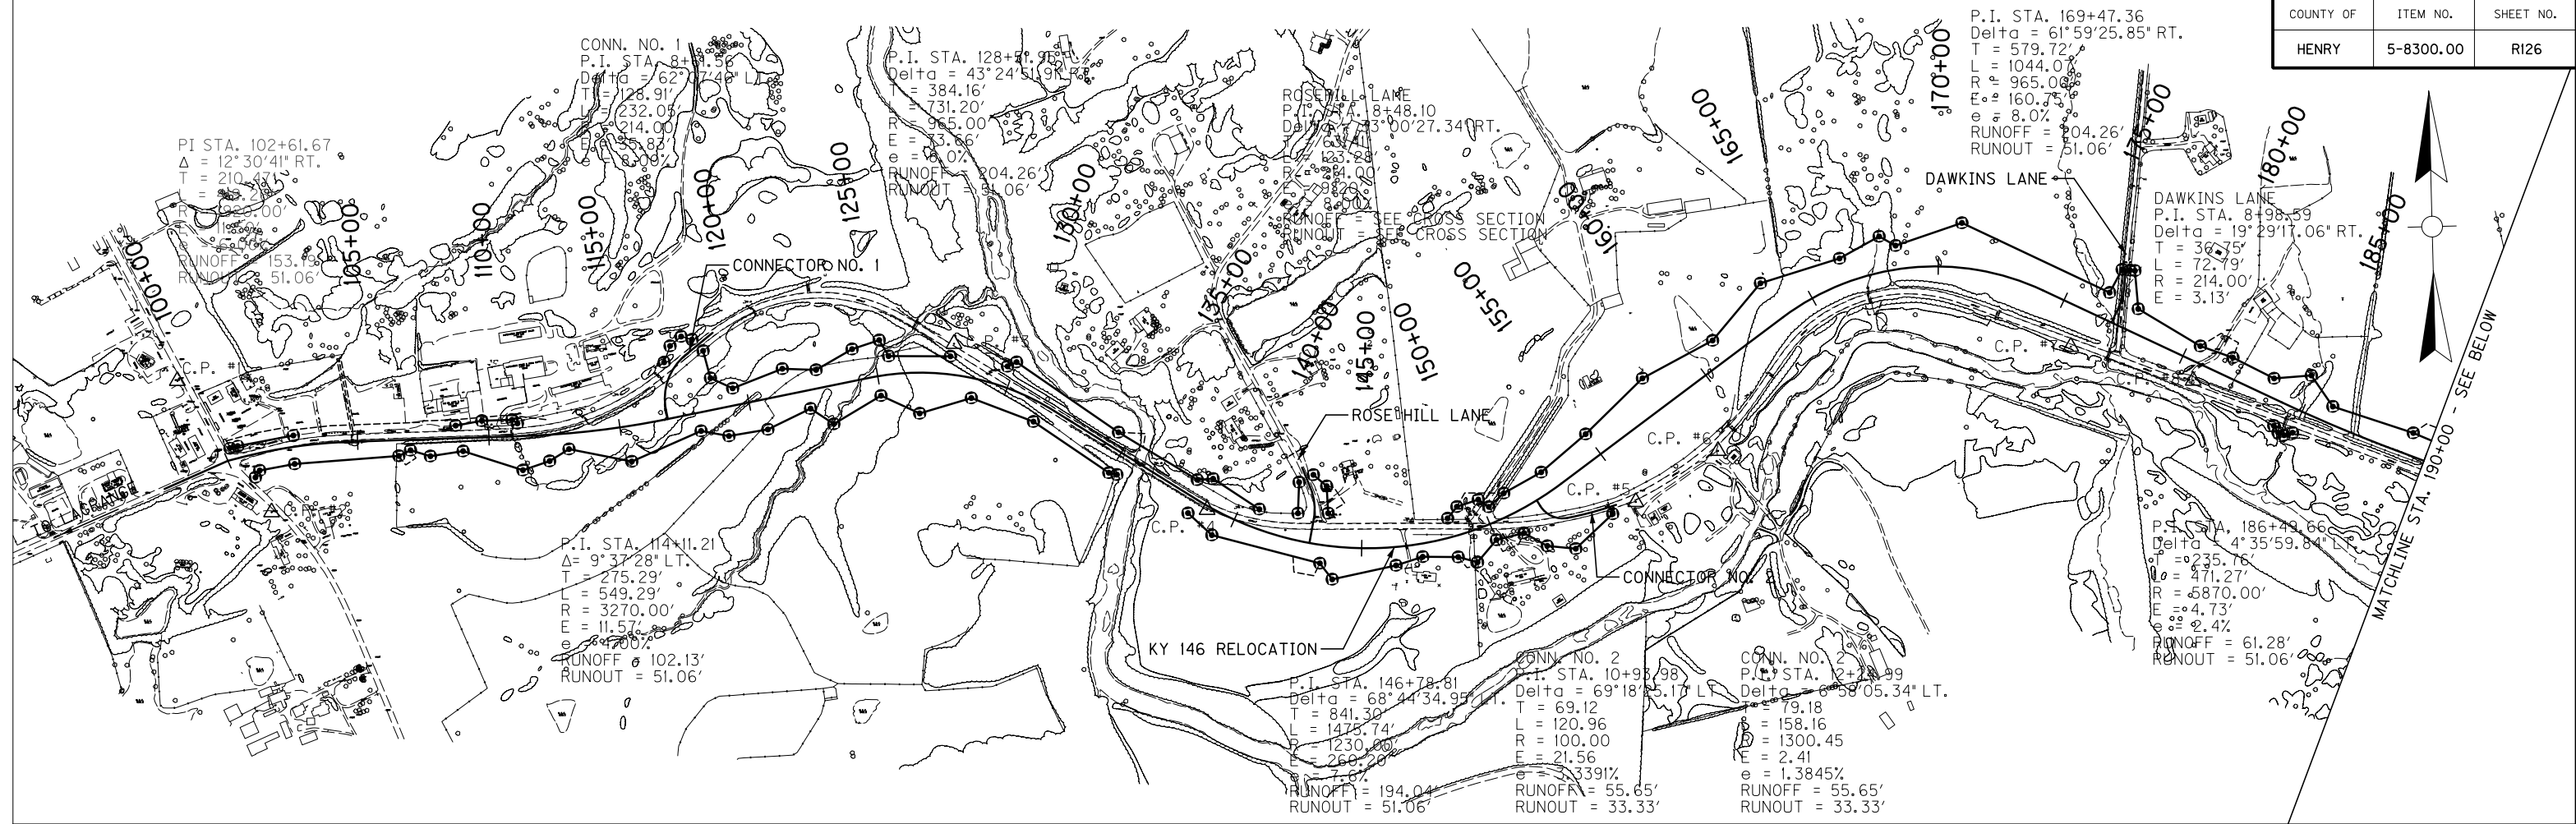

COORDINATE CONTROL SHEET
 KY 146 RELOCATION
 PROJECT CONTROL MONUMENTATION
 SCALE: 1"=300'

RIGHT OF WAY PLANS

FILE NAME: I:\3886-KY 146 HENRY PHASE 2\SEGMENT 1\ SHEETS\COORDINATE CONTROL\RI2700CC.DGN
 USER: sgr/lee
 DATE PLOTTED: December 5, 2014
 E-SHEET NAME:
 MicroStation v8.11.7.443

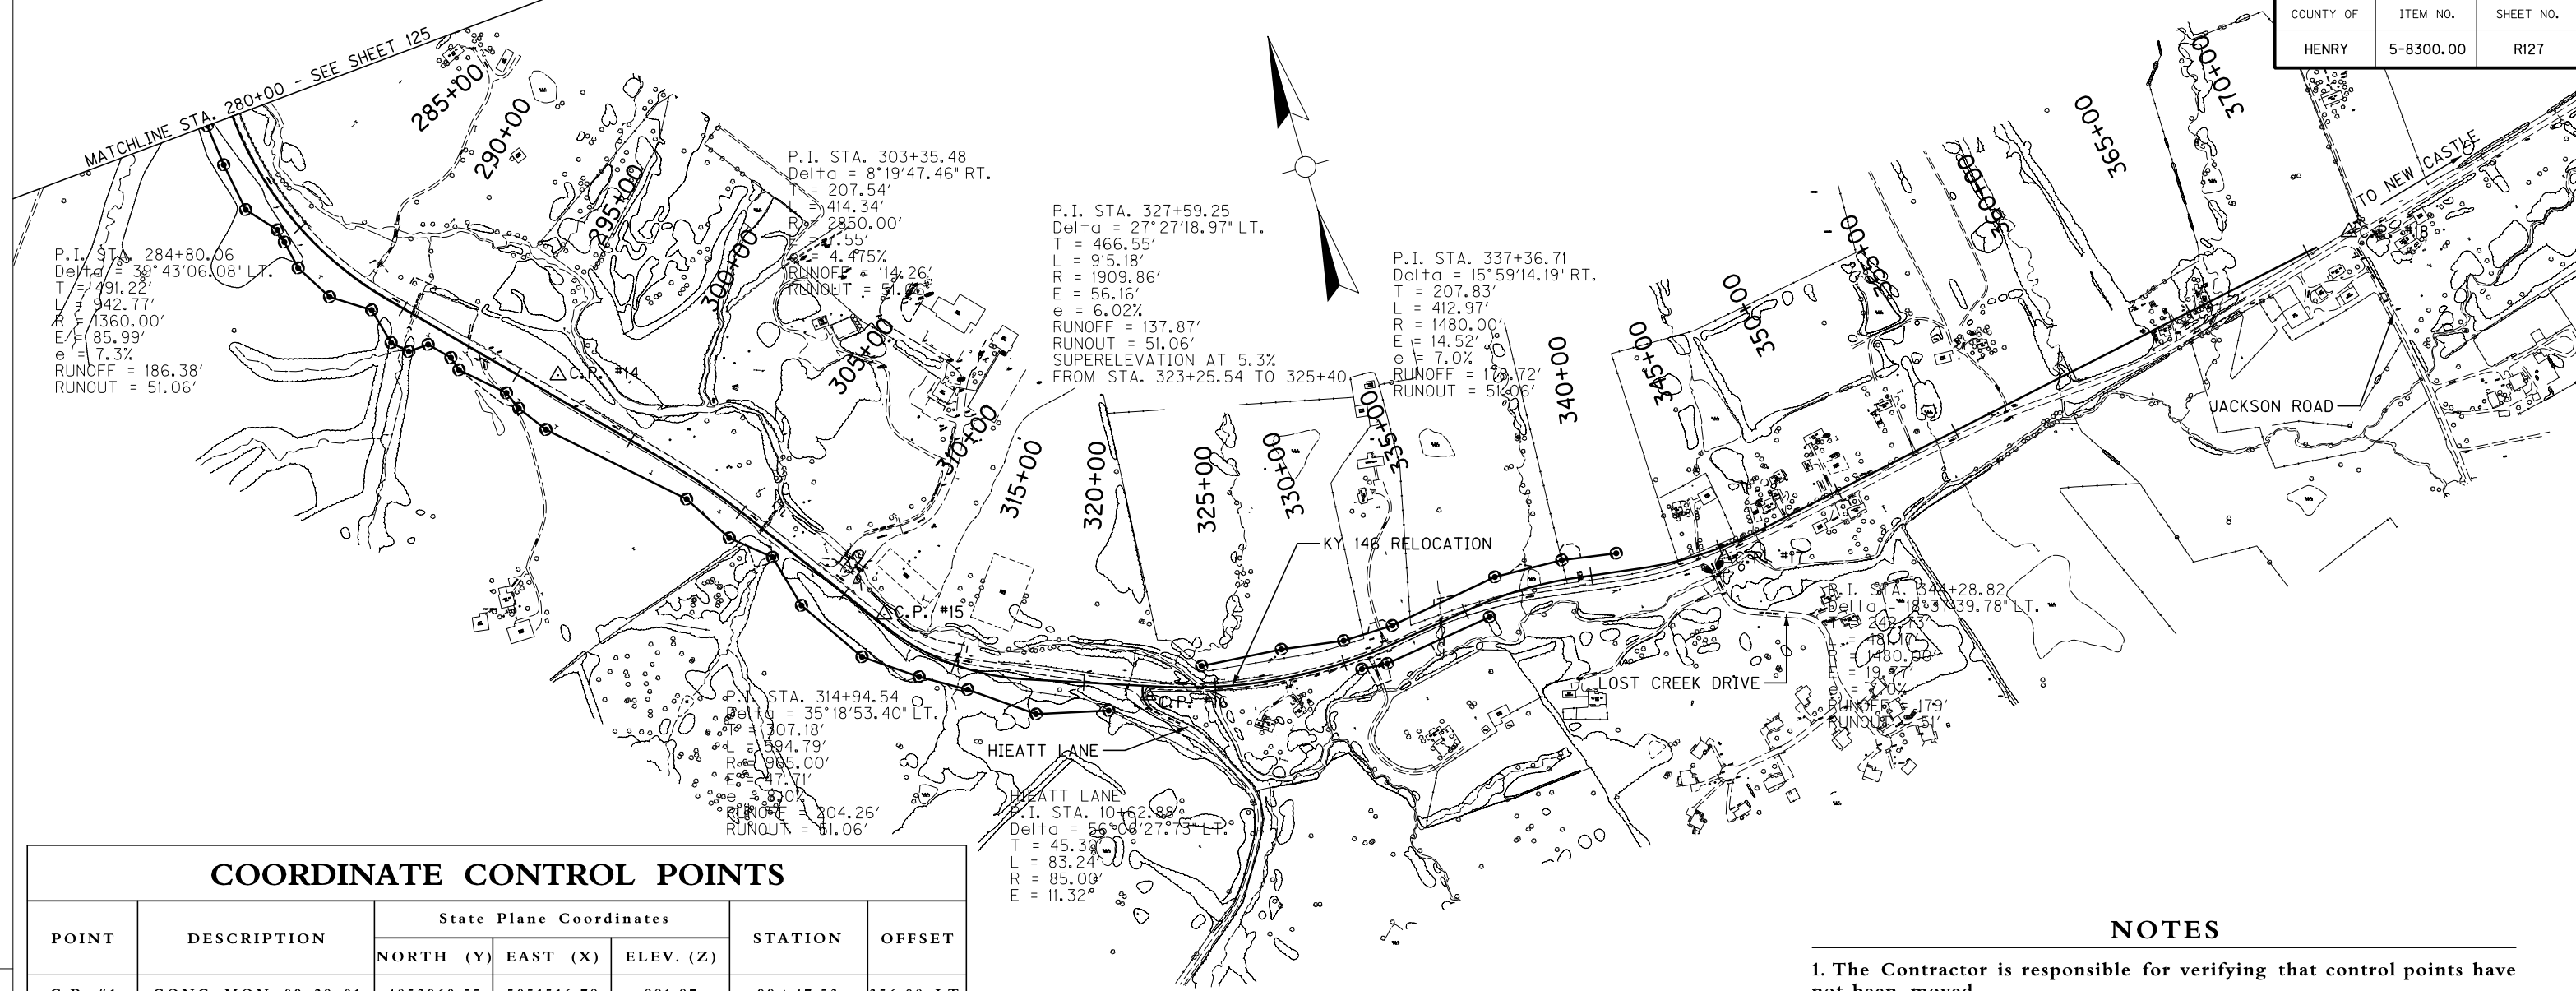

COORDINATE CONTROL POINTS

POINT	DESCRIPTION	State Plane Coordinates			STATION	OFFSET
		NORTH (Y)	EAST (X)	ELEV. (Z)		
C.P. #1	CONC. MON. 09-29-01	4052960.55	5051516.78	881.87	99+47.53	356.00 LT.
C.P. #2	CONC. MON. 09-29-02	4052451.97	5051862.41	881.01	101+20.42	229.63 RT.
C.P. #3	CONC. MON. 09-29-30	4053025.73	5054473.95	757.78	127+77.08	117.46 LT.
C.P. #4	CONC. MON. 09-29-29	4052369.67	5055420.52	760.28	138+91.45	13.52 RT.
C.P. #5	CONC. MON. 09-29-28	4052357.85	5057051.43	772.48	154+97.63	225.79 RT.
C.P. #6	CONC. MON. 09-29-27	4052544.23	5057369.25	766.55	158+64.66	258.03 RT.
C.P. #7	CONC. MON. 09-29-03	4052905.54	5058720.96	760.92	175+98.49	149.09 RT.
C.P. #8	CONC. MON. 09-29-04	4052764.79	5059183.02	767.52	180+74.69	68.20 RT.
C.P. #9	CONC. MON. 09-29-26	4052210.15	5060435.93	779.18	194+40.17	67.21 RT.
C.P. #10	CONC. MON. 09-29-25	4051796.27	5061800.19	766.12	208+67.74	30.05 RT.
C.P. #11	CONC. MON. 09-29-24	4050158.11	5064328.73	800.01	238+91.65	50.60 LT.
C.P. #12	CONC. MON. 09-29-05	4049321.23	5065595.25	796.02	254+10.40	22.82 LT.
C.P. #13	CONC. MON. 09-29-06	4048297.79	5067049.01	797.34	271+83.66	26.84 LT.
C.P. #14	CONC. MON. 09-29-23	4046224.47	5068170.04	838.72	296+35.62	76.58 LT.
C.P. #15	CONC. MON. 09-29-07	4045006.69	5069108.56	807.06	311+67.50	33.59 LT.
C.P. #16	CONC. MON. 09-29-08	4044433.36	5069986.96	820.78	322+45.93	34.83 RT.
C.P. #17	CONC. MON. 09-29-22	4044326.03	5072236.84	822.31	345+04.21	42.10 RT.
C.P. #18	CONC. MON. 09-29-21	4044857.20	5074861.10	872.31	371+77.11	5.58 RT.

NOTES

- The Contractor is responsible for verifying that control points have not been moved.
- See Plan Sheets for locations of Control Points.
- Some Control Points are located outside of the Plan Sheet limits.

COORDINATE SYSTEM

Coordinates for horizontal control were obtained from GPS methods and adjusted to the National NAD83/FBN System.

Coordinates are based on State Plane Coordinate System KY Single Zone and in U.S. Survey Feet.

BASIS OF ELEVATIONS

Elevations were derived from GPS methods and are adjusted to the NAVD88 Vertical Datum. Geoid model used was Geoid03.

**RIGHT OF WAY
PLANS**



SCALE: 1"=300'

COORDINATE CONTROL SHEET
 KY 146 RELOCATION
 PROJECT CONTROL MONUMENTATION

**RIGHT OF WAY
PLANS**

CENTERLINE COORDINATE DATA

KY 146 RELOCATION

	PROJECT COORDINATES	
	NORTH (Y)	EAST (X)
P.O.B. STA. 97+36.11	4052550.76	5051457.53
P.I. STA. 100+00.00	4052651.66	5051701.37
P.C. STA. 100+51.20	4052663.15	5051751.27
P.I. STA. 102+61.67	4052710.37	5051956.37
P.T. STA. 104+70.46	4052712.04	5052166.83
P.C. STA. 111+35.91	4052717.33	5052832.26
P.I. STA. 114+11.21	4052719.52	5053107.55
P.T. STA. 116+85.21	4052767.70	5053378.59
P.C. STA. 124+67.79	4052904.67	5054149.10
P.I. STA. 128+51.95	4052971.91	5054527.33
P.T. STA. 131+99.00	4052760.80	5054848.29
P.C. STA. 138+37.51	4052409.92	5055381.75
P.I. STA. 146+78.81	4051947.60	5056084.64
P.T. STA. 153+13.26	4052435.05	5056770.33
P.C. STA. 163+67.64	4053045.97	5057629.70
P.I. STA. 169+47.36	4053381.86	5058102.20
P.T. STA. 174+11.71	4053122.45	5058620.64
P.C. STA. 184+13.90	4052673.99	5059516.89
P.I. STA. 186+49.66	4052568.49	5059727.73
P.T. STA. 188+85.17	4052480.24	5059946.35
P.C. STA. 194+30.95	4052275.95	5060452.46
P.I. STA. 198+83.54	4052106.53	5060872.15
P.T. STA. 203+34.93	4051991.39	5061309.85
P.C. STA. 205+47.03	4051937.43	5061514.97
P.I. STA. 208+86.51	4051851.07	5061843.28
P.T. STA. 212+14.44	4051630.25	5062101.13
P.C. STA. 218+07.98	4051244.19	5062551.95
P.I. STA. 221+44.01	4051025.61	5062807.18
P.T. STA. 224+78.45	4050853.05	5063095.52
P.C. STA. 233+53.29	4050403.78	5063846.20
P.I. STA. 235+59.65	4050297.81	5064023.27
P.T. STA. 237+65.96	4050184.69	5064195.86
P.C. STA. 245+51.40	4049754.15	5064852.79
P.I. STA. 247+17.71	4049662.99	5064991.89
P.T. STA. 248+83.99	4049576.45	5065133.91

CENTERLINE COORDINATE DATA

KY 146 RELOCATION

	PROJECT COORDINATES	
	NORTH (Y)	EAST (X)
P.C. STA. 253+17.89	5065504.45	5502625.75
P.I. STA. 254+48.54	5065616.03	5502936.54
P.T. STA. 255+79.15	5065724.46	5502985.79
P.C. STA. 268+91.95	5066814.05	5503035.92
P.I. STA. 273+63.35	5067205.30	5503214.05
P.T. STA. 277+68.95	5067238.39	5503275.59
P.C. STA. 279+88.84	5067253.83	5503308.44
P.I. STA. 284+80.06	5067288.31	5503347.01
P.T. STA. 289+31.61	5067627.95	5503398.82
P.C. STA. 301+27.95	5068455.13	5503435.00
P.I. STA. 303+35.48	5068598.63	5503510.81
P.T. STA. 305+42.29	5068718.89	5504324.79
P.C. STA. 311+87.36	5069092.69	5504396.81
P.I. STA. 314+94.54	5069270.69	5504434.06
P.T. STA. 317+82.15	5069560.66	5504452.43
P.C. STA. 322+92.70	5070042.61	5504474.83
P.I. STA. 327+59.25	5070483.01	5504512.92
P.T. STA. 332+07.88	5070944.81	5504591.25
P.C. STA. 335+28.87	5071262.54	5504972.46
P.I. STA. 337+36.71	5071468.26	5505062.01
P.T. STA. 339+41.84	5071674.17	5505104.46
P.C. STA. 341+86.09	5071916.16	5505374.56
P.I. STA. 344+28.82	5072156.64	5505440.93
P.T. STA. 346+67.26	5072395.05	5505457.18
P.O.E. STA. 370+39.86	5074725.43	5505480.85

**RIGHT OF WAY
PLANS**

CENTERLINE COORDINATE DATA		
CONNECTOR NO. 1		
	PROJECT COORDINATES	
	NORTH (Y)	EAST (X)
P.O.B. STA. 5 + 98.15	4053091.32	5053557.31
P.C. STA. 7 + 32.65	4053008.61	5053451.25
P.I. STA. 8 + 61.56	4052929.33	5053349.60
P.T. STA. 9 + 64.70	4052802.41	5053372.16
P.O.E. STA. 10 + 00.00	4052767.66	5053378.34

CENTERLINE COORDINATE DATA		
DAWKINS LANE		
	PROJECT COORDINATES	
	NORTH (Y)	EAST (X)
P.O.B. STA. 7 + 87.50	4053195.01	5058937.87
P.C. STA. 8 + 61.84	4053121.23	5058928.69
P.I. STA. 8 + 98.59	4053084.77	5058924.15
P.T. STA. 9 + 34.63	4053051.90	5058907.71
P.O.E. STA. 10 + 00.00	4052993.44	5058878.45

CENTERLINE COORDINATE DATA		
ROSE HILL LANE		
	PROJECT COORDINATES	
	NORTH (Y)	EAST (X)
P.O.B. STA. 7 + 03.22	4052520.71	5055785.66
P.C. STA. 7 + 84.70	4052444.76	5055815.14
P.I. STA. 8 + 48.10	4052385.65	5055838.09
P.T. STA. 9 + 07.98	4052323.59	5055825.13
P.O.E. STA. 10 + 00.00	4052233.51	5055806.33

CENTERLINE COORDINATE DATA		
BROKO LANE		
	PROJECT COORDINATES	
	NORTH (Y)	EAST (X)
P.O.B. STA. 8 + 00.00	4049447.05	5065727.55
P.O.E. STA. 10 + 00.00	4049278.71	5065619.56

CENTERLINE COORDINATE DATA		
CONNECTOR NO. 2		
	PROJECT COORDINATES	
	NORTH (Y)	EAST (X)
P.O.B. STA. 10 + 00.00	4052373.77	5056675.14
P.C. STA. 10 + 24.85	4052352.28	5056687.61
P.I. STA. 10 + 93.98	4052292.50	5056722.31
P.C.C. STA. 11 + 45.82	4052303.83	5056790.50
P.I. STA. 12 + 24.99	4052316.82	5056868.60
P.T. STA. 13 + 03.98	4052339.18	5056944.56
P.O.E. STA. 13 + 37.16	4052348.56	5056976.39

CENTERLINE COORDINATE DATA		
HIEATT LANE		
	PROJECT COORDINATES	
	NORTH (Y)	EAST (X)
P.O.B. STA. 10 + 00.00	4044473.48	5069977.76
P.C. STA. 10 + 17.58	4044456.88	5069971.95
P.I. STA. 10 + 62.88	4044414.12	5069957.00
P.T. STA. 11 + 00.82	4044377.87	5069984.16
P.O.E. STA. 11 + 01.36	4044377.44	5069984.49